

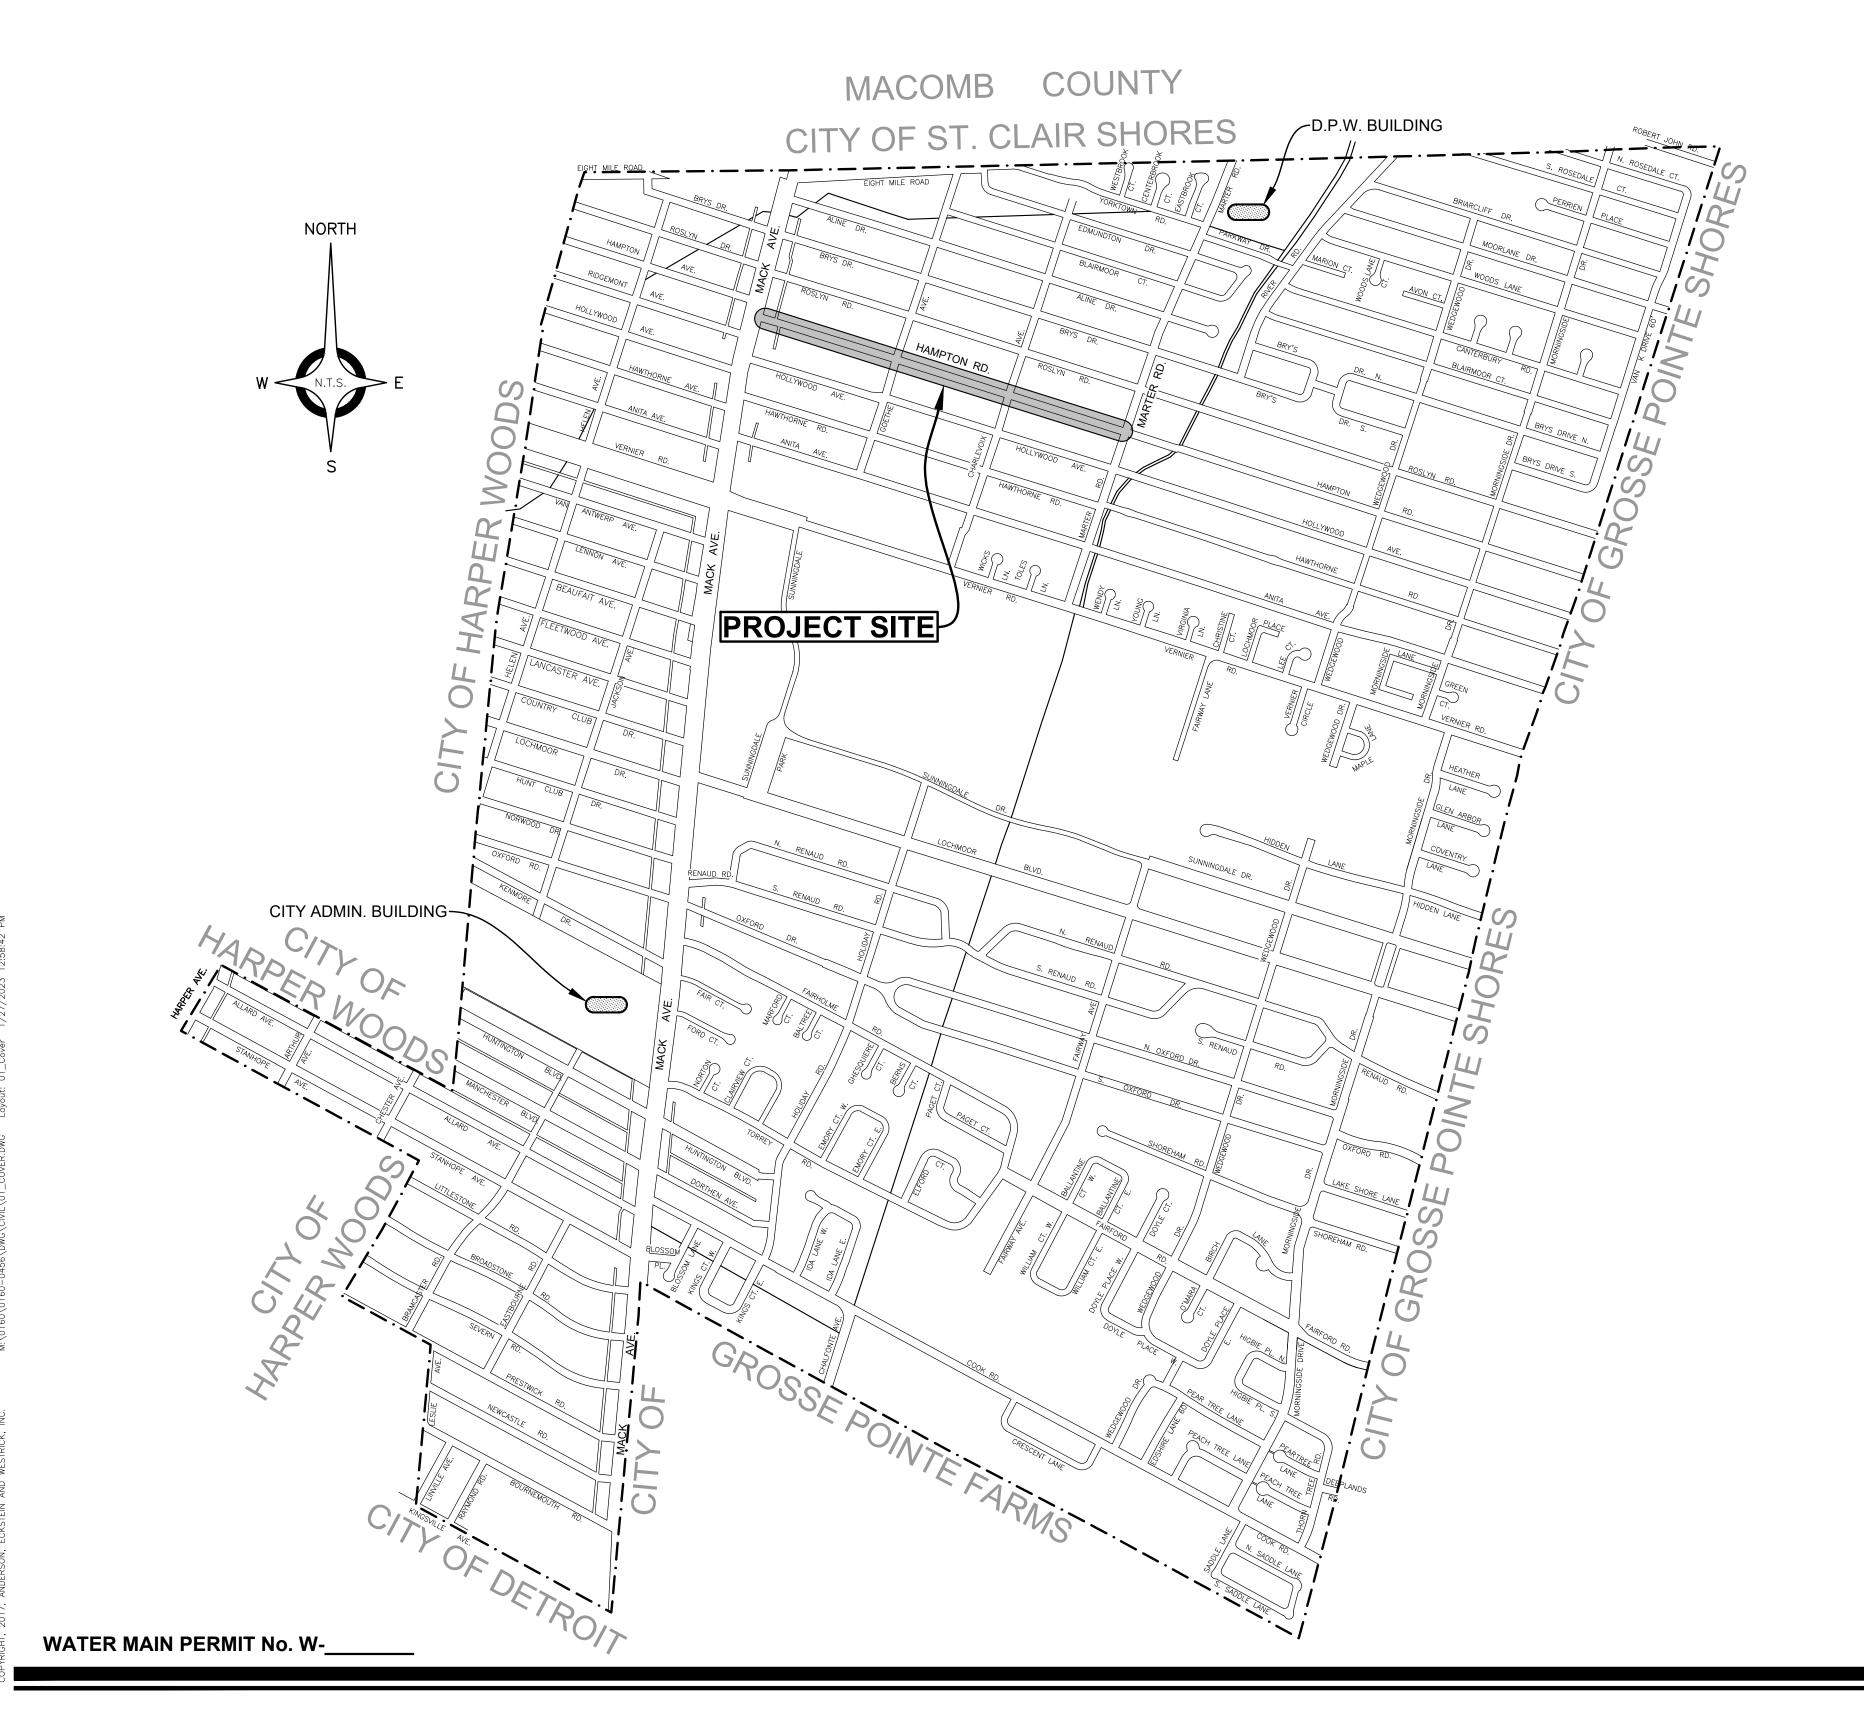
# City of Grosse Pointe Woods



# Wayne County, Michigan

# Hampton Road Water Main & Resurfacing

Mack Avenue to Marter Road



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#### CITY OF GROSSE POINTE WOODS STD. DETAILS

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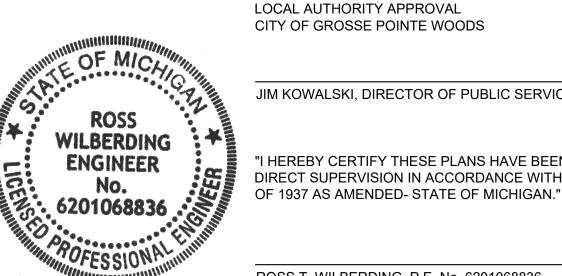
#### **DESIGN & CONSTRUCTION STANDARD**

THE IMPROVEMENTS COVERED BY THESE PLANS SHALL BE PERFORMED IN ACCORDANCE WITH THE MICHIGAN DEPARTMENT OF TRANSPORTATION 2020 STANDARD SPECIFICATIONS FOR CONSTRUCTION AND THE CITY OF GROSSE POINTE WOODS STANDARD SPECIFICATIONS UNLESS MODIFIED BY A SPECIAL

ALL TRAFFIC CONTROL DEVICES SUCH AS LIGHTED ARROW BOARDS, PLASTIC DRUMS, BARRICADES, TEMPORARY SIGNAGE, AND LANE CLOSURES SHALL BE IMPLEMENTED IN ACCORDANCE WITH THE 2011 MICHIGAN MANUAL OF UNIFORM TRAFFIC CONTROL DEVICES AND THE SUPPLEMENTARY MAINTAINING TRAFFIC SPECIAL PROVISION.

#### **PROJECT DESCRIPTION**

THE PROJECT CONSISTS OF 0.6 MILES OF WATER MAIN REPLACEMENT BY PIPE BURSTING AND ROAD RESURFACING. THE RESURFACING WORK INVOLVES HMA MILLING AND RESURFACING ALONG THE ENTIRE ROAD WIDTH ALONG WITH STORM DRAINAGE REPLACEMENT. THE ROAD WORK INCLUDES NEW CONCRETE CURB AND GUTTER AND DRIVE APPROACHES ALONG THE SOUTH SIDE OF THE ROAD. THE PROJECT ALSO INCLUDES SIDEWALK RAMP RECONSTRUCTION, AND OTHER MISCELLANEOUS RELATED ITEMS OF WORK.



LOCAL AUTHORITY APPROVAL CITY OF GROSSE POINTE WOODS

JIM KOWALSKI, DIRECTOR OF PUBLIC SERVICES

'I HEREBY CERTIFY THESE PLANS HAVE BEEN PREPARED UNDER MY DIRECT SUPERVISION IN ACCORDANCE WITH ACT 240, PUBLIC ACTS

ROSS T. WILBERDING, P.E. No. 6201068836

1/31/2023 DATE

# **GENERAL NOTES**

#### UTILITIES

#### MISS DIG/UNDERGROUND UTILITY NOTIFICATION

For the protection of underground utilities and in conformance with Public Act 174 of 2013, the Contractor shall contact MISS DIG System, Inc. by phone at 811 or 800-482-7171 or via the web at either elocate.missdig.org for single address or rte.missdig.org, a minimum of 3 work days prior to excavating, excluding weekends and holidays.

#### **ROW / REAL ESTATE**

#### LAWN SPRINKLER SYSTEMS AND LANDSCAPING

Owners of existing lawn sprinkler systems and/or landscaping shall be notified in advance of any work to be done that will affect those systems and/or landscaping. If the property owner fails to relocate the lawn sprinkler system prior to the Contractor beginning work, the Contractor shall carefully salvage the landscaping items and stockpile them on the property owner's property for the property owner. If the Contractor cuts the system during the construction, the Contractor shall cap the system pipe and witness the location of the cap with a wooden stake.

#### **SURVEY**

#### **ADJUSTING MONUMENT BOXES**

All government corners on this project shall be preserved, whether shown or not. It may be necessary to place or adjust monument boxes, as required.

#### **DRAINAGE**

#### ILLICIT CONNECTIONS TO STORM WATER SYSTEM

Connections to existing storm conveyance systems not shown on the plans must be reconnected with minimal interruption in service. Size, type and location by station and offset of any suspect illicit discharge observed shall be reported to the Engineer prior to reconnecting. Contractor shall proceed as directed by the Engineer.

#### **TEMPORARY BULKHEADS**

Temporary bulkheads may be required for the part width construction of the sewers. All costs associated with constructing temporary bulkheads are included in the unit prices bid for the storm sewer items of work.

#### **EARTHWORK**

#### **SOIL EROSION MEASURES**

Appropriate soil erosion and sedimentation control measures shall be in place prior to earth-disturbing activities. Place turf establishment items as soon as possible on potential erodable slopes as directed by the Engineer.

#### **BASES**

#### **AGGREGATE BASE**

Aggregate bases shall be 21AA in accordance with the MDOT 2020 Standard Specifications for Construction.

#### **PAVEMENT**

#### SOIL BORINGS AND/OR PAVEMENT CORES

The soil boring logs and/or pavement cores represent point information. No inference should be made that subsurface or pavement conditions are the same at other locations.

#### CONCRETE

The type of concrete to be used on this project is Type P1.

#### **LANDSCAPING**

All equipment to be used must be approved by the Engineer prior to beginning work.

Storage of equipment and materials will be restricted to areas designated by the Owner.

Branches of all trees to be saved shall not be removed, or damaged by construction equipment. If removal of lower branches is necessary, contact DPW for proper methods.

Contractor shall promptly restore any property damage at no expense to the

All excavated material will become the property of the Contractor. Any excavated material not used on the project shall be removed from the site and disposed of in accordance with Section 205.03.P. of the 2020 Standard Specification for Construction and any applicable state and/or local ordinances.

No cereal rye seeding shall be used on this project.

#### **SIGNS**

#### **GENERAL**

All signs shall be installed, removed and/or salvaged according to the current edition of "Michigan Manual on Uniform Traffic Control Devices" and the current edition of Michigan Department of Transportation (MDOT) "Standard Specifications for Construction."

All signs on the plans or in the log that do not have a recommendation are to be retained.

#### **EXISTING SIGN RELOCATION**

Any permanent signs requiring relocation due to Contractor operations shall be salvaged and reset by the Contractor at locations designated by the Engineer. Signs and posts damaged during the removal and storage operations shall be replaced with new signs and posts. The cost of this work shall be borne by the Contractor.

#### NOTES APPLYING TO STANDARD PLANS

Where the following items are called for on plans, they are to be constructed according to the standard plan series given below opposite each item unless otherwise indicated.

Title	Plan Series
ROAD	
DRAINAGE STRUCTURES	R-1*
SIDEWALK RAMP AND DETECTABLE WARNING DETAILS	R-28*
DRIVEWAY OPENINGS & APPROACHES AND CONCRETE	R-29
SIDEWALK	N-23
CONCRETE CURB AND CONCRETE CURB & GUTTER	R-30
GRANULAR BLANKET, UNDERDRAINS, OUTLET ENDINGS FOR	R-80
UNDERDRAINS, AND SEWER BULKHEADS	r\-00
UTILITY TRENCHES	R-83
SOIL EROSION & SEDIMENTATION CONTROL MEASURES	R-96
* Denotes Special Detail	

#### **PUBLIC UTILITIES**

The existing utilities listed below and locations of utilities as shown on the plans represent the best information available at the time these plans were prepared. This information does not relieve the contractor of the responsibility to satisfy himself as to their accuracy or of his responsibility to verify all existing utilities within the C.I.A. In case utilities have been constructed or removed since the topographic survey was prepared.

NAME OF OWNER

UTILITY

**POWER & ELECTRIC** 

**DETROIT EDISON CO.** ONE ENERGY PLAZA

(313)235-4432

DETROIT, MI 48226

D.T.E. COMMUNITY LIGHTING

STREET LIGHTS

GAS

**TELEPHONE & OTHER** 

COMMUNICATION

**SYSTEMS** 

DEBRA CAIN (313)618-6996

TOM KOCH

2045 WEB

D.T.E. GAS COMPANY

LAURIE FORRESTER 17150 ALLEN ROAD MELVINDALE, MICHIGAN 48122 (313)389-7261

A.T.&T.

**ENGINEERING DEPARTMENT** 100 S. MAIN ST., SUITE 314 MT. CLEMENS, MICHIGAN 48043

(586) 466-1024

**COMCAST CABLE CABLE TV** 

WARREN SETTY 6095 WALL STREET STERLING HEIGHTS, MICHIGAN 48312 (586) 883-7253

WAYNE COUNTY DEPARTMENT

OF SERVICES PETE MILENKOVICH 29900 GODDARD ROAD **DETROIT, MICHIGAN 48241** 

(734) 955-2154

48236

CITY OF GROSSE POINTE WOODS

DEPARTMENT OF PUBLIC WORKS JIM KOWALSKI 1200 PARKWAY GROSSE POINTE WOODS, MICHIGAN

WATER / SEWER

TRAFFIC SIGNALS

**RESURFACING** 

(MACK AVE. TO MARTER RD.)

HAMPTON ROAD

**WATER MAIN &** 

SUBMITTALS/REVISIONS

ANDERSON, ECKSTEIN AND

WESTRICK, INC.

CIVIL ENGINEERS SURVEYORS ARCHITECTS

www.aewinc.com

**ENGINEERING STRONG COMMUNITIES** 

51301 Schoenherr Road

Shelby Township

Michigan 48315

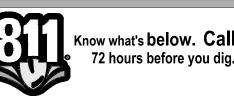
Phone 586 726 1234

SHEET TITLE

**NOTE SHEET** 

CITY OF GROSSE POINTE WOODS

AUGUST 2022



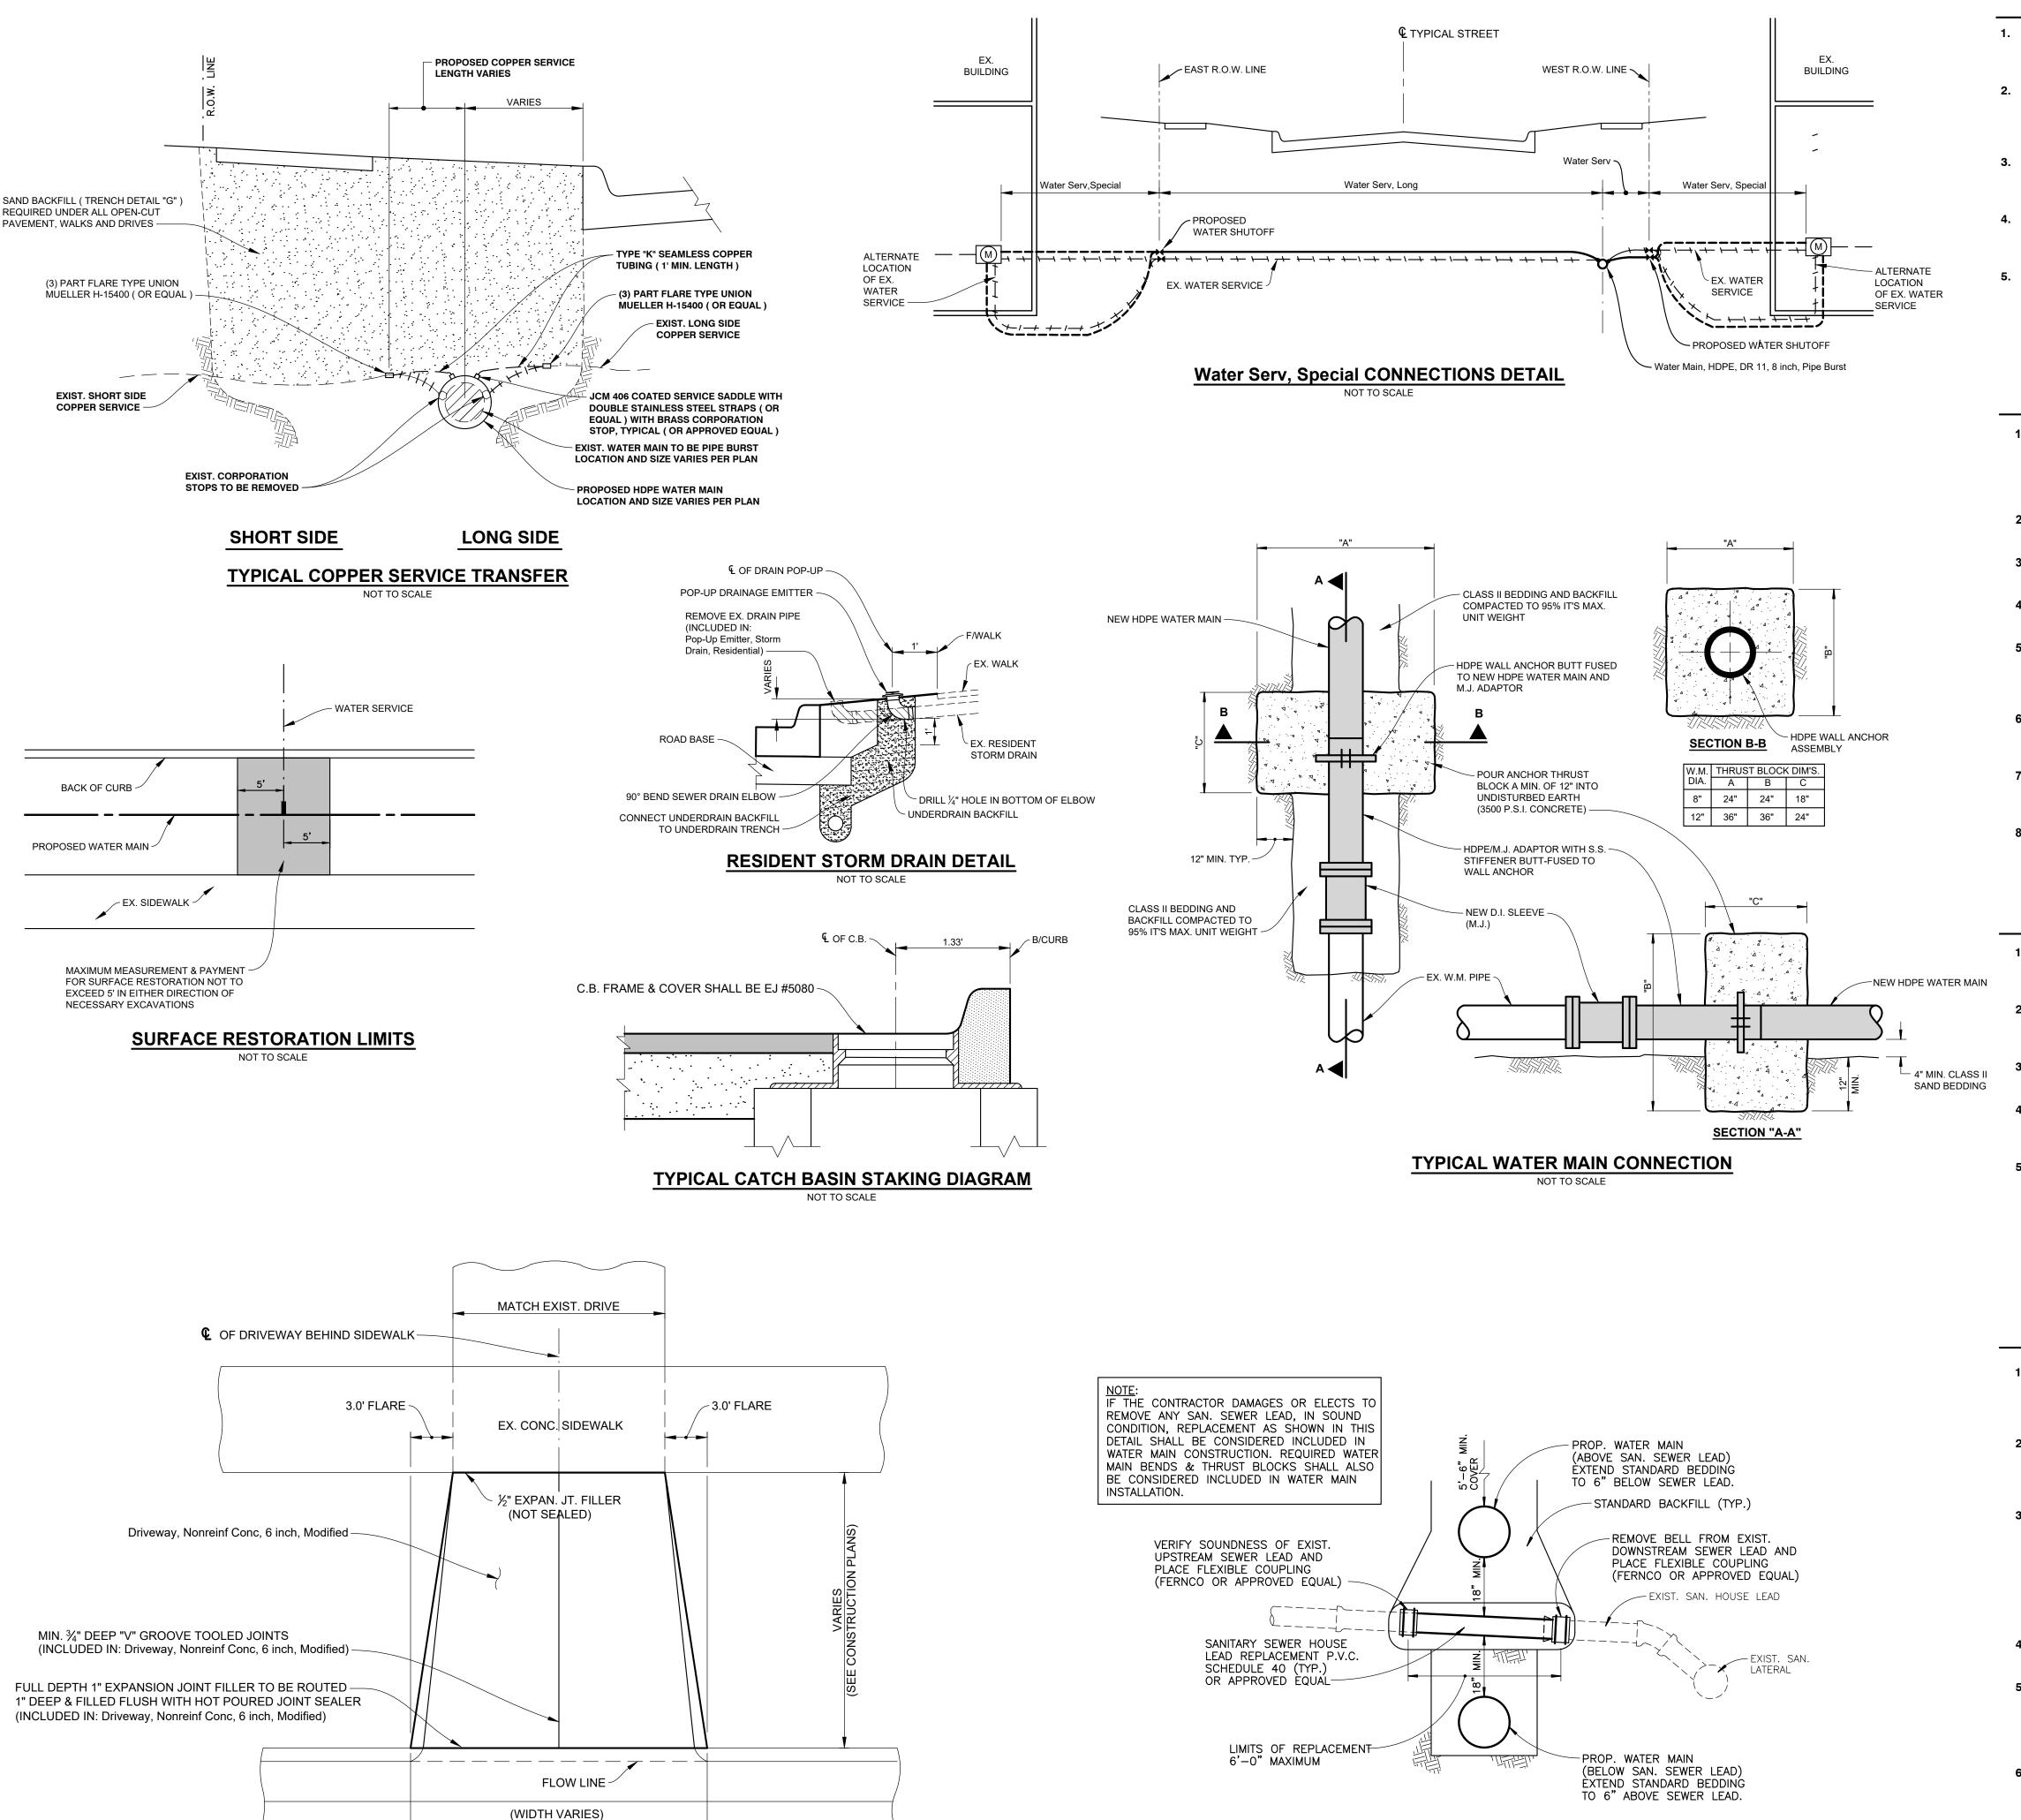
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DURING CONSTRUCTION, THE CONTRACTOR SHALL USE EXTREME CAUTION WHEN OPERATING NEAR ANY AND ALL OVERHEAD AND / OR BURIED UTILITIES.

PROJECT NO. 0160-0456

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TYPICAL SANITARY SEWER HOUSE LEAD REPAIR

CONCRETE DRIVEWAY OPENING, DETAIL "L"

TYPICAL FLARED DRIVE APPROACH

#### **GENERAL HDPE WATER MAIN NOTES**

- 1. ALL DUCTILE IRON BENDS AND FITTINGS REQUIRE JOINT RESTRAINTS AND CONCRETE THRUST BLOCKS AND SHALL BE INCLUDED IN THE UNIT PRICES BID FOR THE RELATED WATER MAIN ITEMS OF WORK.
- 2. ALL 5/8" WATER SERVICE TRANSFERS SHALL BE COMPLETED WITH A 3/4" JCM 406 COATED SERVICE SADDLE WITH DOUBLE STAINLESS STEEL STRAPS, 3/4" BRASS CORPORATION STOP, 3/4" COPPER AND A 3/4" X 5/8" FLARE UNION, AS SHOWN IN THE TYPICAL SERVICE CONNECTION DETAILS.
- 3. ALL EXCAVATION AND PLACEMENT OF BENDS REQUIRED TO AVOID CONFLICTS WITH EXISTING UTILITIES SHALL BE INCLUDED IN THE UNIT PRICES BID FOR THE RELATED WATER MAIN ITEMS OF WORK.
- 4. CONTINUOUS, UNBROKEN, TRACER WIRE(S) SHALL BE PROVIDED THROUGHOUT THE ENTIRE LENGTH OF THE NEW WATER MAIN INSTALLATION, THE COST OF WHICH SHALL BE INCLUDED IN THE UNIT PRICES BID FOR THE RELATED WATER MAIN ITEMS OF WORK.
- THE CONTRACTOR SHALL BE RESPONSIBLE FOR PROVIDING A TEMPORARY WATER MAIN AS WELL AS TEMPORARY WATER SERVICES TO ALL BUILDINGS THAT ARE TO BE TAKEN OUT OF SERVICE DUE TO THIS PROJECT. AT THE PRE-CONSTRUCTION MEETING THE CONTRACTOR SHALL PROPOSE, IN WRITING, WHAT METHODS AND MATERIALS HE INTENDS TO USE TO PROVIDE TEMPORARY WATER SERVICE FOR THIS PROJECT. THE CONTRACTOR'S PROPOSED METHODS AND MATERIALS SHALL BE SUBJECT TO REVIEW AND APPROVAL OF THE ENGINEER. PAYMENT FOR TEMPORARY WATER SERVICE SHALL BE AT THE CONTRACT LUMP SUM AMOUNT.

#### **GENERAL PIPE BURSTING NOTES**

- 1. ALL DRIVEWAY, SIDEWALK AND CONCRETE PAVEMENT SHOWN FOR REMOVAL AND REPLACEMENT ARE ANTICIPATED FOR CONSTRUCTION ACTIVITIES. THE CONTRACTOR SHALL MAKE EVERY EFFORT TO IMPLEMENT CONSTRUCTION TECHNIQUES OR PRACTICES WHICH MAY REDUCE OR ELIMINATE THESE DISTURBANCES.
- 2. TREES SHALL BE REMOVED ONLY AS NECESSARY. PRIOR TO REMOVING ANY TREE,
  THE CONTRACTOR SHALL CONTACT THE CITY FOR APPROVAL.
- 3. PRIOR TO CONSTRUCTION, THE CONTRACTOR SHALL VERIFY THE LOCATION OF ALL
- 4. CONTRACTOR SHALL EXPOSE THE SANITARY LEADS AT ALL WATER MAIN CROSSING PRIOR TO PIPE BURSTING OPERATIONS.

OVERHEAD AND BURIED UTILITIES.

- 5. ALL CONCRETE PAVEMENT REMOVED SHALL BE SAWCUT FULL DEPTH ALONG THE REMOVAL LIMITS. CONCRETE REMOVAL LIMITS SHOWN ON THE PLANS ARE APPROXIMATE ONLY. ACTUAL REMOVAL LIMITS SHALL BE DETERMINED BY THE ENGINEER IN THE FIELD.
- 6. SIDEWALK CROSSING DRIVE APPROACHES, DRIVE APPROACHES AND PAVEMENT AREAS NOT IMMEDIATELY RESTORED SHALL BE TEMPORARILY MAINTAINED WITH 6" MINIMUM 21AA CRUSHED CONCRETE. ("MAINTENANCE GRAVEL")
- 7. ALL STREETS, SIDEWALKS AND DRIVE APPROACHES LOCATED WITHIN THE CONSTRUCTION INFLUENCE AREA SHALL BE CLEANED AND MAINTAINED DAILY, THE COST OF WHICH SHALL BE INCLUDED IN THE PROJECT.
- 8. ALL SIGNS TEMPORARILY REMOVED FOR CONSTRUCTION SHALL BE SALVAGED AND REPLACED. (INCLUDED IN UNIT PRICES BID FOR RELATED WATER MAIN ITEMS OF WORK.) DAMAGED SIGNS SHALL BE REPLACED BY THE CONTRACTOR AT NO ADDITIONAL COST.

# NOTES RELATED TO MAKING FINAL CONNECTIONS TO EXISTING WATER MAINS

- 1. HDPE WATER MAIN AND D.I. WATER MAIN SHALL NOT BE PAID FOR SEPARATELY. PIPE REMOVAL, FITTINGS, RETAINERS AND BACKFILL ASSOCIATED WITH MAKING THE FINAL CONNECTIONS SHALL BE INCLUDED IN THE CONNECTION.
- 2. WATER MAIN CONSTRUCTION MATERIALS, THRUST BLOCKS AND RETAINER, GLANDS, SHALL CONFORM TO THE CURRENT STANDARDS AND SPECIFICATIONS OF THE CITY OF GROSSE POINT WOODS (SEE STANDARD DETAIL SHEET).
- 3. ALL EXISTING WATER MAINS (INCLUDING FITTINGS), TO BE REMOVED AND REPLACED AS PART OF MAKING FINAL CONNECTIONS SHALL BE INCLUDED IN THE UNIT PRICE BID
- 4. UNLESS OTHERWISE NOTED, THE CONTRACTOR SHALL ASSUME THAT ALL EXISTING WATER MAINS ENCOUNTERED ARE DUCTILE IRON OR CAST IRON. JOINTS ARE UNKNOWN
- 5. IT SHALL BE THE CONTRACTOR'S RESPONSIBILITY TO OPERATE, SHUT OFF, AND RESTORE WATER MAINS AND SERVICES AS NECESSARY DURING CONSTRUCTION. A TRIAL SHUT-DOWN OF EXISTING GATE VALVES WHICH ISOLATE THE PROPOSED CONNECTIONS SHALL BE COORDINATED WITH THE CITY AND PERFORMED PRIOR TO ANY SCHEDULED CONNECTION. THE CITY OF GROSSE POINTE WOODS DEPARTMENT OF PUBLIC WORKS WILL REQUIRE (48) HOURS NOTICE FOR SHUT-DOWN SCHEDULES. ANY DELAYS ASSOCIATED WITH OBTAINING A SHUT-DOWN SHALL NOT BE RECOGNIZED AS CAUSE FOR EXTRA COMPENSATION. IT SHALL BE THE CONTRACTOR'S RESPONSIBILITY TO NOTIFY AFFECTED RESIDENTS, BUSINESSES AND DESIGNATED CITY DEPARTMENTS A MIN. OF 24 HOURS PRIOR TO ANY SCHEDULED WATER MAIN

#### WATER SERVICE CONSTRUCTION NOTES

- 1. THE CONTRACTOR SHALL BE RESPONSIBLE FOR LABOR, MATERIALS, EXCAVATION (
  INCLUDING BORES), INSTALLATION, BACKFILL AND RESTORATION OF ALL SERVICES
  TRANSFERRED OR REPLACED (AS REQUIRED) FROM THE EXISTING TO NEW WATER
  MAIN
- COPPER SERVICE TRANSFERS BETWEEN MAINS SHALL BE COMPLETED WITH TYPE "K" COPPER, THREE PART UNION (MUELLER H-15400 OR EQUAL), BRASS CORPORATION STOP (MUELLER H-15000 OR EQUAL) AND JCM 406 COATED SERVICE SADDLE WITH DOUBLE STAINLESS STEEL STRAPS (OR EQUAL).
- MAIN TO A CONNECTION POINT (1) ONE FOOT BEYOND THE EXISTING STOP BOX LOCATION SHALL BE COMPLETED WITH A JCM 406 COATED SERVICE SADDLE WITH DOUBLE STAINLESS STEEL STRAPS (OR EQUAL), CONVENTIONAL BRASS CORPORATION STOP (MUELLER H-15000 OR EQUAL), TYPE "K" COPPER COUPLING, LEAD X COPPER TUBE/NUT MUELLER H-15506 OR FORD Q-32-33 OR EQUAL), CURB STOP (MUELLER H-15201 OR H-15200 OR EQUAL), AND ADJUSTABLE C.I. SCREW TYPE SERVICE BOX WITH FOOT PIECE.
- 4. LONG SIDE SERVICE REPLACEMENT UNDER ROADWAY SHALL BE BORED, OR JACKED ( UTILITY PERMITTING ) AND PAID FOR AT THE ESTABLISHED UNIT PRICE FOR EACH.
- 5. PRIOR TO PLACING THE NEWLY TRANSFERRED WATER SERVICE INTO SERVICE, THE CITY OF GROSSE POINTE WOODS WILL REMOVE THE EXISTING METER (IF REQUIRED) AND THOROUGHLY FLUSH THE LINE BEFORE RESETTING METER AND ACTIVATING THE SYSTEM. WORK SHALL BE PERFORMED WITH THE CONTRACTORS ASSISTANCE AND INCLUDED IN THE SERVICE TRANSFER OR REPLACEMENT.
- 6. EXISTING WATER SERVICE LOCATIONS ARE RECORDED AS STOP BOX LOCATIONS ONLY AND NOT NECESSARILY THE "TAP" POINT ON THE EXISTING WATER MAIN. IT SHALL BE THE CONTRACTORS RESPONSIBILITY TO DETERMINE THE EXACT LOCATION OF THE SERVICE BY WHATEVER MEANS OR METHODS NECESSARY, WITHOUT UNNECESSARY EXPLORATORY EXCAVATION. ANY DELAYS ASSOCIATED WITH LOCATING EXISTING SERVICES SHALL NOT BE RECOGNIZED AS CAUSE FOR EXTRA COMPENSATION.



ANDERSON, ECKSTEIN AND WESTRICK, INC.

CIVIL ENGINEERS SURVEYORS ARCHITECTS
51301 Schoenherr Road Phone 586 726 1234

Michigan 48315 www.aewinc.com

Shelby Township

ENGINEERING STRONG COMMUNITIES

Fax 586 726 8780

DATE SUBMITTALS/REVISIONS

HAMPTON ROAD
WATER MAIN &

RESURFACING (MACK AVE. TO MARTER RD.)

SHEET TITLE:

MISCELLANEOUS

DETAIL SHEET

CITY OF GROSSE POINTE WOODS

PRELIMINARY CONSTRUCTION RECORD
1/31/2023

DRAWN BY: CHECKED BY: DATE:
KJP RTW AUGUST 2022

SCALE:

AS NOTED



UTILITY INFORMATION, AS SHOWN, INDICATES APPROXIMATE LOCATIONS AND TYPES OF EXISTING FACILITIES ONLY, AS DISCLOSED BY RECORDS PROVIDED TO THIS FIRM FROM THE VARIOUS UTILITY COMPANIES. NO GUARANTEE IS GIVEN OR IMPLIED AS TO THE COMPLETENESS OR ACCURACY THEREOF.

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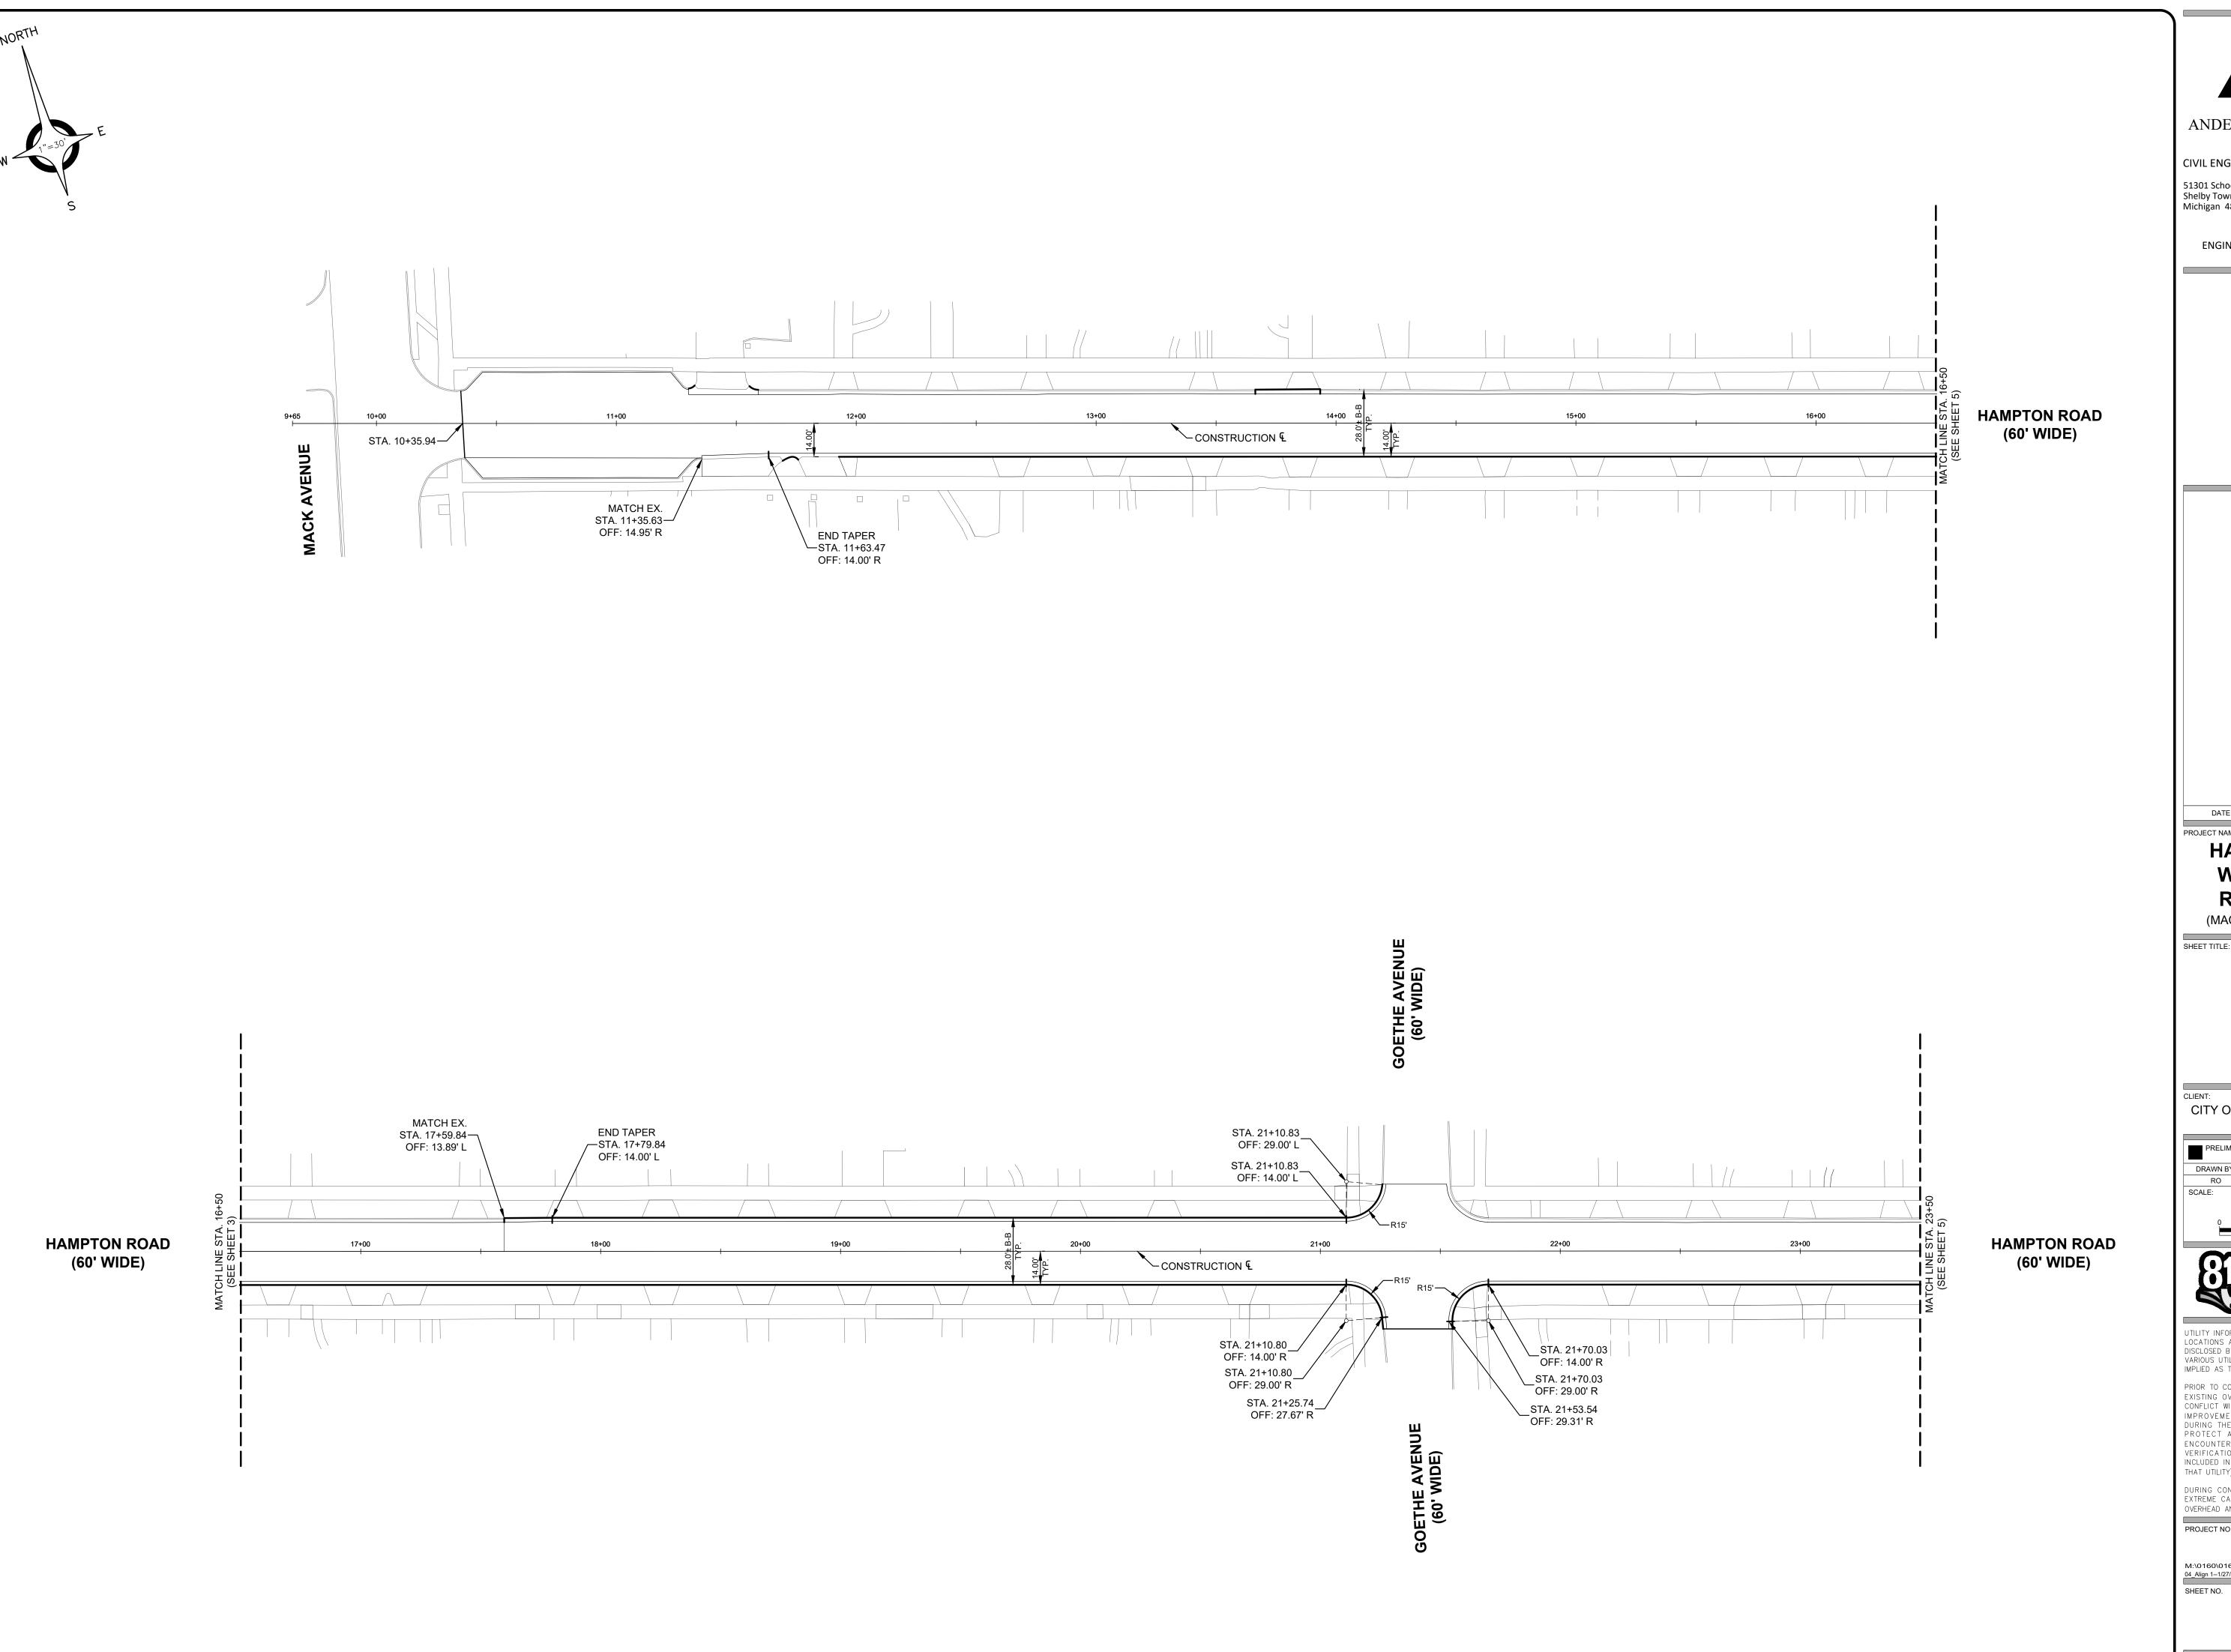
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PROJECT NO. 0160-0456

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Phone 586 726 1234 Fax 586 726 8780

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#### **HAMPTON ROAD WATER MAIN & RESURFACING**

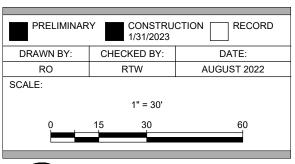
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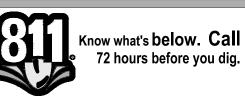
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# **ALIGNMENT** SHEET

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CITY OF GROSSE POINTE WOODS





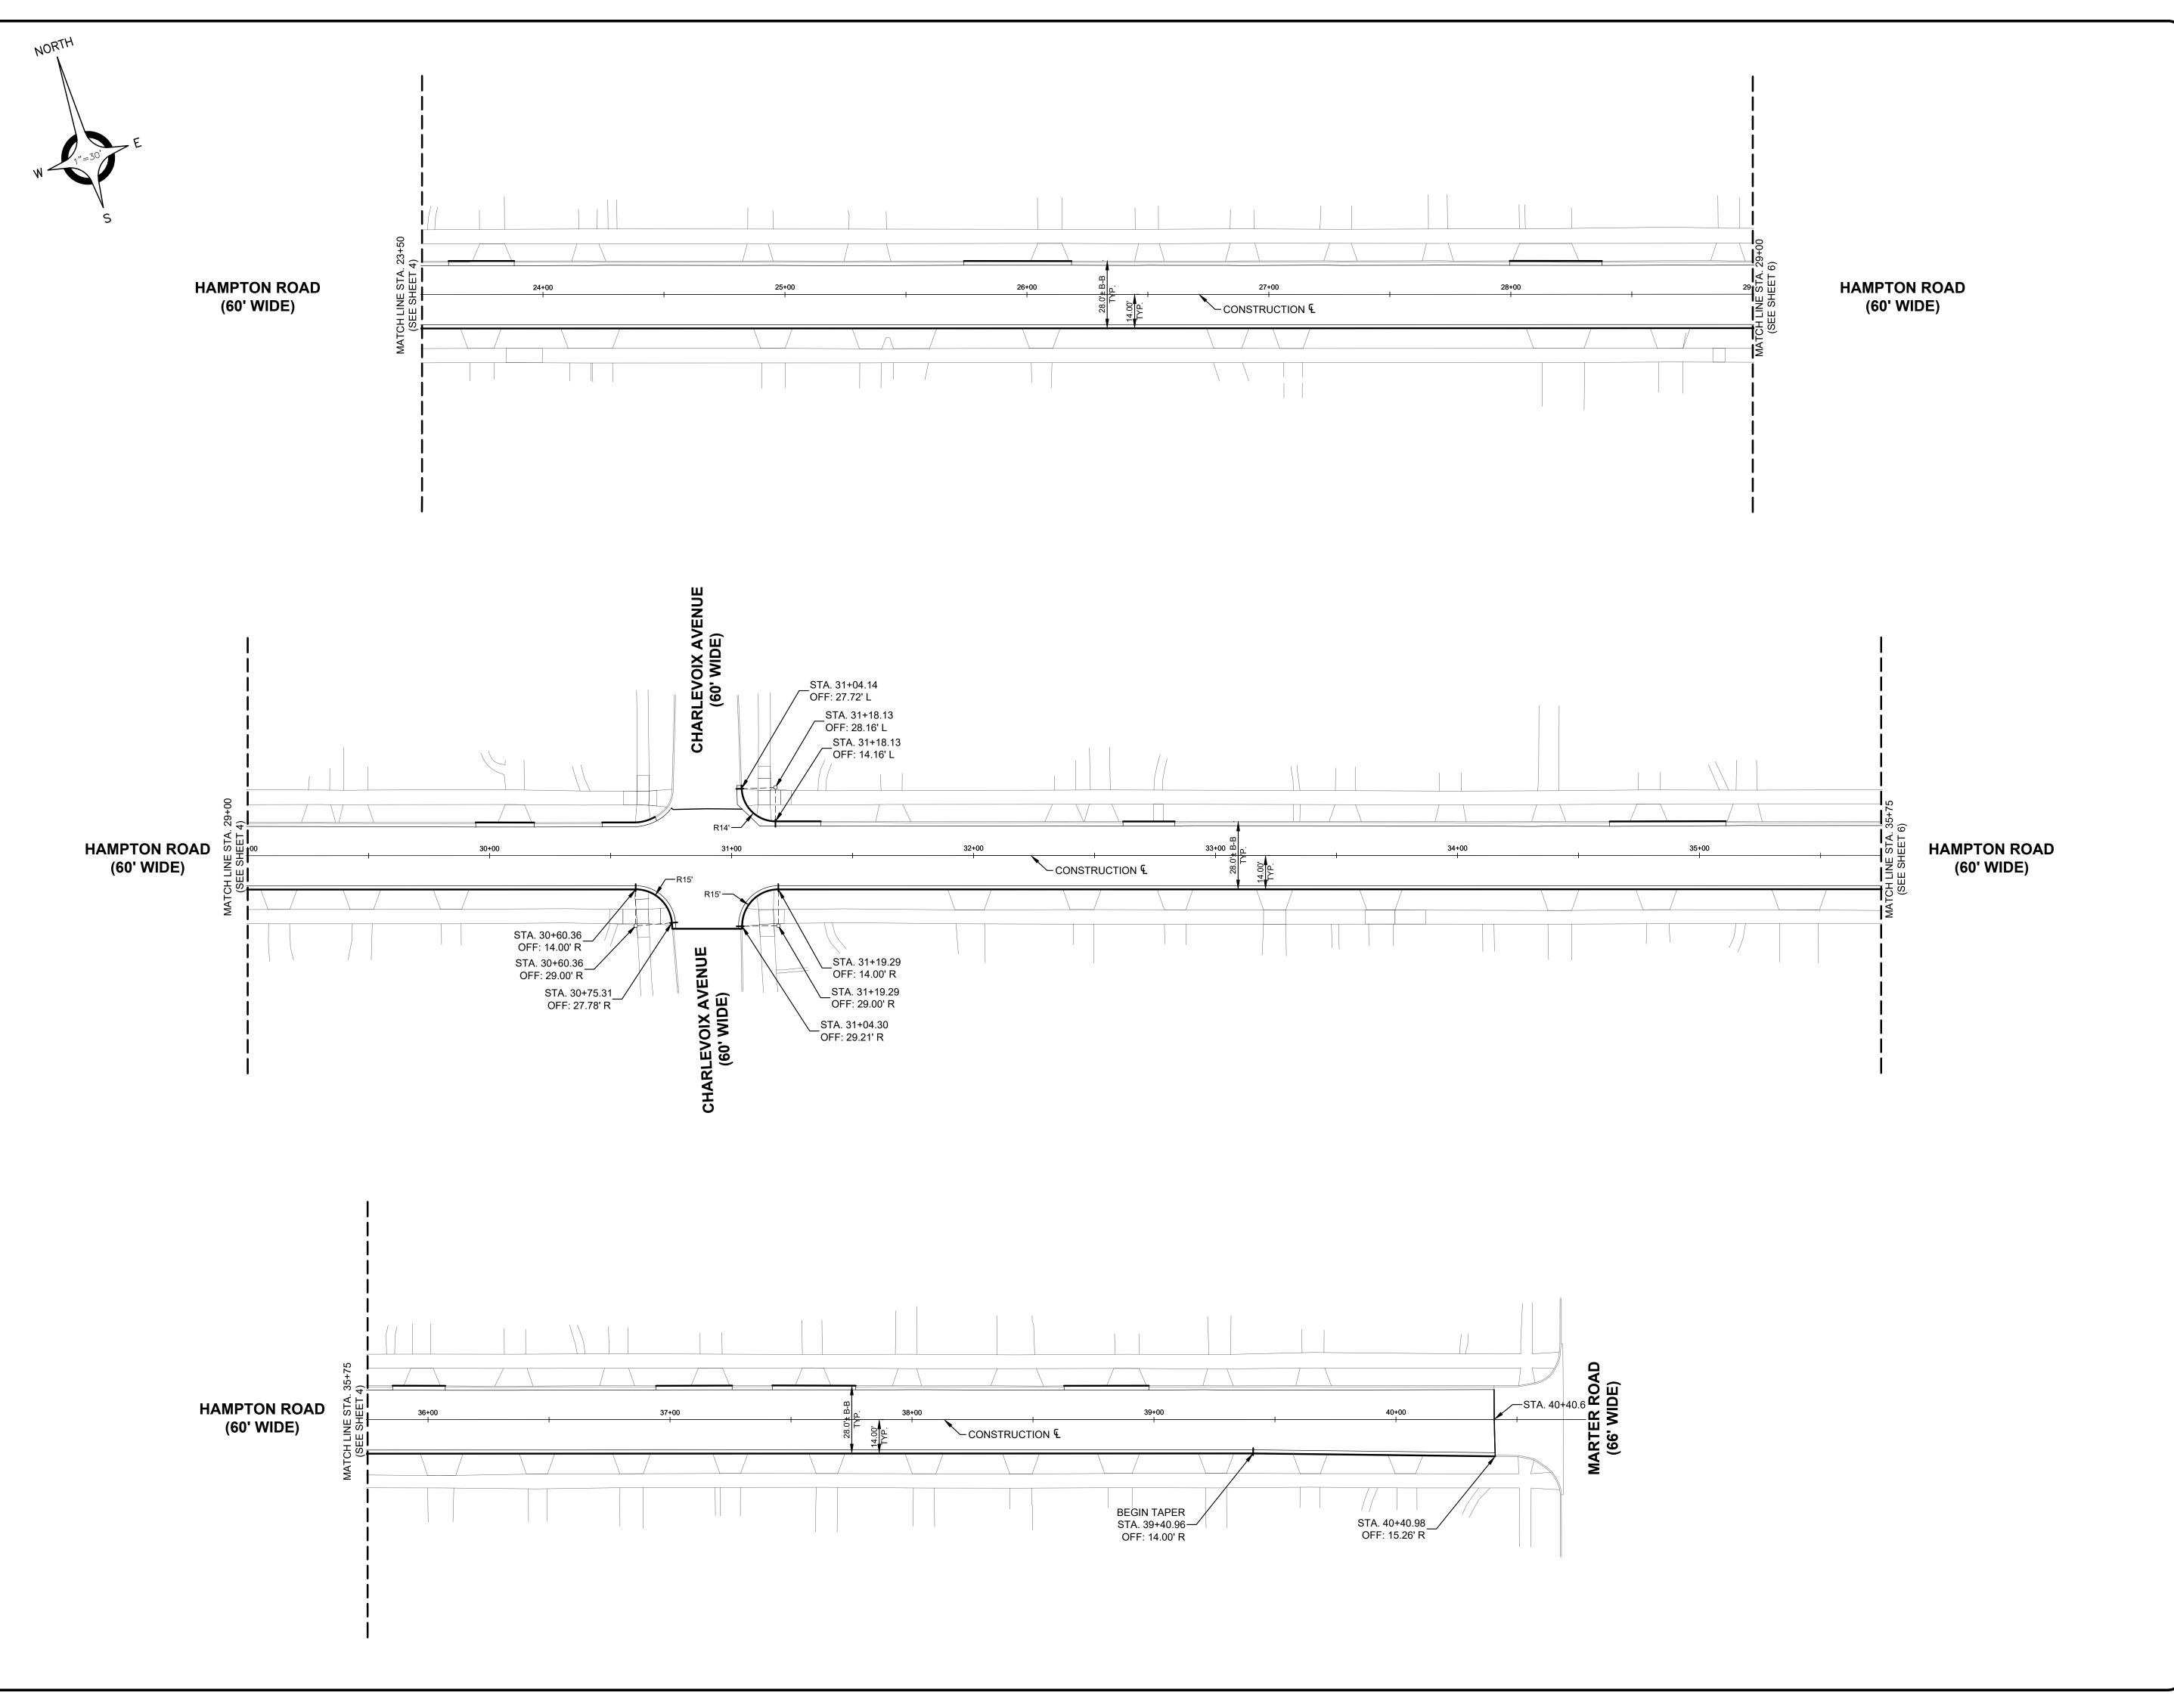
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PROJECT NO.

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DATE SUBMITTALS/REVISIONS
PROJECT NAME:

HAMPTON ROAD WATER MAIN & RESURFACING

SHEET TITLE:

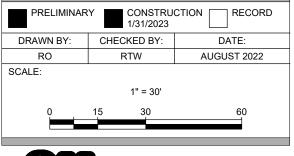
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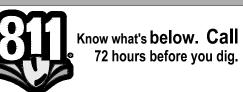
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STA. 23+50 TO MARTER ROAD

IFNT<sup>.</sup>

CITY OF GROSSE POINTE WOODS





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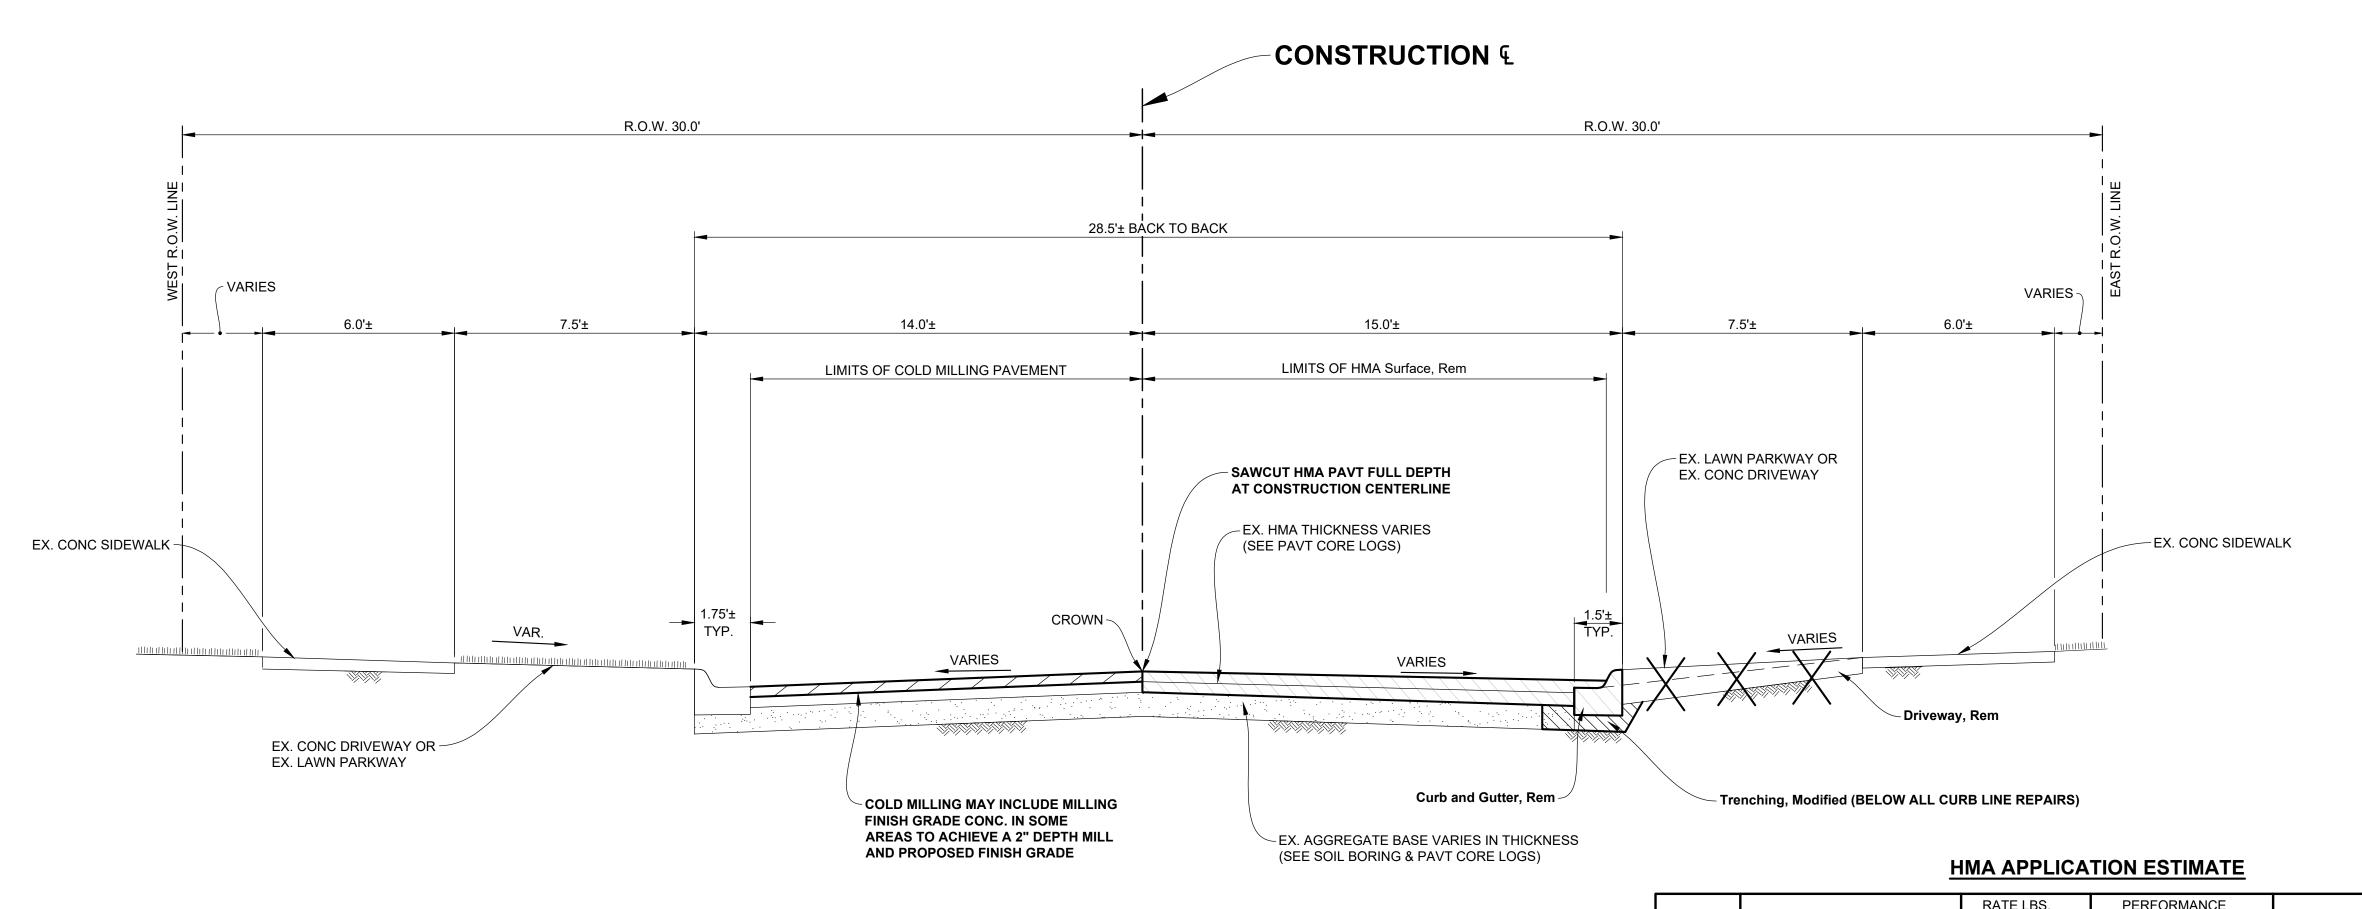
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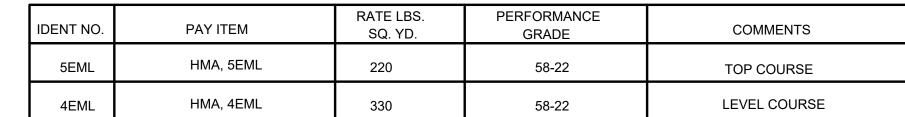


# **EXISTING PAVEMENT SECTION**

STA. 10+42+00 (P.O.B.) TO STA. 62+32.00 SCALE: 1" = 3'

PROPOSED PAVEMENT SECTION

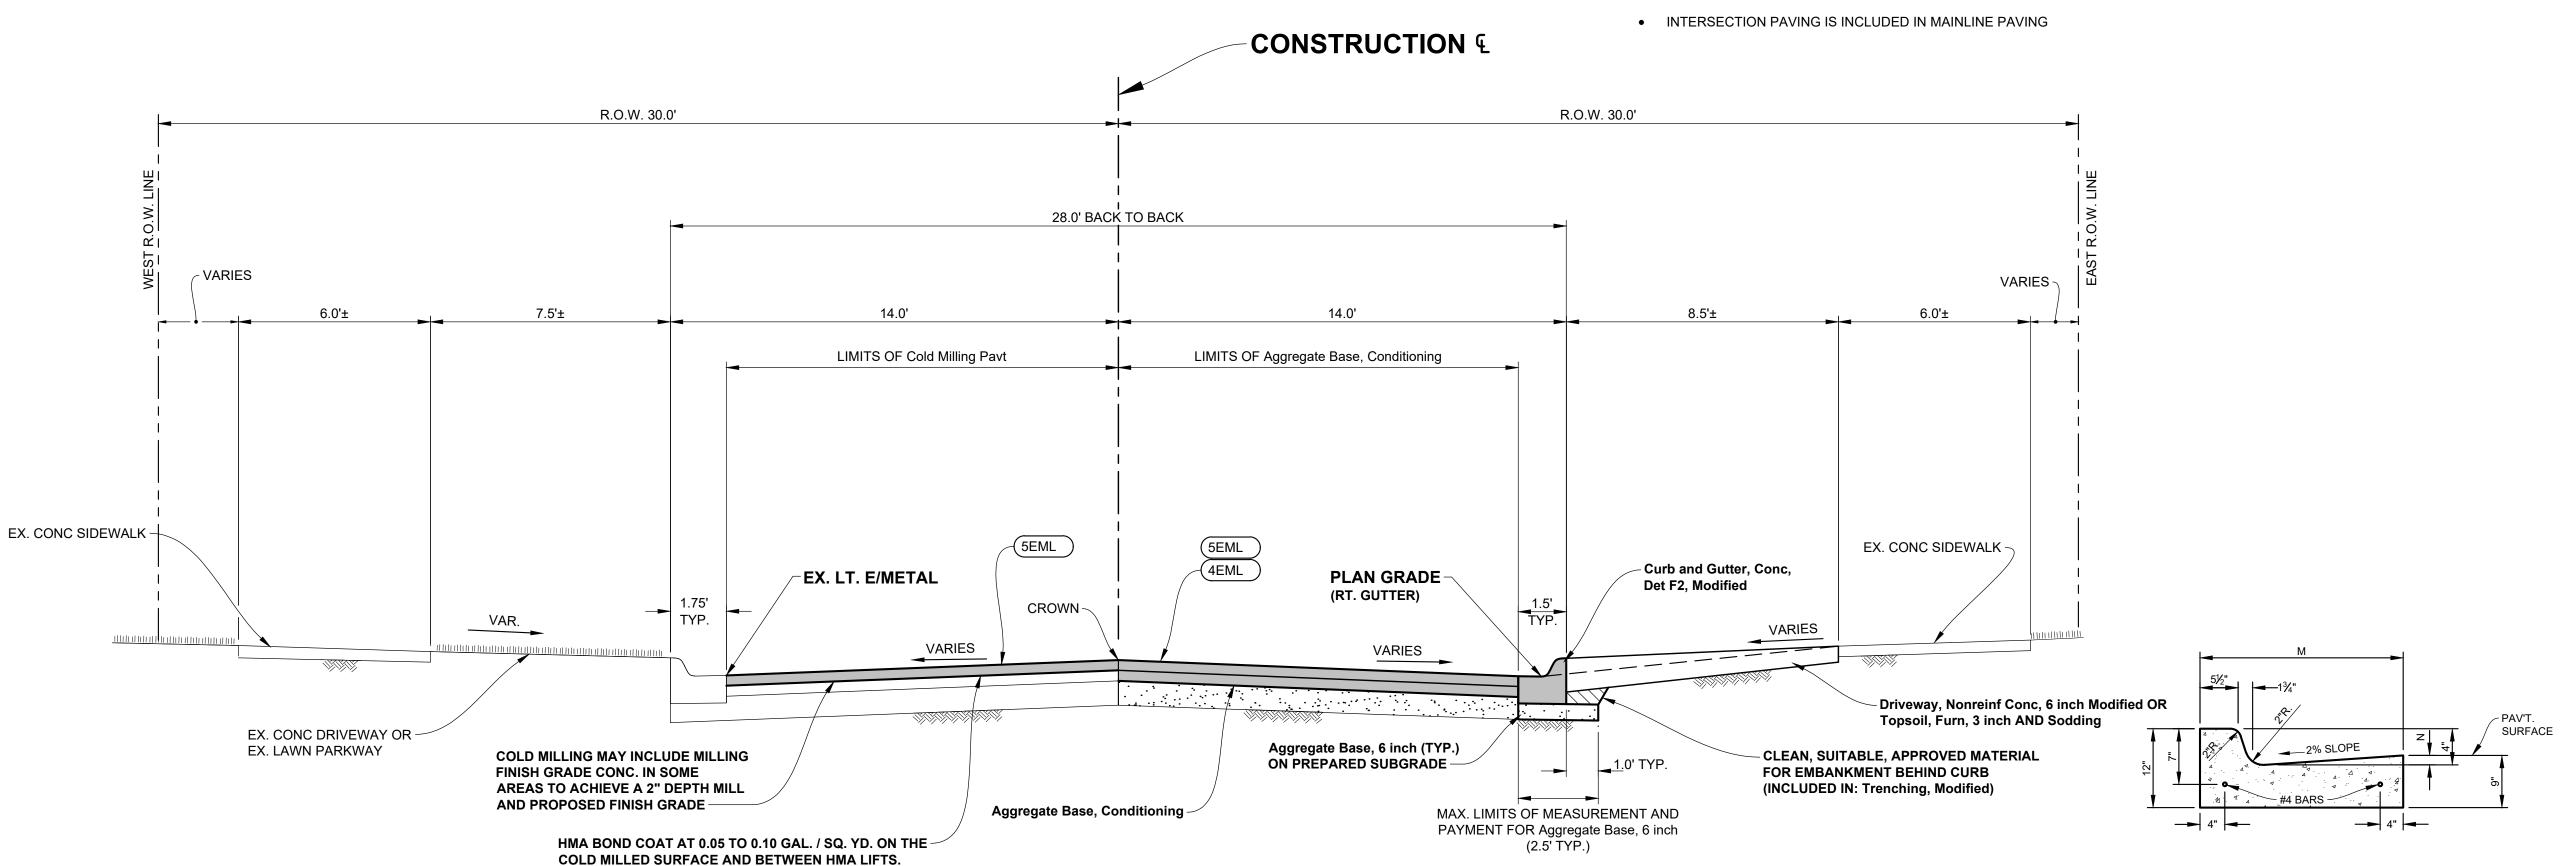
STA. 10+42+00 (P.O.B.) TO STA. 62+32.00 SCALE: 1" = 3'



\* FOR INFORMATION ONLY (PAYMENT FOR BOND COATS SHALL BE INCLUDED IN HMA MIXTURES)

#### NOTES:

- HMA MIXTURES SHALL BE PLACED IN LIFTS WHICH DO NOT EXCEED THE MAXIMUM HMA APPLICATION RATES IN SECTION 501 OF THE STANDARD SPECIFICATIONS FOR CONSTRUCTION.



DIMENSIONS LANE CONCRETE M N TIES CU.YD./LIN.FT. 1'-6" 1/4" OMITTED 0.0484

CONCRETE CURB "F2" MODIFIED

ANDERSON, ECKSTEIN AND WESTRICK, INC.

Fax 586 726 8780

CIVIL ENGINEERS SURVEYORS ARCHITECTS 51301 Schoenherr Road Phone 586 726 1234 Shelby Township

Michigan 48315

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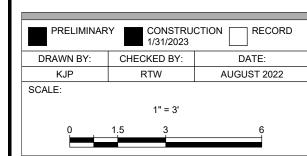
**HAMPTON ROAD WATER MAIN & RESURFACING** 

(MACK AVE. TO MARTER RD.)

SHEET TITLE:

**TYPICAL CROSS SECTIONS** 

CITY OF GROSSE POINTE WOODS





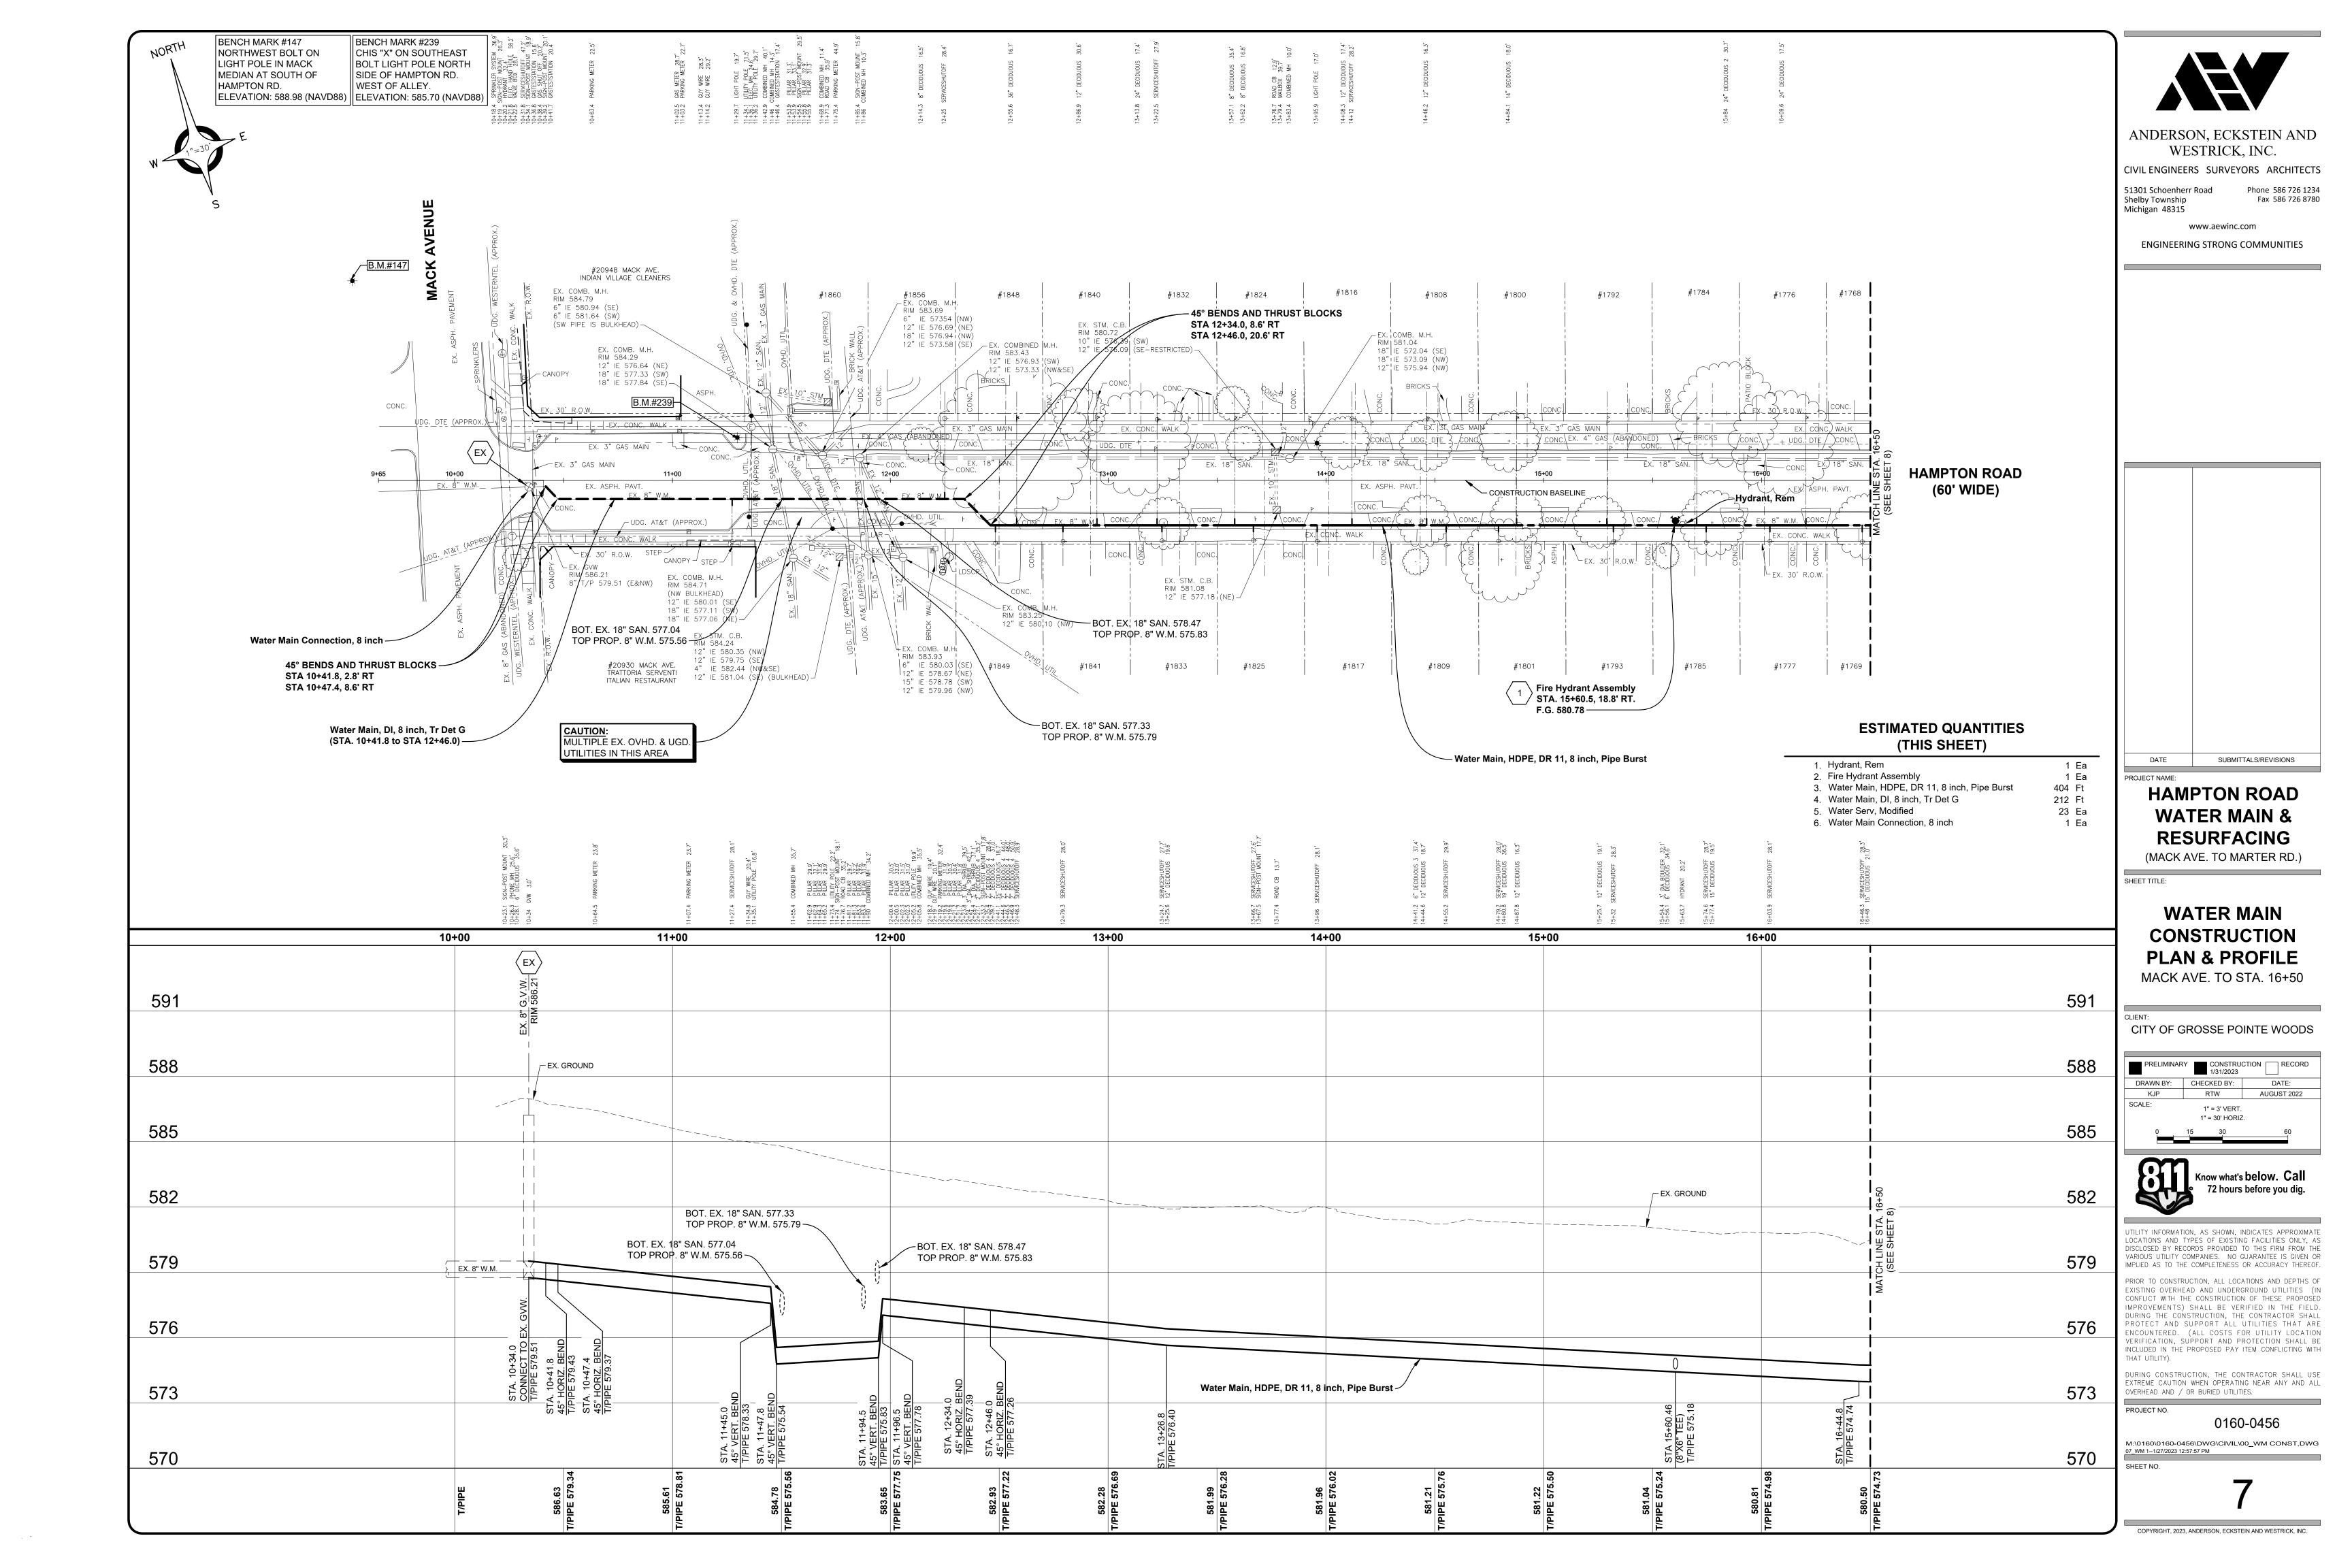
ITILITY INFORMATION, AS SHOWN, INDICATES APPROXIMATE LOCATIONS AND TYPES OF EXISTING FACILITIES ONLY, AS DISCLOSED BY RECORDS PROVIDED TO THIS FIRM FROM THE VARIOUS UTILITY COMPANIES. NO GUARANTEE IS GIVEN OR IMPLIED AS TO THE COMPLETENESS OR ACCURACY THEREOF.

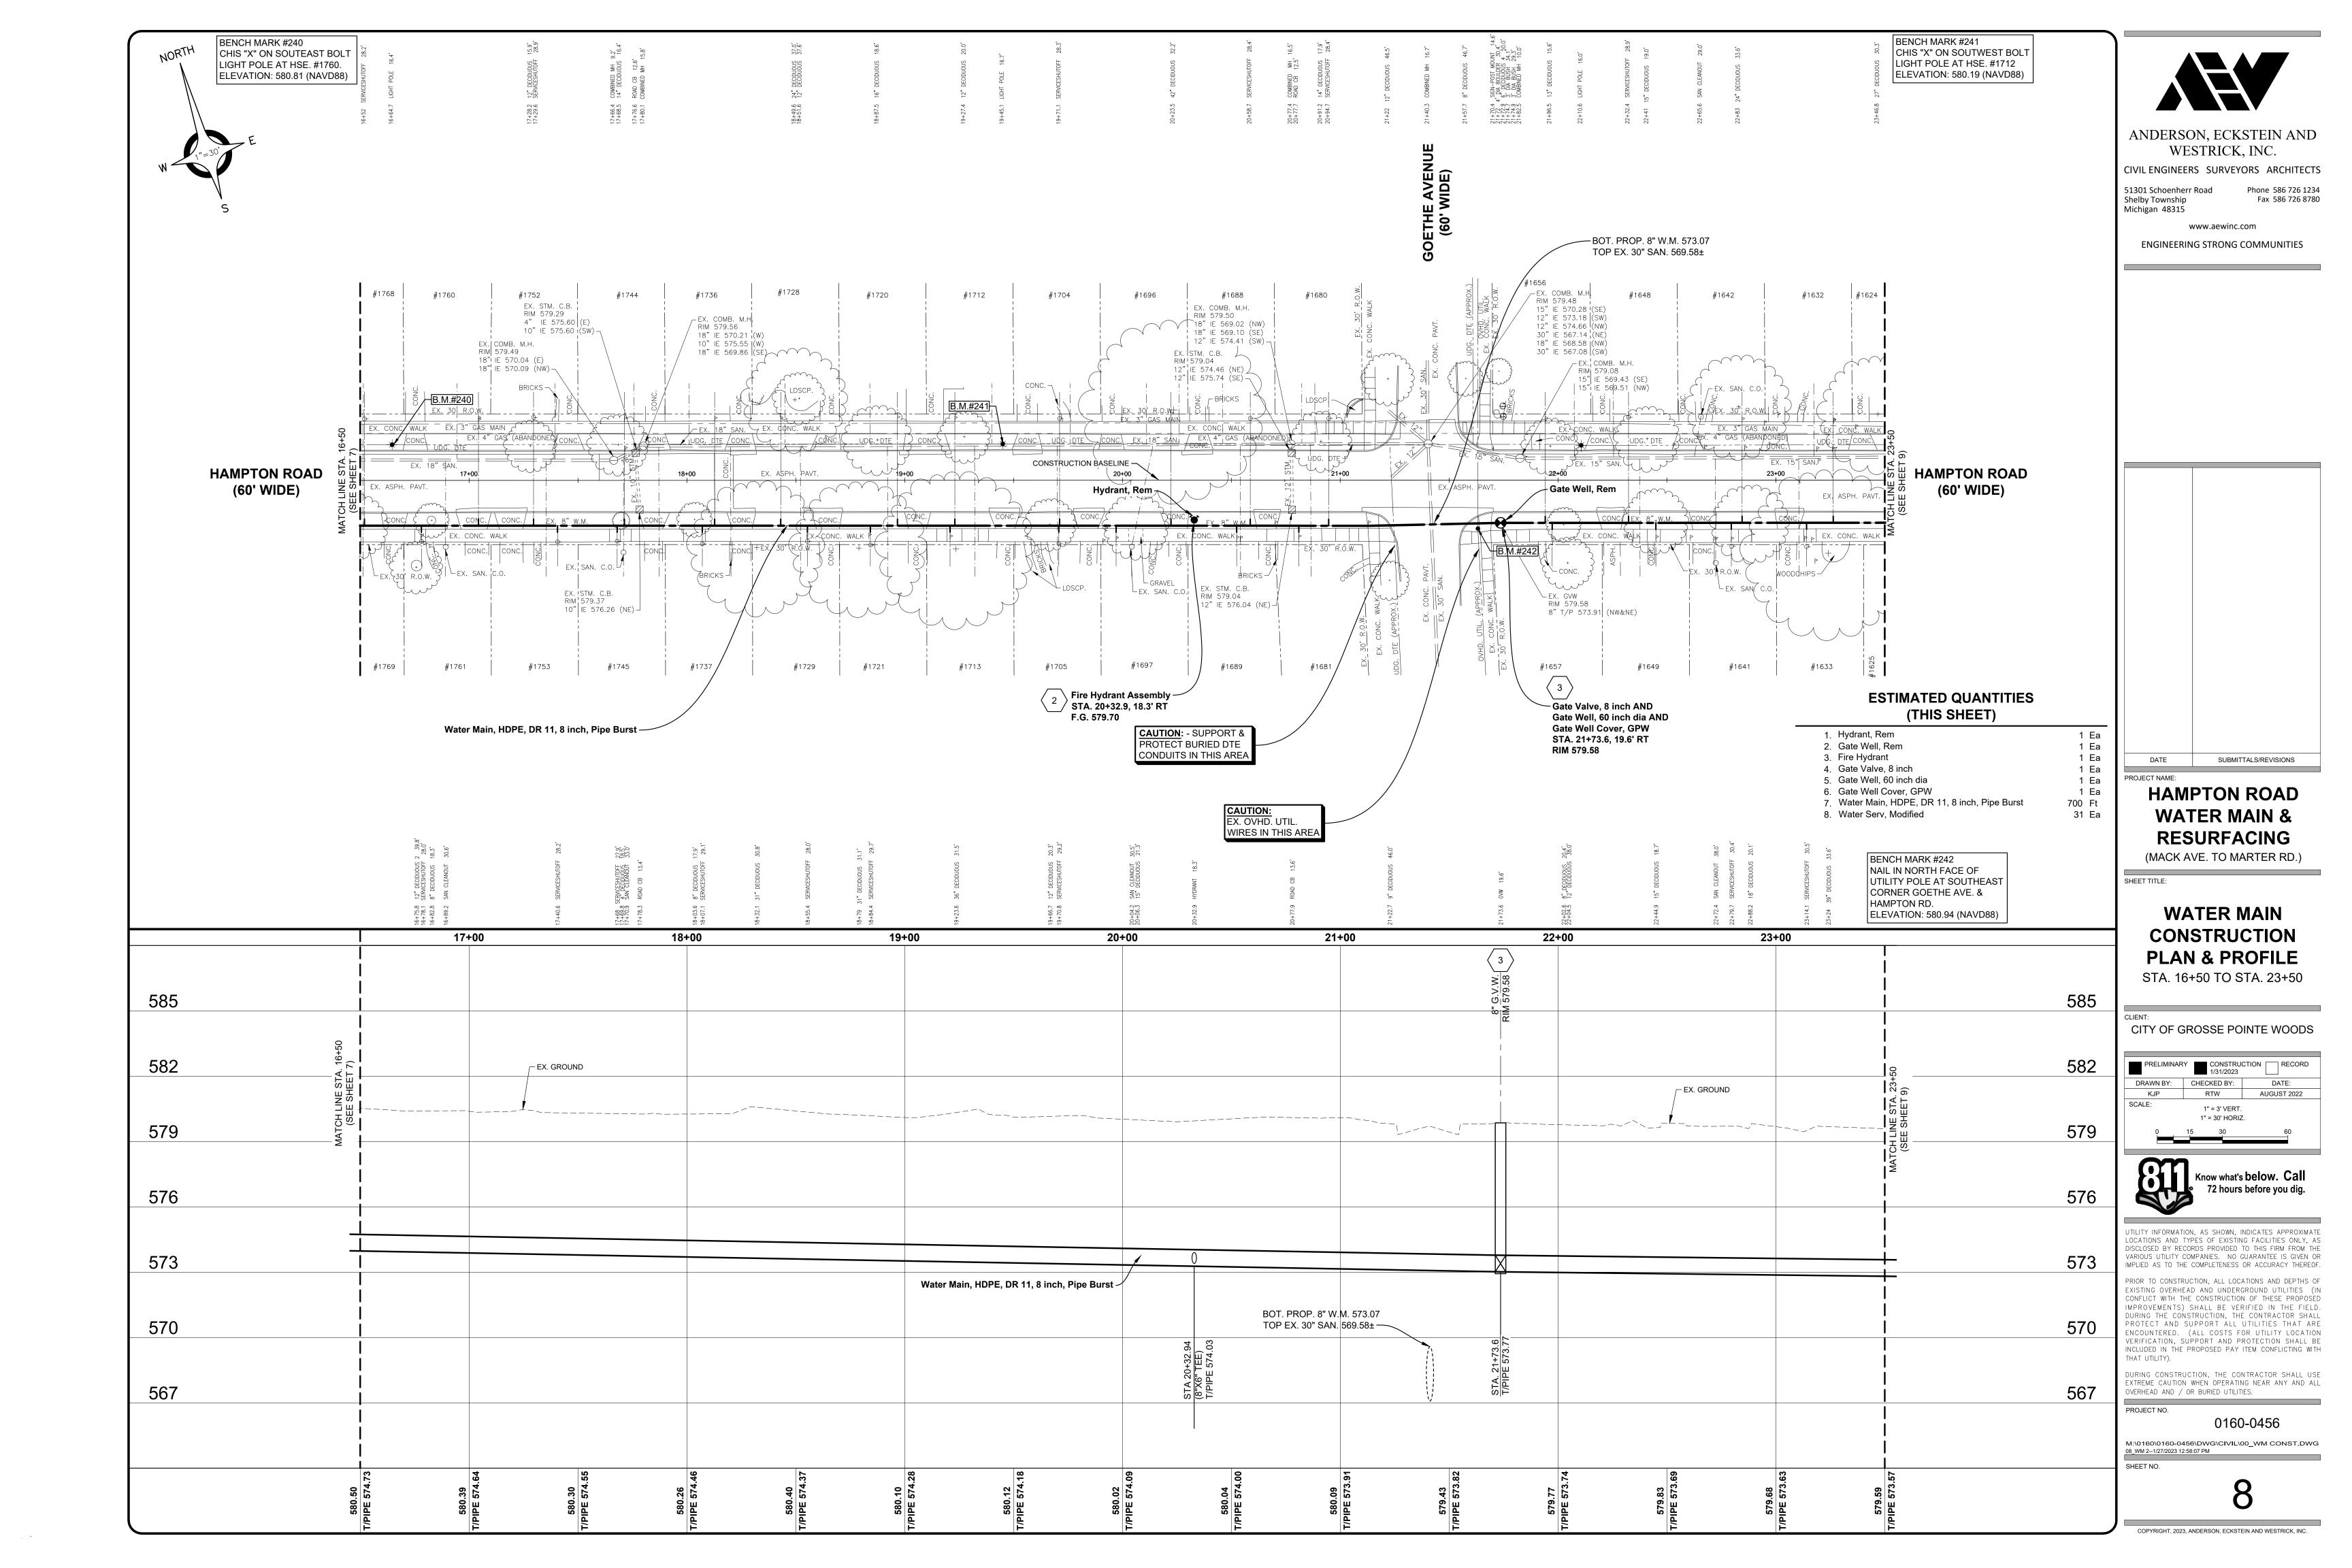
PRIOR TO CONSTRUCTION, ALL LOCATIONS AND DEPTHS OF EXISTING OVERHEAD AND UNDERGROUND UTILITIES (IN CONFLICT WITH THE CONSTRUCTION OF THESE PROPOSED IMPROVEMENTS) SHALL BE VERIFIED IN THE FIELD. DURING THE CONSTRUCTION, THE CONTRACTOR SHALL PROTECT AND SUPPORT ALL UTILITIES THAT ARE ENCOUNTERED. (ALL COSTS FOR UTILITY LOCATION VERIFICATION, SUPPORT AND PROTECTION SHALL BE INCLUDED IN THE PROPOSED PAY ITEM CONFLICTING WITH

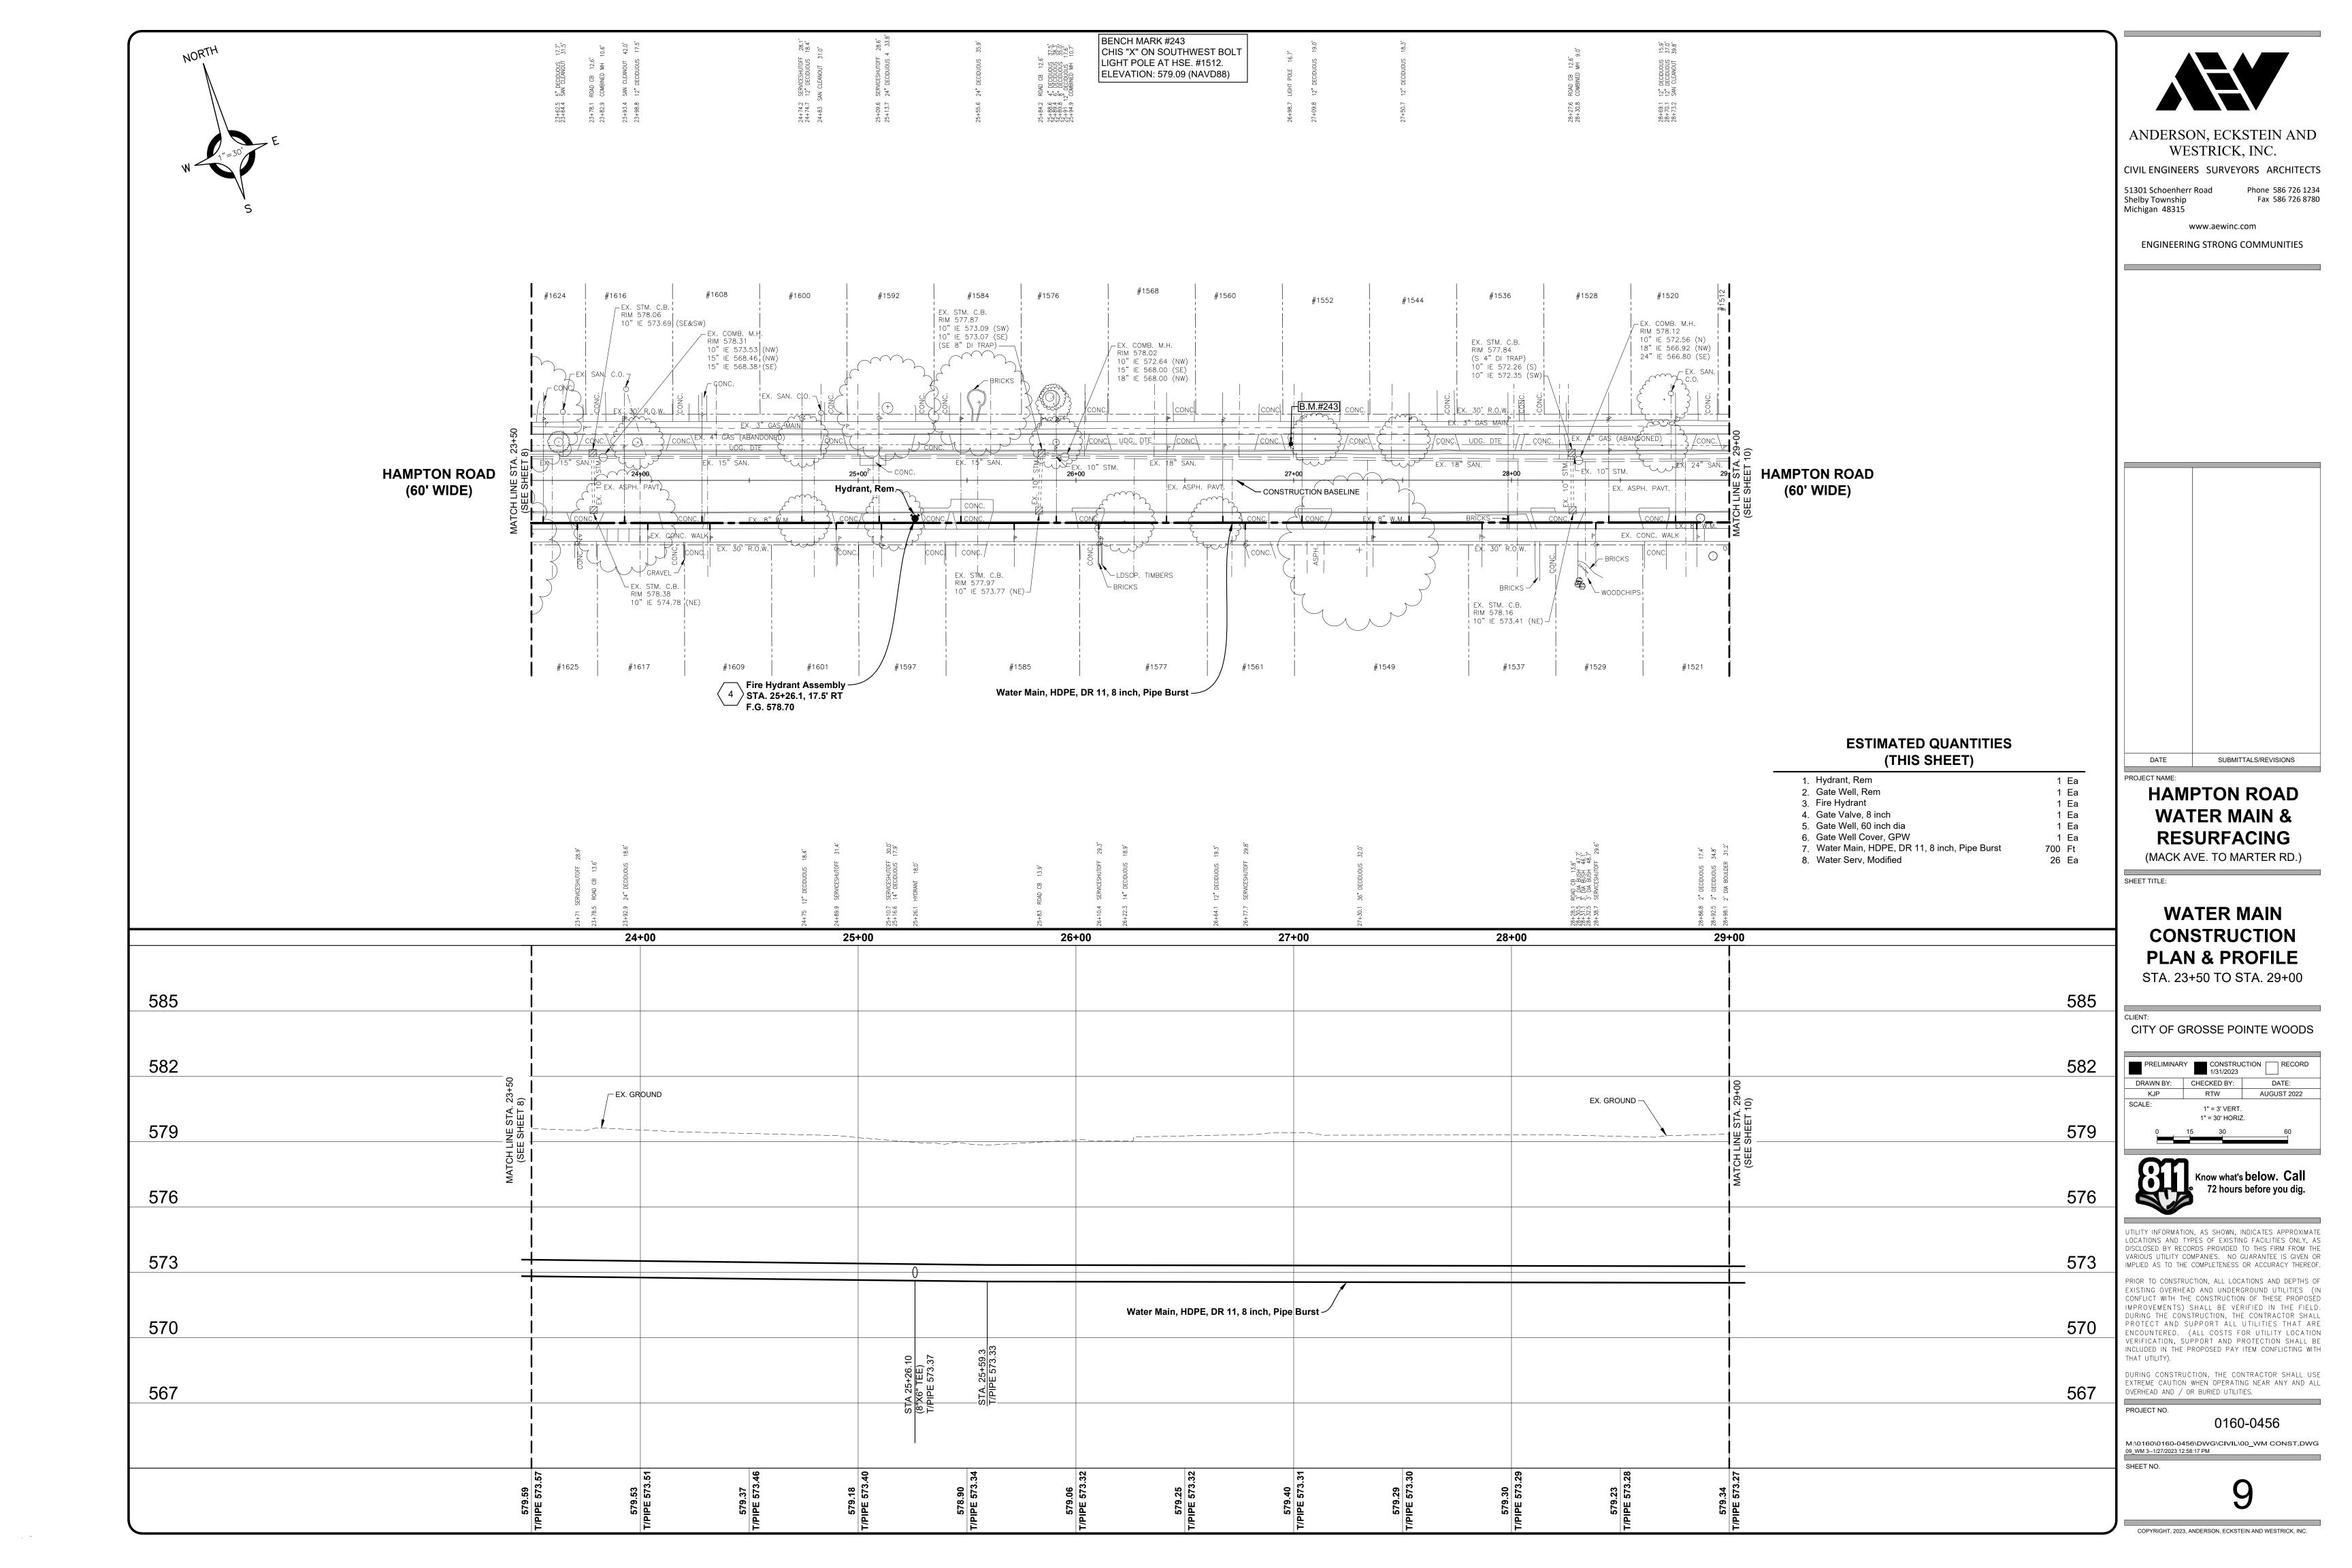
DURING CONSTRUCTION, THE CONTRACTOR SHALL USE EXTREME CAUTION WHEN OPERATING NEAR ANY AND ALL OVERHEAD AND / OR BURIED UTILITIES.

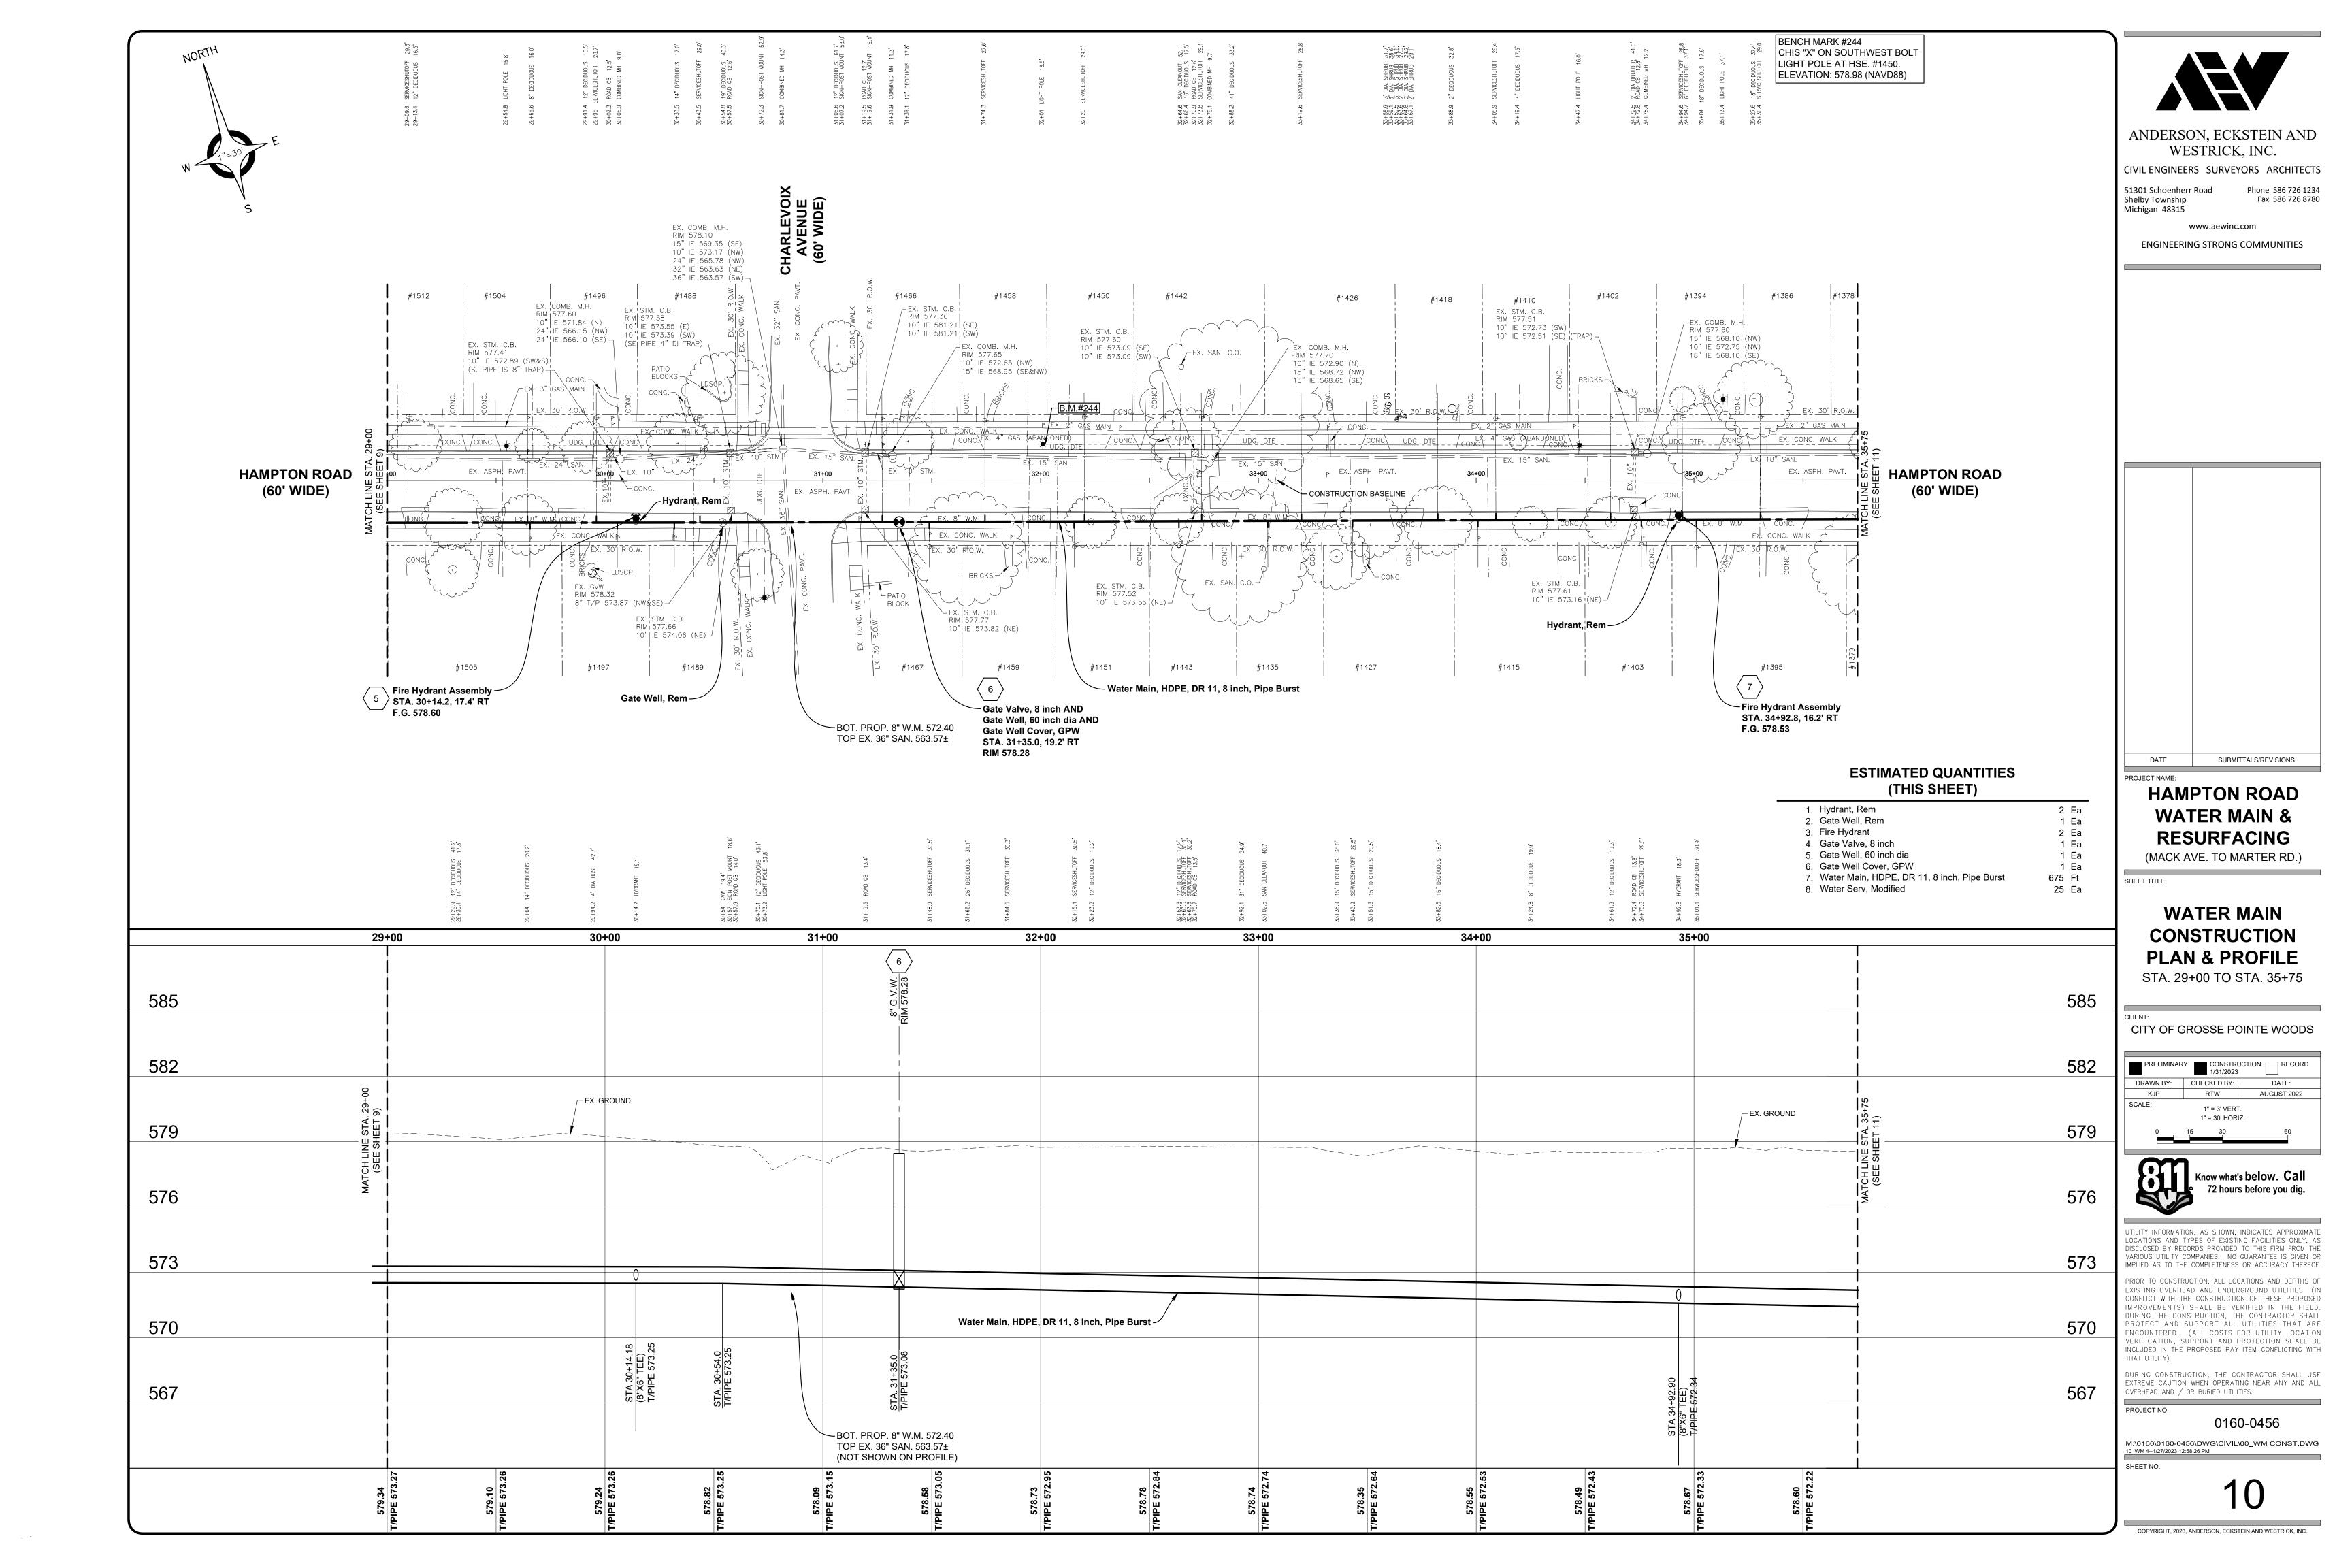
PROJECT NO. 0160-0456

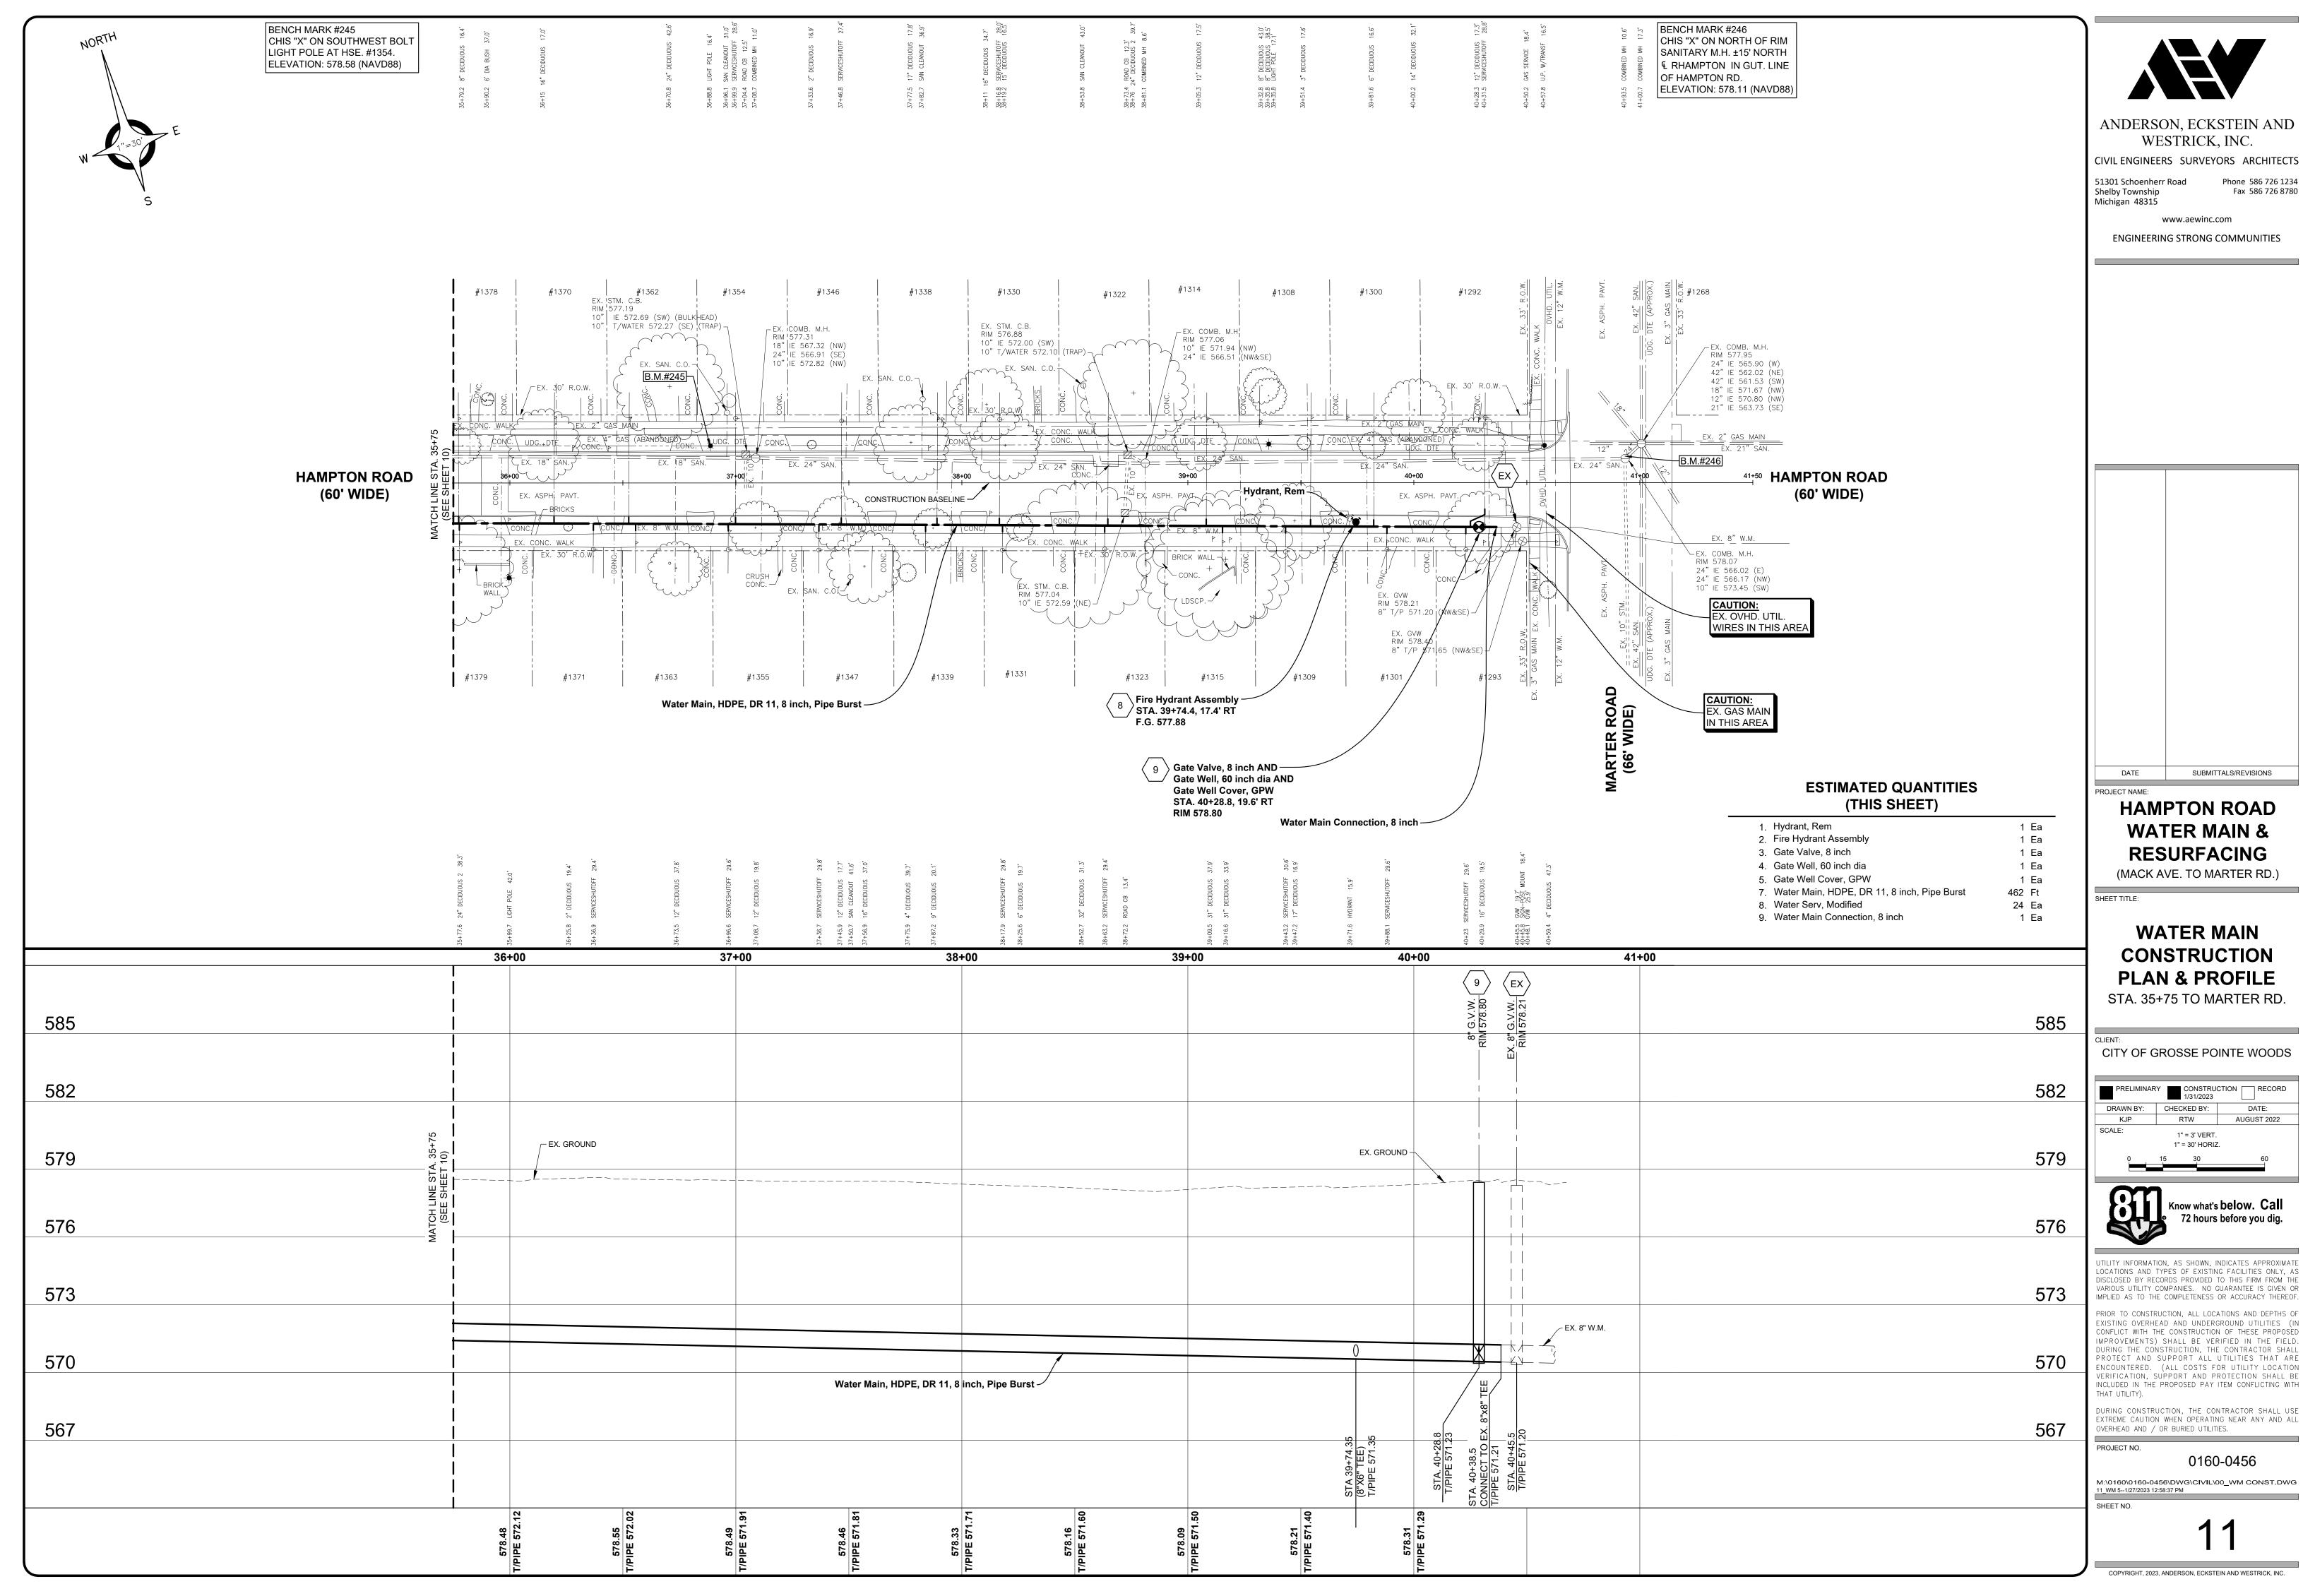
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AUGUST 2022

ITILITY INFORMATION, AS SHOWN, INDICATES APPROXIMATE

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DURING CONSTRUCTION, THE CONTRACTOR SHALL USE XTREME CAUTION WHEN OPERATING NEAR ANY AND ALL

M:\0160\0160-0456\DWG\CIVIL\00\_WM CONST.DWG

BENCH MARK #147 NORTHWEST BOLT ON LIGHT POLE IN MACK MEDIAN AT SOUTH OF HAMPTON RD. | ELEVATION: 588.98 (NAVD88) | | ELEVATION: 585.70 (NAVD88)

BENCH MARK #239 CHIS "X" ON SOUTHEAST BOLT LIGHT POLE NORTH SIDE OF HAMPTON RD. WEST OF ALLEY.

28.3° 29.2°



WESTRICK, INC. CIVIL ENGINEERS SURVEYORS ARCHITECTS

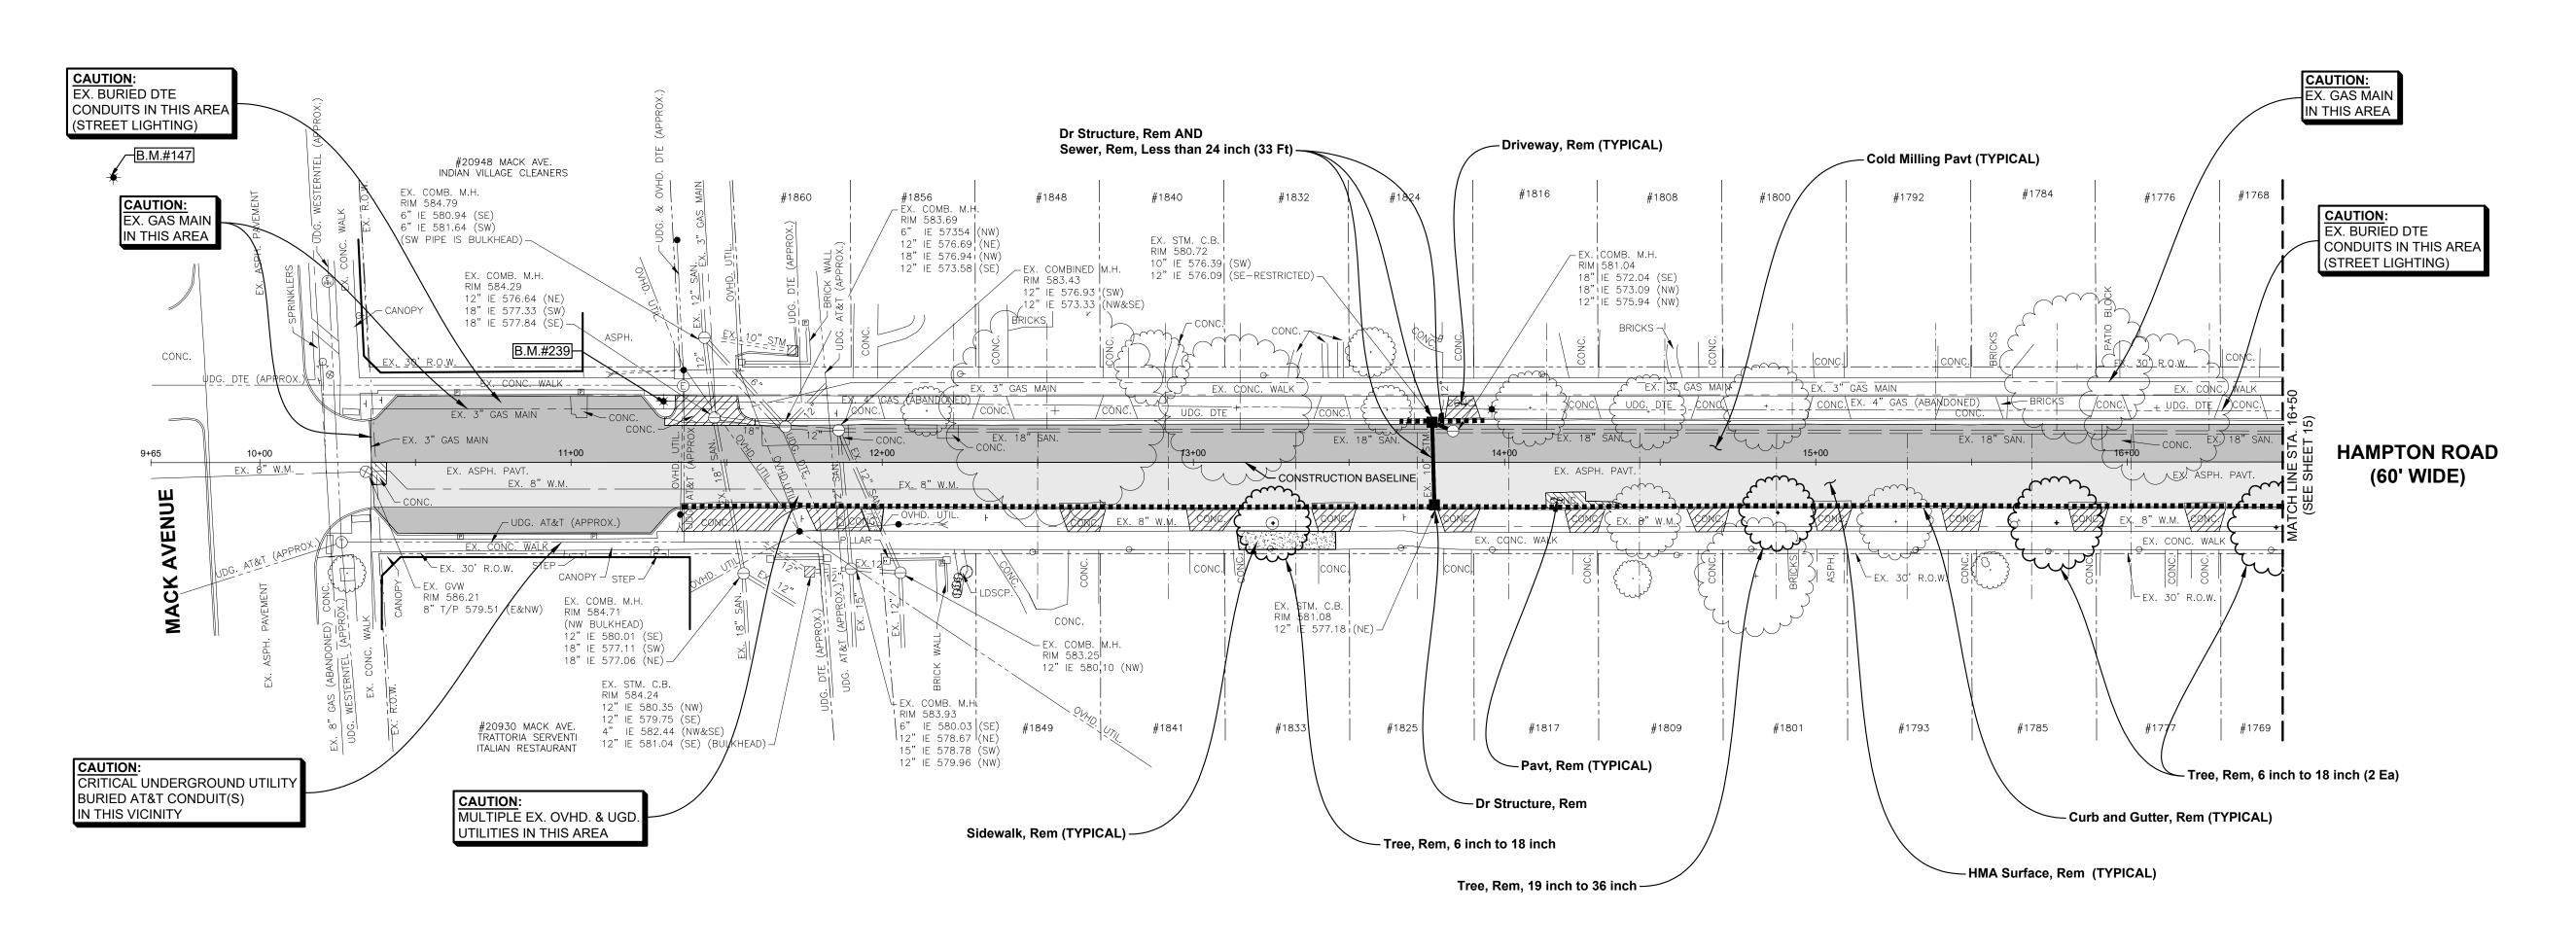
ANDERSON, ECKSTEIN AND

51301 Schoenherr Road Shelby Township Michigan 48315

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ENGINEERING STRONG COMMUNITIES

Phone 586 726 1234 Fax 586 726 8780



12.9 39.7' MH

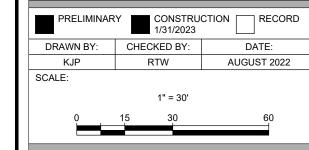
#### **ESTIMATED QUANTITIES** (THIS SHEET)

1.	Pavt, Rem	13	Syd
2.	HMA Surface, Rem	971	Syd
3.	Cold Milling Pavt	998	Syd
4.	Curb and Gutter, Rem	542	Ft
5.	Sidewalk, Rem	25	Syd
6.	Driveway, Rem	165	Syd
7.	Dr Structure, Rem	2	Ea
8.	Sewer, Rem, Less than 24 inch	33	Ft
9.	Tree, Rem, 6 inch to 18 inch	2	Ea
10.	Tree, Rem, 19 inch to 36 inch	2	Ea

SUBMITTALS/REVISIONS **HAMPTON ROAD WATER MAIN & RESURFACING** (MACK AVE. TO MARTER RD.) SHEET TITLE: **REMOVAL PLAN** 

STA. 9+65 TO STA. 16+50

CITY OF GROSSE POINTE WOODS





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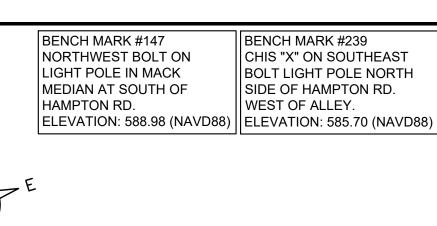
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DURING CONSTRUCTION, THE CONTRACTOR SHALL USE EXTREME CAUTION WHEN OPERATING NEAR ANY AND ALL OVERHEAD AND / OR BURIED UTILITIES.

THAT UTILITY).

PROJECT NO. 0160-0456

M:\0160\0160-0456\DWG\CIVIL\00\_REMOVAL.DWG 12\_Rem 1--1/30/2023 4:54:12 PM SHEET NO.



28.3' 29.2'

Dr Structure, 48 inch dia
WITH 2' SUMP AND
Dr Structure Trap, 12 inch AND
External Structure Wrap, 18 inch AND
Catch Basin Cover, Restricted, GPW
STA. 13+76.32, 12.7' LT.
RIM 580.82
12" IE 576.50 (S)
12" IE 576.02 (SE)

12.9 39.7 MH



ANDERSON, ECKSTEIN AND WESTRICK, INC.

Fax 586 726 8780

CIVIL ENGINEERS SURVEYORS ARCHITECTS
51301 Schoenherr Road Phone 586 726 1234

51301 Schoenherr Road Shelby Township Michigan 48315

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ENGINEERING STRONG COMMUNITIES

DATE SUBMITTALS/REVISIONS

HAMPTON ROAD
WATER MAIN &
RESURFACING

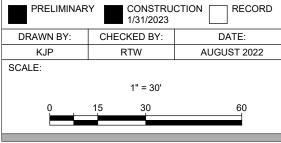
(MACK AVE. TO MARTER RD.)

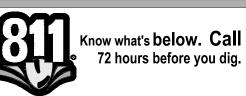
SHEET TITLE:

PAVEMENT CONSTRUCTION PLAN

MACK AVE. TO STA. 16+50

CITY OF GROSSE POINTE WOODS





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1Ea

1Ea

6 Ea

2 Ea

4 Ea

33 Ft

151 Syd

250 Syd

875 Syd

124 Syd

86 Ft

58 Syd

144 Ton

206 Ton

484 Ft

154 Sft

77 Sft

45 Sft

4. Dr Structure Trap, 12 inch

5. Dr Structure, Tap, 12 inch

10. Aggregate Base, 6 inch

19. Sidewalk, Conc, 4 inch

20. Sidewalk, Conc, 6 inch

21. Sidewalk, Conc, 8 inch

16. HMA, 4EML

17. HMA, 5EML

11. Aggregate Base, 11 inch

6. External Structure Wrap, 18 inch

8. Combined Manhole Cover, GPW

9. Sewer, Cl IV, 12 inch, Tr Det B

12. Aggregate Base, Conditioning

14. Driveway Opening, Conc, Det M

7. Catch Basin Cover, Restricted, GPW

13. Driveway, Nonreinf Conc, 6 inch, Modified

15. Driveway, Nonreinf Conc, 8 inch, Modified

18. Curb and Gutter, Conc, Det F1, Modified

PRIOR TO CONSTRUCTION, ALL LOCATIONS AND DEPTHS OF EXISTING OVERHEAD AND UNDERGROUND UTILITIES (IN CONFLICT WITH THE CONSTRUCTION OF THESE PROPOSED IMPROVEMENTS) SHALL BE VERIFIED IN THE FIELD. DURING THE CONSTRUCTION, THE CONTRACTOR SHALL PROTECT AND SUPPORT ALL UTILITIES THAT ARE ENCOUNTERED. (ALL COSTS FOR UTILITY LOCATION VERIFICATION, SUPPORT AND PROTECTION SHALL BE INCLUDED IN THE PROPOSED PAY ITEM CONFLICTING WITH

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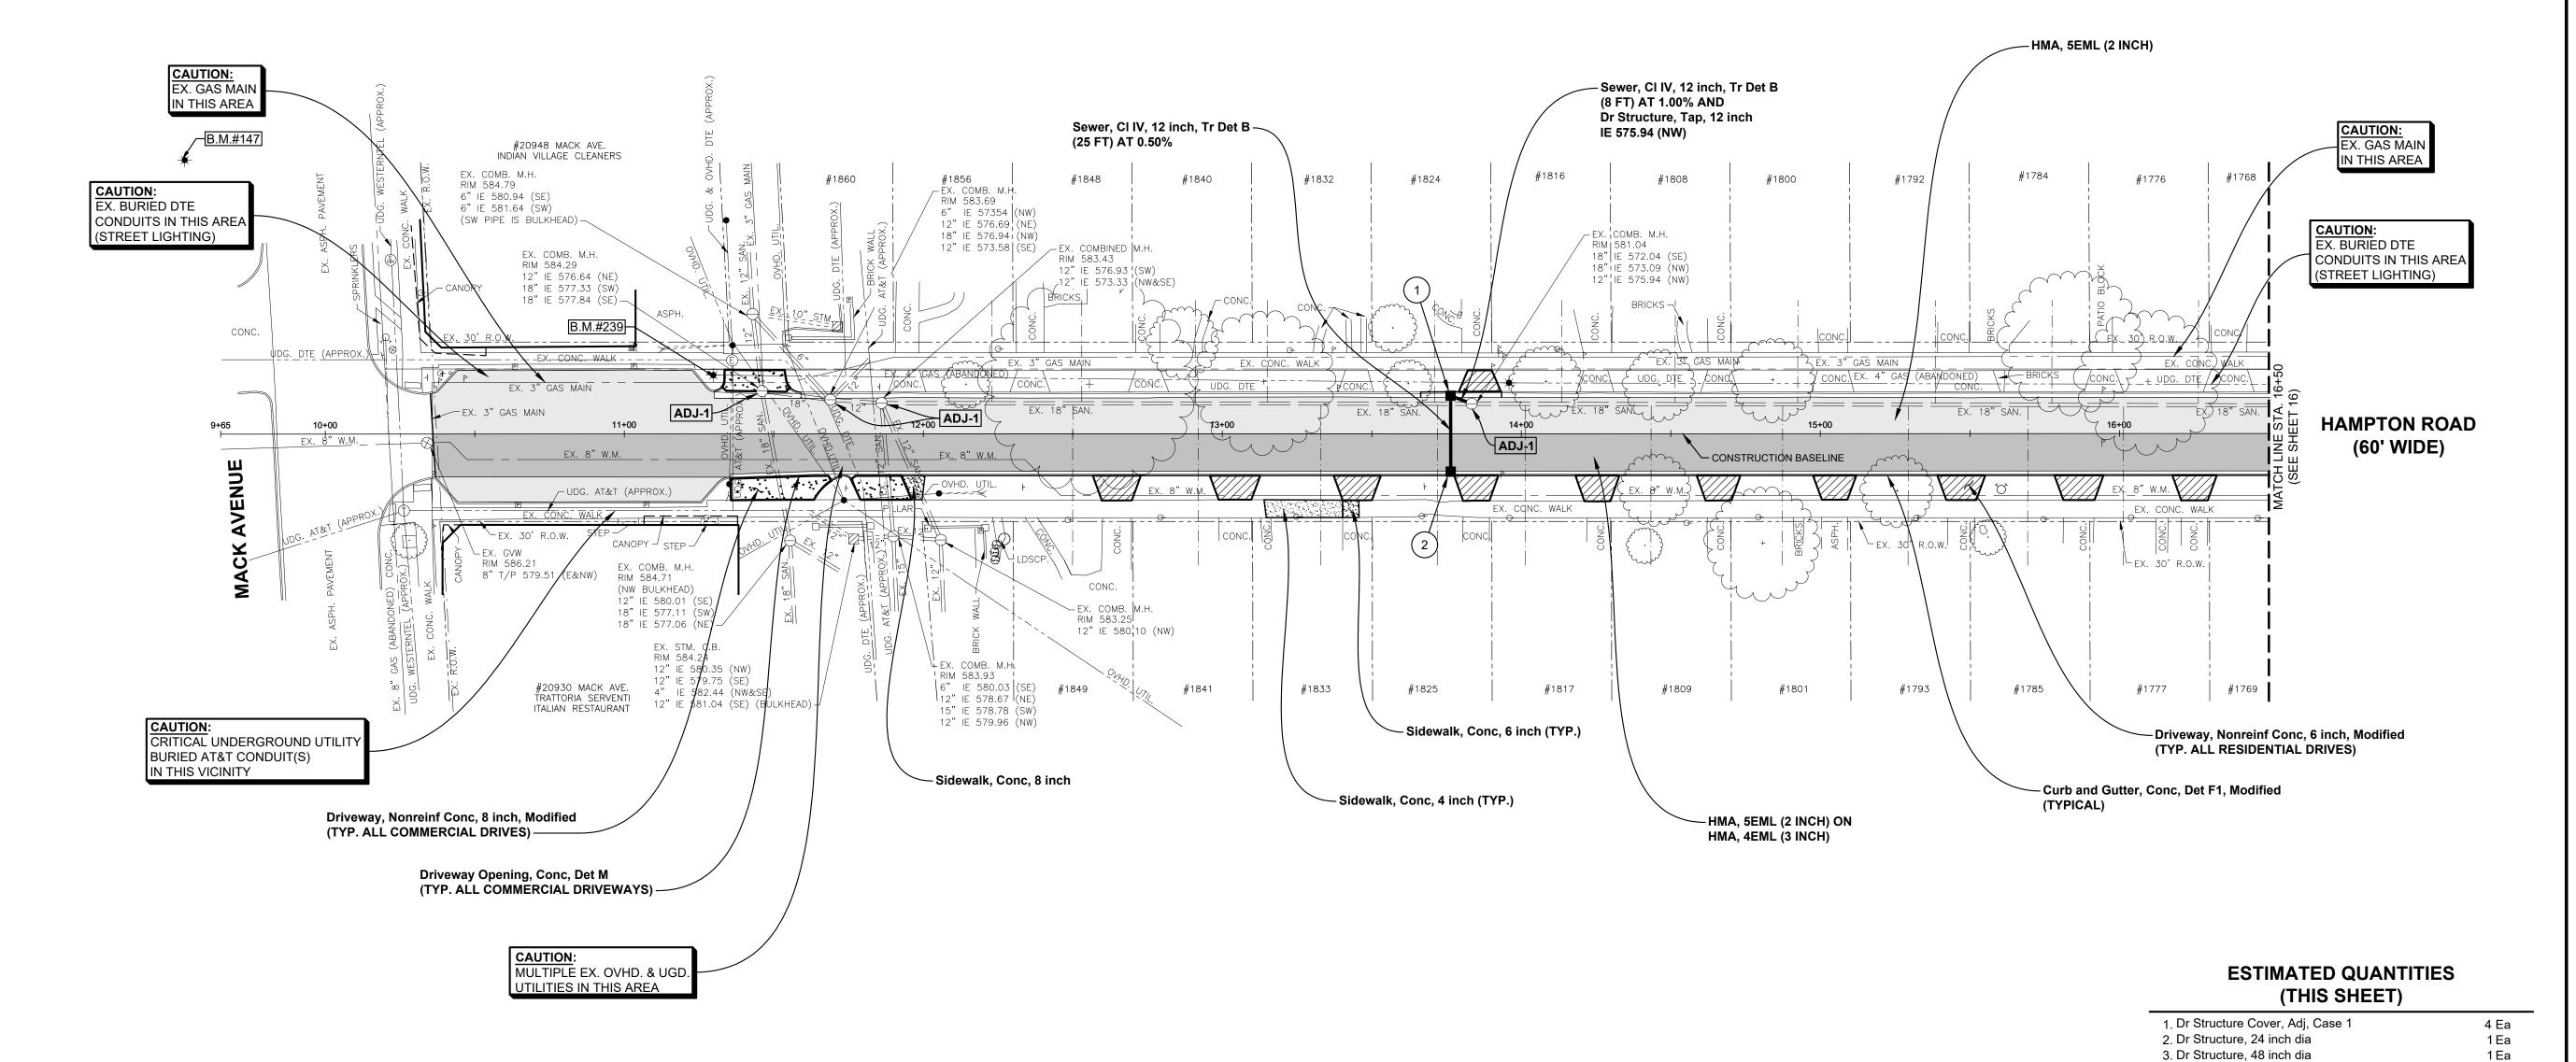
PROJECT NO.

0160-0456

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3



Dr Structure, 24 inch dia WITH 2' SUMP AND

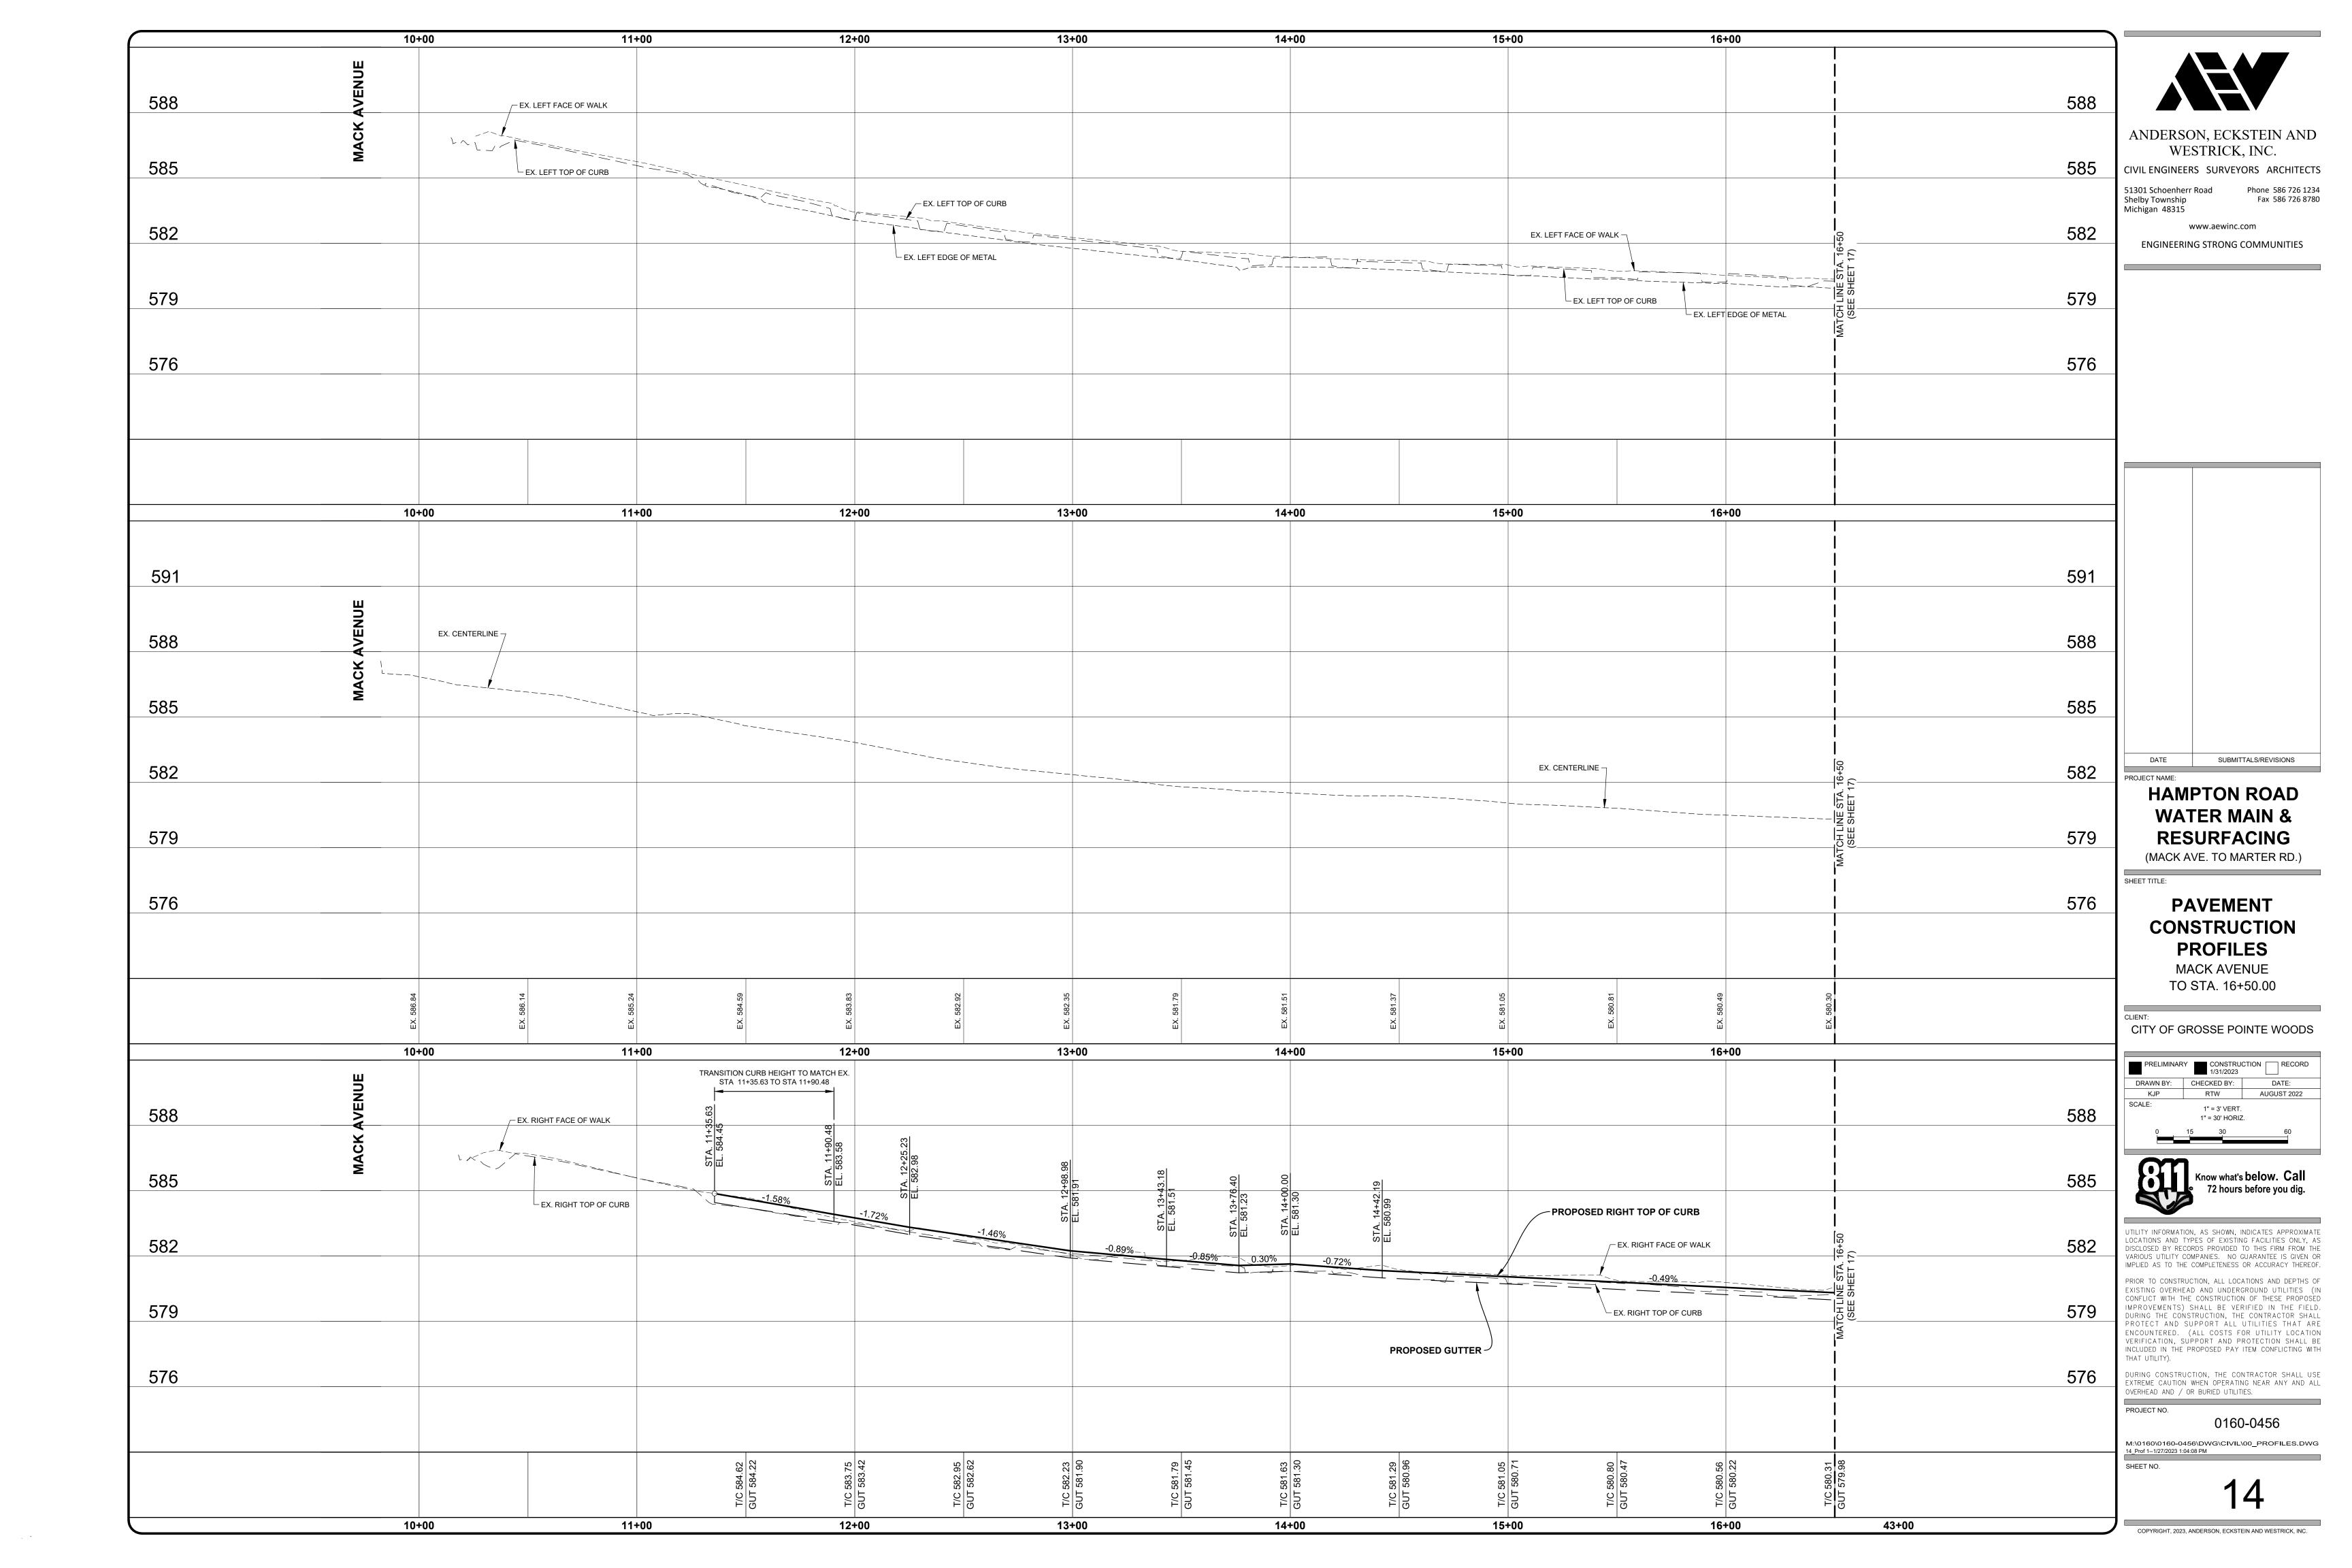
RIM 581.23

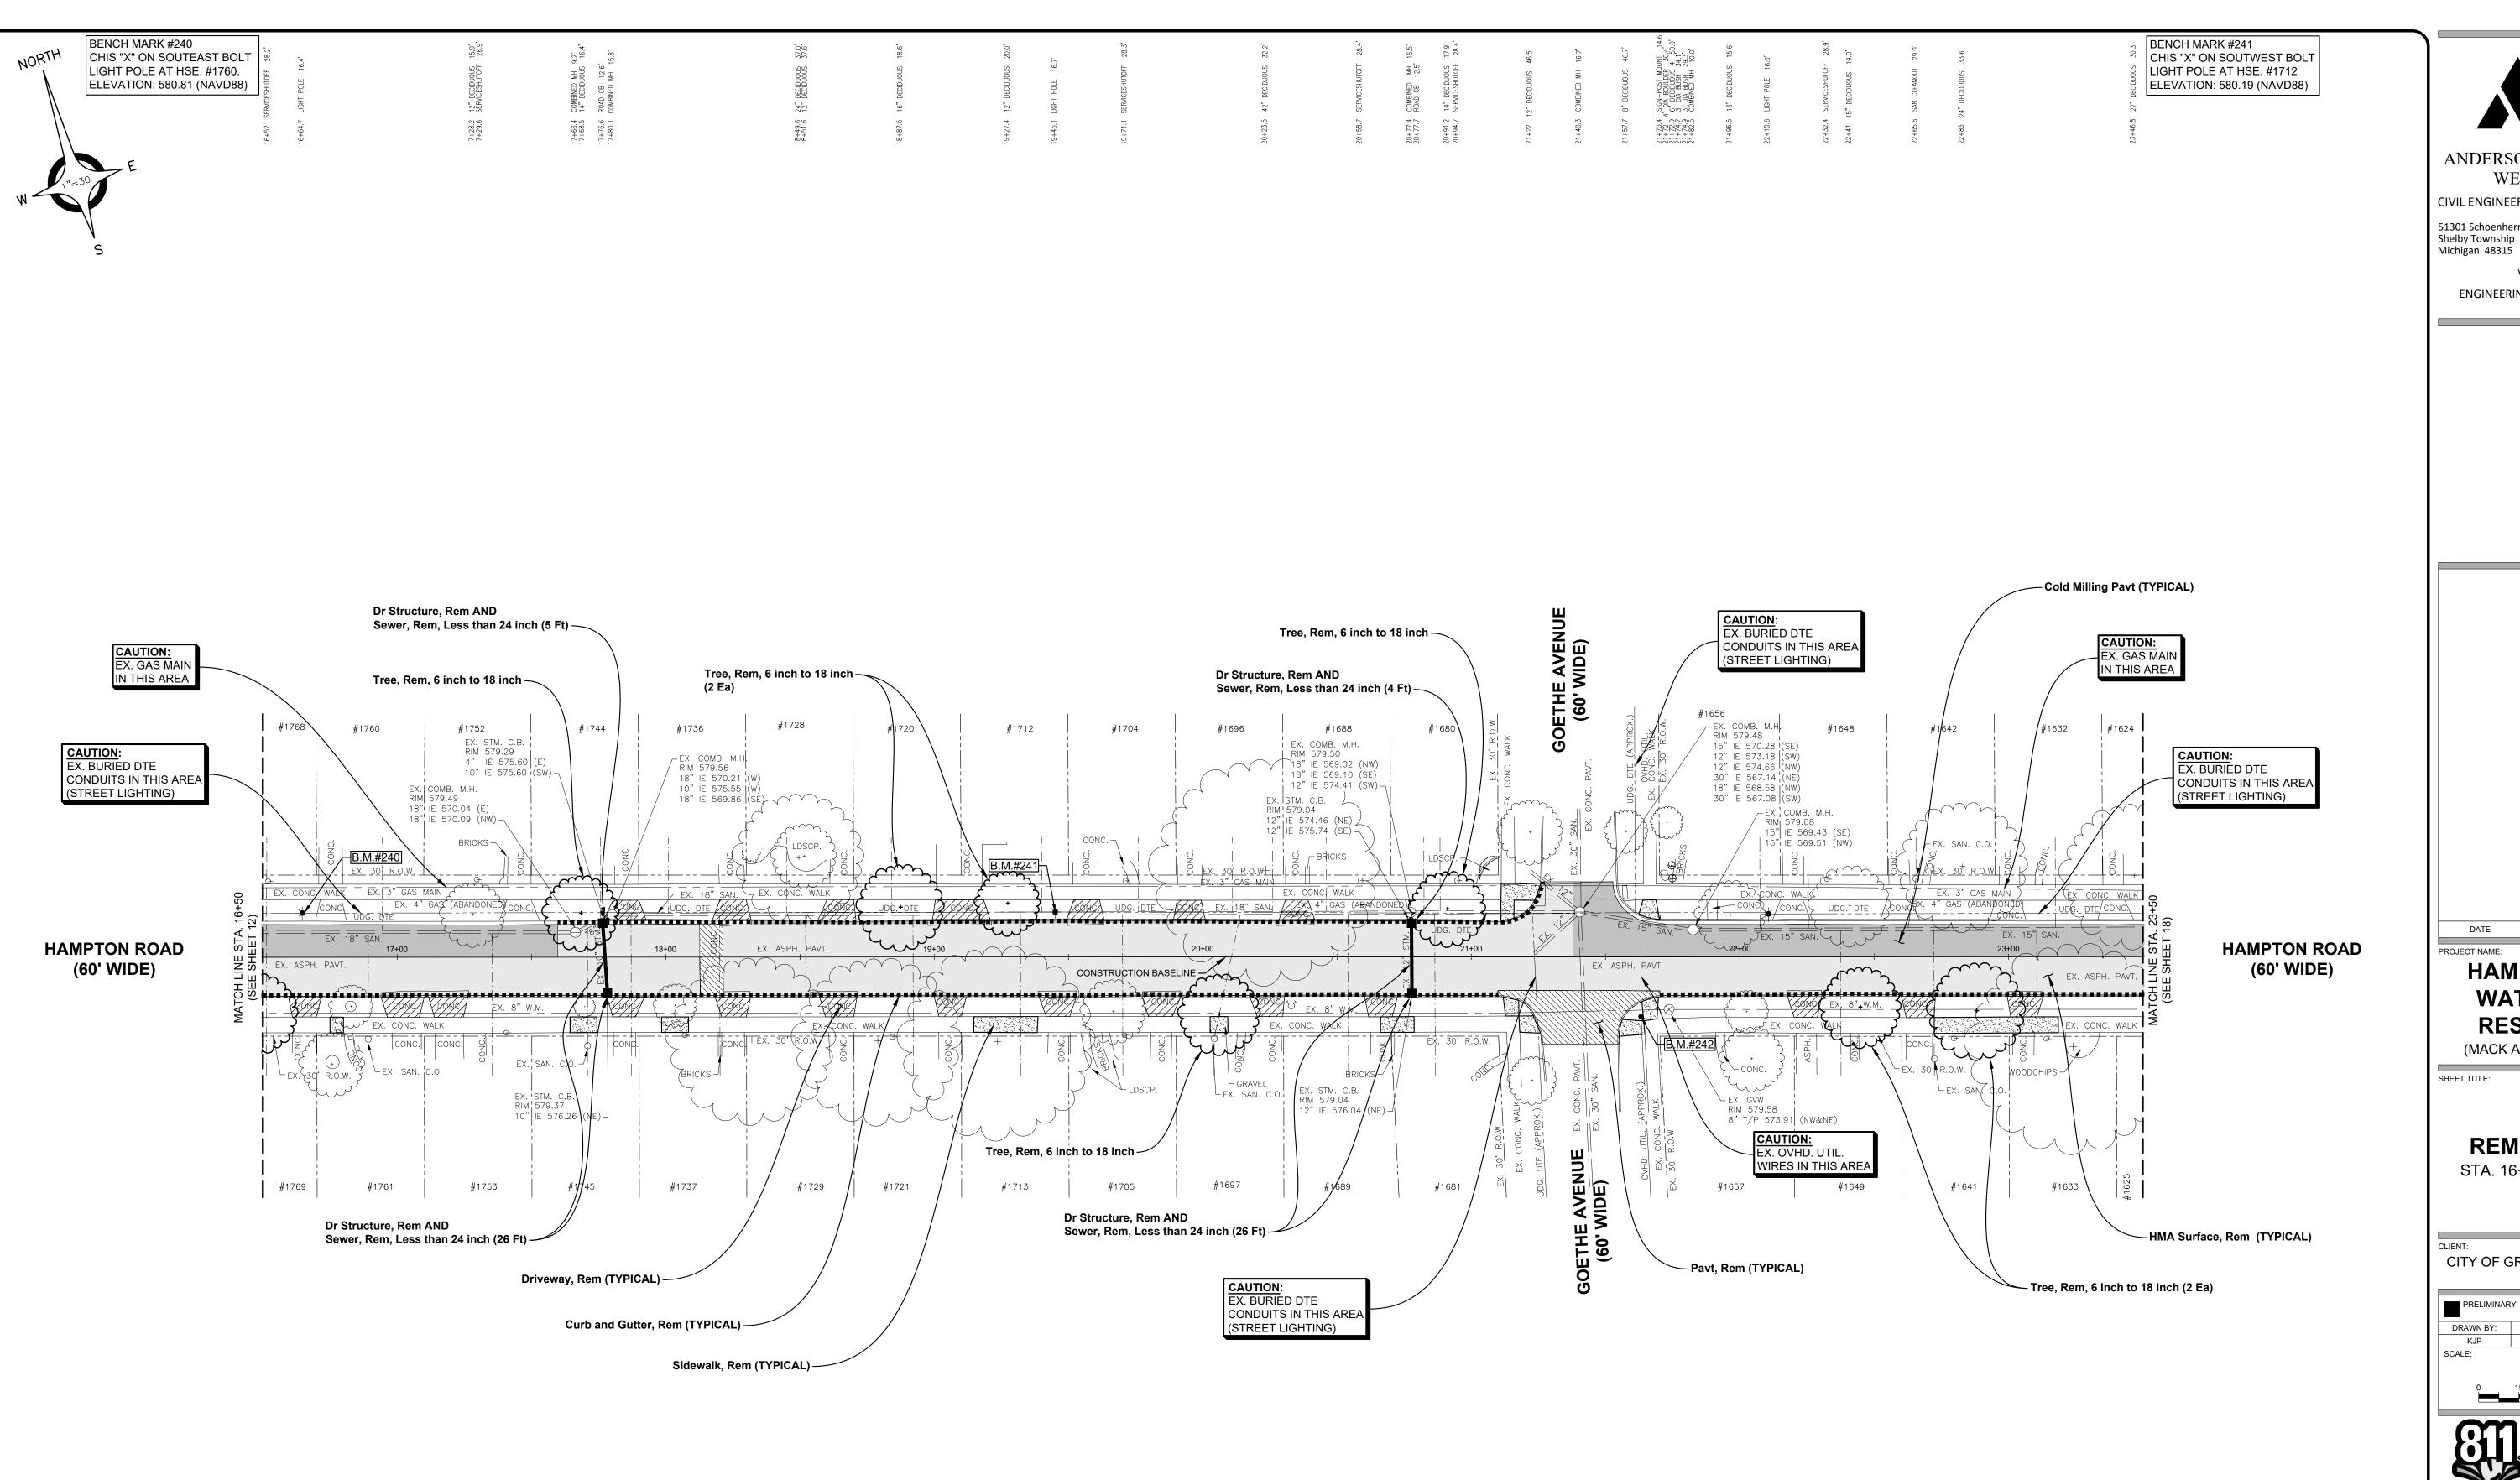
12" IE 576.63 (N)

STA. 13+76.40, 12.7' RT.

External Structure Wrap, 18 inch AND

Catch Basin Cover, Restricted, GPW





#### **ESTIMATED QUANTITIES** (THIS SHEET)

1. Pavt, Rem	110 Syd
2. HMA Surface, Rem	1,635 Syd
<ol><li>Cold Milling Pavt</li></ol>	463 Syd
<ol><li>Curb and Gutter, Rem</li></ol>	1,015 Ft
5. Sidewalk, Rem	112 Syd
6. Driveway, Rem	207 Syd
7. Dr Structure, Rem	4 Ea
8. Sewer, Rem, Less than 24 inch	61 Ft
9. Tree, Rem, 6 inch to 18 inch	7 Ea

BENCH MARK #242 NAIL IN NORTH FACE OF UTILITY POLE AT SOUTHEAST CORNER GOETHE AVE. & HAMPTON RD. ELEVATION: 580.94 (NAVD88)



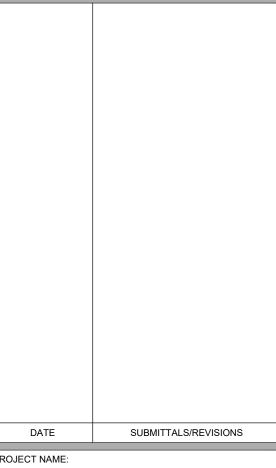
ANDERSON, ECKSTEIN AND WESTRICK, INC.

CIVIL ENGINEERS SURVEYORS ARCHITECTS 51301 Schoenherr Road Phone 586 726 1234

Michigan 48315 www.aewinc.com

ENGINEERING STRONG COMMUNITIES

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**HAMPTON ROAD WATER MAIN & RESURFACING** 

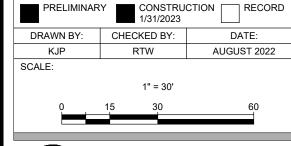
(MACK AVE. TO MARTER RD.)

SHEET TITLE:

**REMOVAL PLAN** 

STA. 16+50 TO STA. 23+50

CITY OF GROSSE POINTE WOODS





UTILITY INFORMATION, AS SHOWN, INDICATES APPROXIMATE LOCATIONS AND TYPES OF EXISTING FACILITIES ONLY, AS

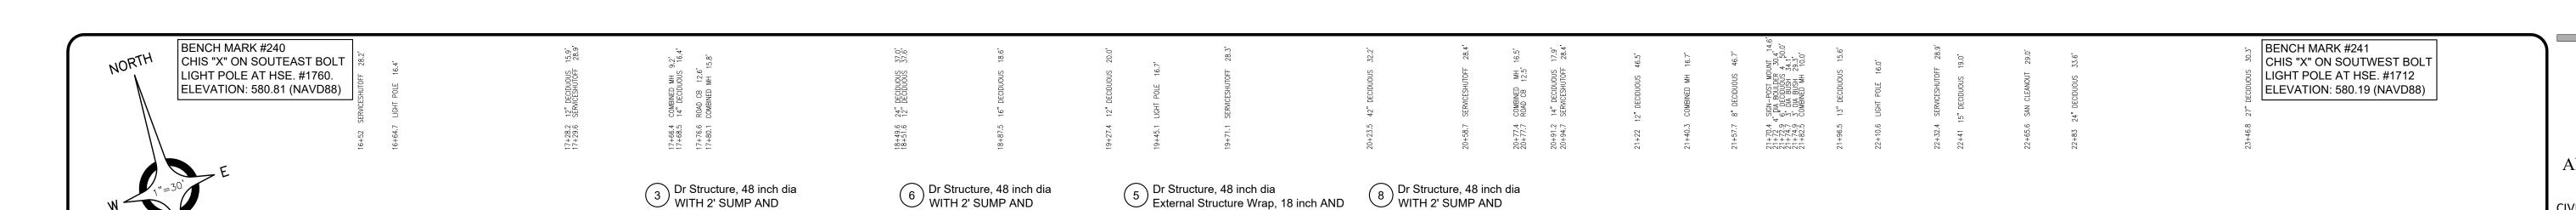
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PROJECT NO. 0160-0456

M:\0160\0160-0456\DWG\CIVIL\00\_REMOVAL.DWG 15\_Rem 2--1/30/2023 4:54:14 PM SHEET NO.



Dr Structure Trap, 12 inch AND

STA. 20+78.00, 12.7' LT.

RIM 579.14

12" IE 574.45 (N) 12" IE 575.50 (S)

External Structure Wrap, 18 inch AND

Catch Basin Cover, Restricted, GPW

9 Dr Structure, 24 inch dia

RIM 579.15

12" IE 575.63 (N)

WITH 2' SUMP AND

STA. 20+78.00, 12.7' RT.

External Structure Wrap, 18 inch AND

Catch Basin Cover, Restricted, GPW

Combined Manhole Cover, GPW

STA. 18+77.02, 16.0' LT.

EX 18" IE 569.59 (E&W)

12" IE 575.70 (SW)

RIM 579.82

Dr Structure Trap, 12 inch AND

STA. 17+74.00, 12.7' LT.

RIM 579.34

12" IE 575.66 (E)

12" IE 575.76 (S)

External Structure Wrap, 18 inch AND

Catch Basin Cover, Restricted, GPW

Dr Structure Trap, 12 inch AND

STA. 18+74.00, 12.7' LT.

RIM 579.37

12" IE 575.75 (NE)

12" IE 575.85 (S)

External Structure Wrap, 18 inch AND

Catch Basin Cover, Restricted, GPW

Dr Structure, 24 inch dia

RIM 579.45

12" IE 575.98 (N)

WITH 2' SUMP AND

STA. 18+74.00, 12.7' RT.

External Structure Wrap, 18 inch AND

Catch Basin Cover, Restricted, GPW

Dr Structure, 24 inch dia WITH 2' SUMP AND

RIM 579.47

12" IE 575.89 (N)

STA. 17+74.00, 12.7' RT.

External Structure Wrap, 18 inch AND

Catch Basin Cover, Restricted, GPW



ANDERSON, ECKSTEIN AND WESTRICK, INC.

CIVIL ENGINEERS SURVEYORS ARCHITECTS

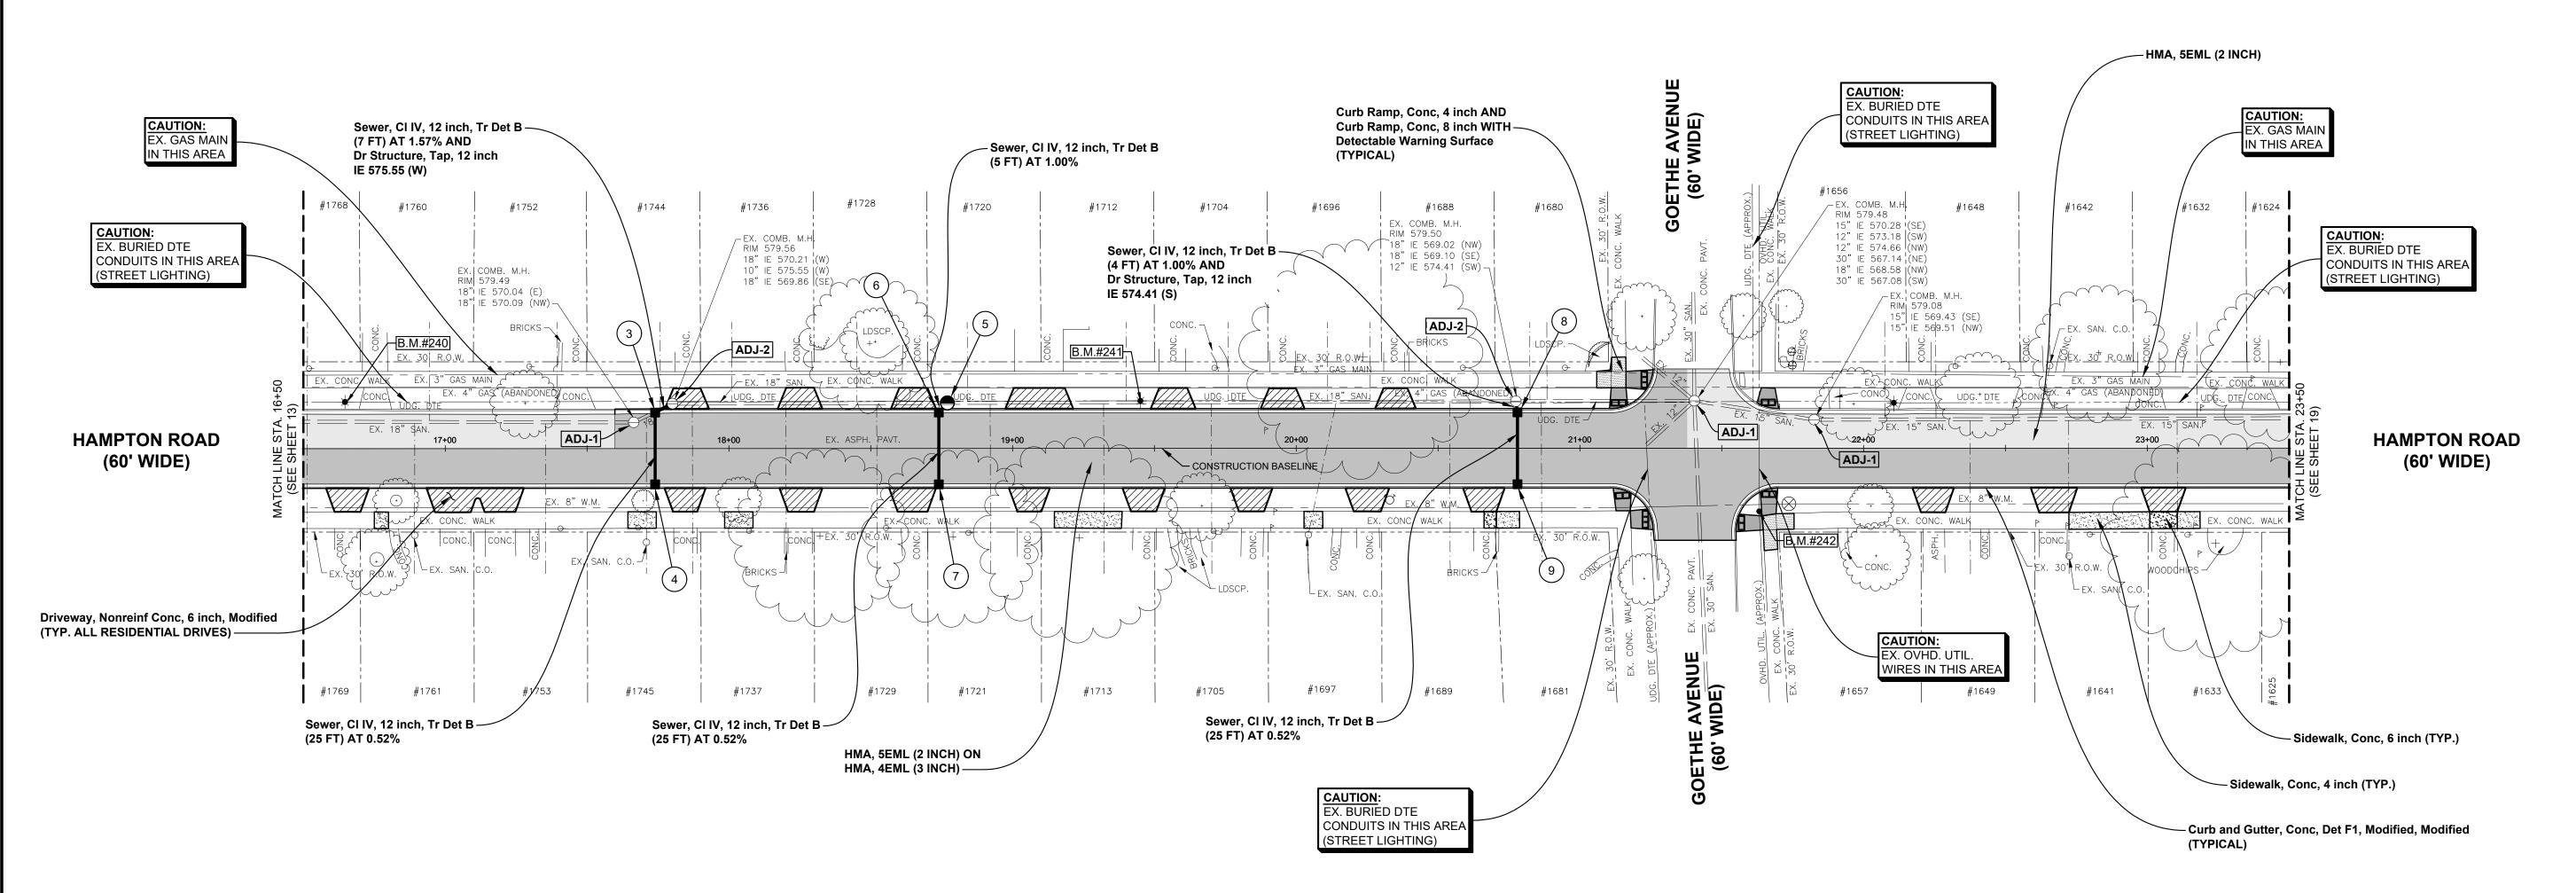
 51301 Schoenherr Road
 Phone 586 726 1234

 Shelby Township
 Fax 586 726 8780

 Michigan 48315

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ENGINEERING STRONG COMMUNITIES



# ESTIMATED QUANTITIES (THIS SHEET)

4 Ea

1. Dr Structure Cover, Adj, Case 1

	-	
<ol><li>Dr Structure Cover,</li></ol>	Adj, Case 2	1Ea
<ol><li>Dr Structure, 24 inch</li></ol>	n dia	3 Ea
4. Dr Structure, 48 inch	n dia	4 Ea
<ol><li>Dr Structure Trap, 1.</li></ol>	2 inch	3 Ea
6. Dr Structure, Tap, 1	2 inch	2 Ea
<ol> <li>External Structure V</li> </ol>	√rap, 18 inch	10 Ea
<ol><li>Catch Basin Cover,</li></ol>	Restricted, GPW	6 Ea
9. Combined Manhole	Cover, GPW	6 Ea
10. Sewer, Cl IV, 12 inc	h, Tr Det B	91 Ft
11. Aggregate Base, 6 i	nch	298 Syd
12. Aggregate Base, 11	inch	84 Syd
13. Aggregate Base, Co	onditioning	1,593 Syd
14. Driveway, Nonreinf	Conc, 6 inch, Modified	241 Syd
15. HMA, 4EML		263 Ton
16. HMA, 5EML		226 Ton
17. Curb and Gutter, Co	nc, Det F1, Modified	1,028 Ft
18. Curb Ramp, Conc, 4	l inch	30 Sft
19. Curb Ramp, Conc, 8	3 inch	327 Sft
20. Detectable Warning	Surface	35 Ft
21. Sidewalk, Conc, 4 ir	nch	590 Sft
22. Sidewalk, Conc, 6 ir		83 Sft
23. Curb Ramp Opening		42 Ft

BENCH MARK #242
NAIL IN NORTH FACE OF
UTILITY POLE AT SOUTHEAST
CORNER GOETHE AVE. &
HAMPTON RD.
ELEVATION: 580.94 (NAVD88)

DATE SUBMITTALS/REVISIONS

PROJECT NAME:

HAMPTON ROAD
WATER MAIN &
RESURFACING
(MACK AVE. TO MARTER RD.)

SHEET TITLE:

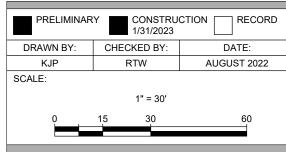
PAVEMENT

STA. 16+50 TO STA. 23+50

CONSTRUCTION

**PLAN** 

CITY OF GROSSE POINTE WOODS





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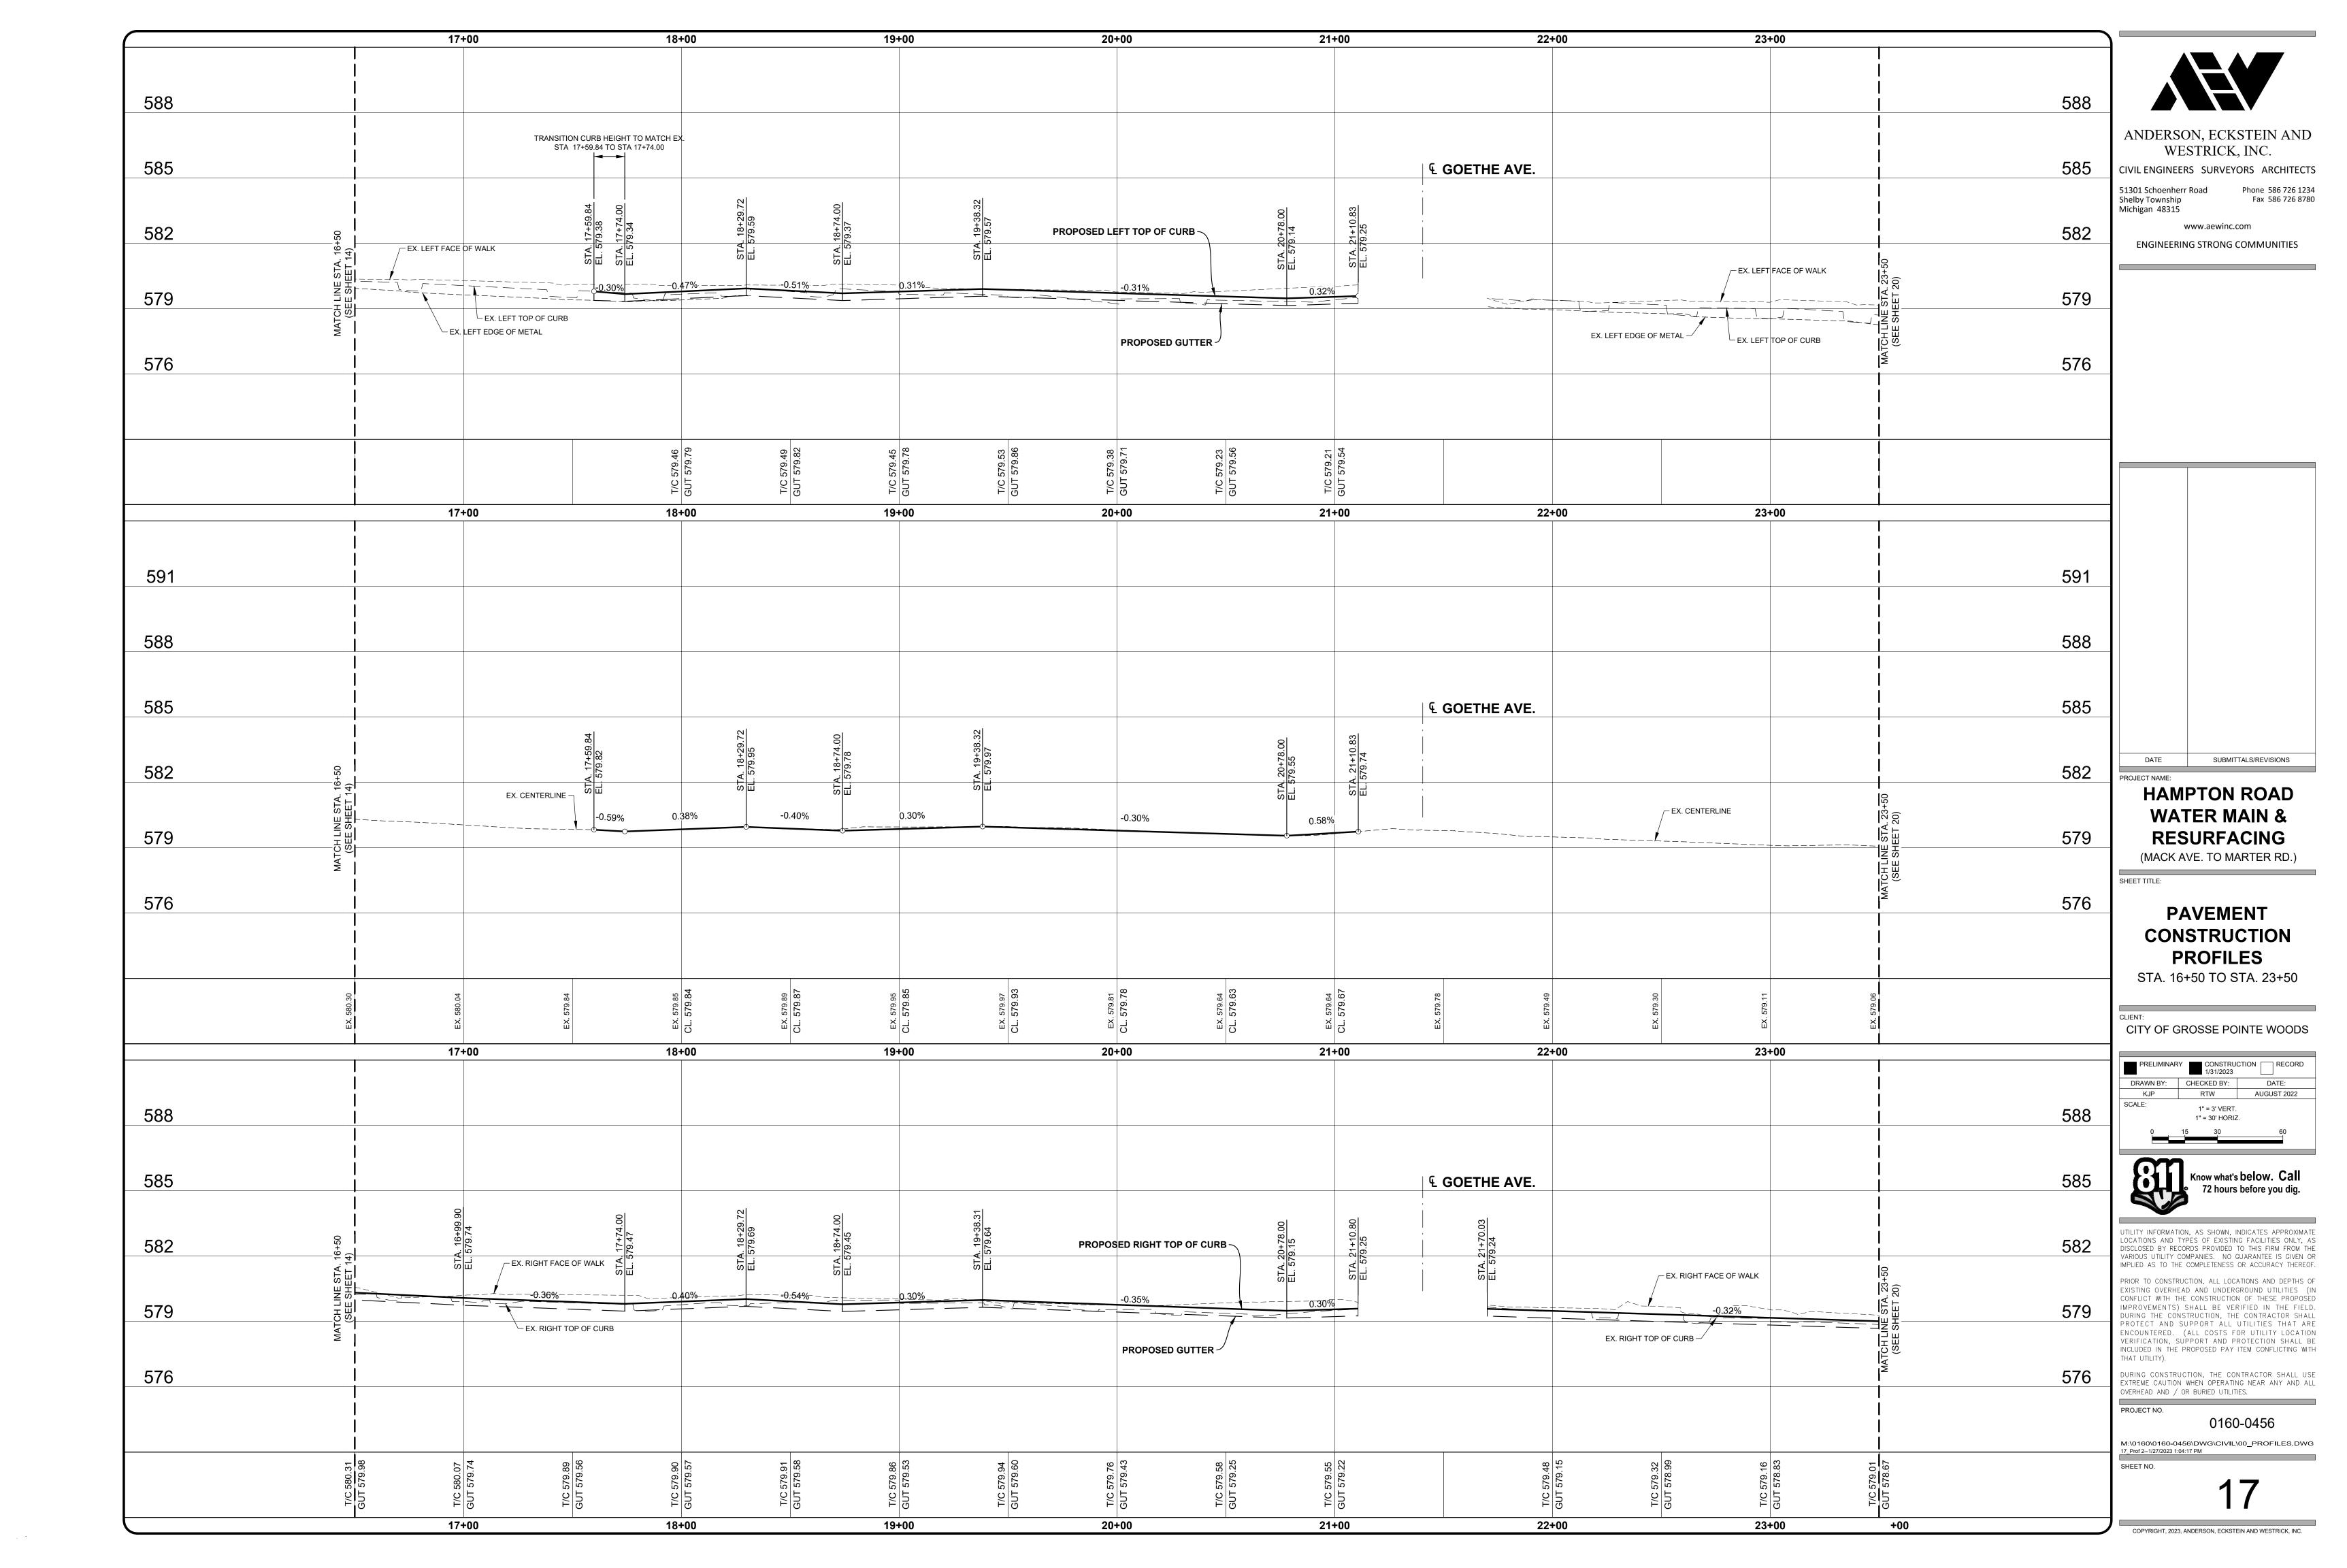
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PROJECT NO.

0160-0456

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6



12.6' MH 40UT UOUS

BENCH MARK #243 CHIS "X" ON SOUTHWEST BOLT LIGHT POLE AT HSE. #1512. ELEVATION: 579.09 (NAVD88)

ROAD CB
4" DECIDU
6" DECIDU
8" DECIDU
12" DECIDUO
COMBINED

15.9' 37.0' 39.8'

12" 12" SAN

28+28.1 ROAD CB 13.8' 28+30.5 3' DIA BUSH 4 28+31.1 3' DIA BUSH 4 28+32.5 3' DIA BUSH 4 28+32.5 3' DIA BUSH 4



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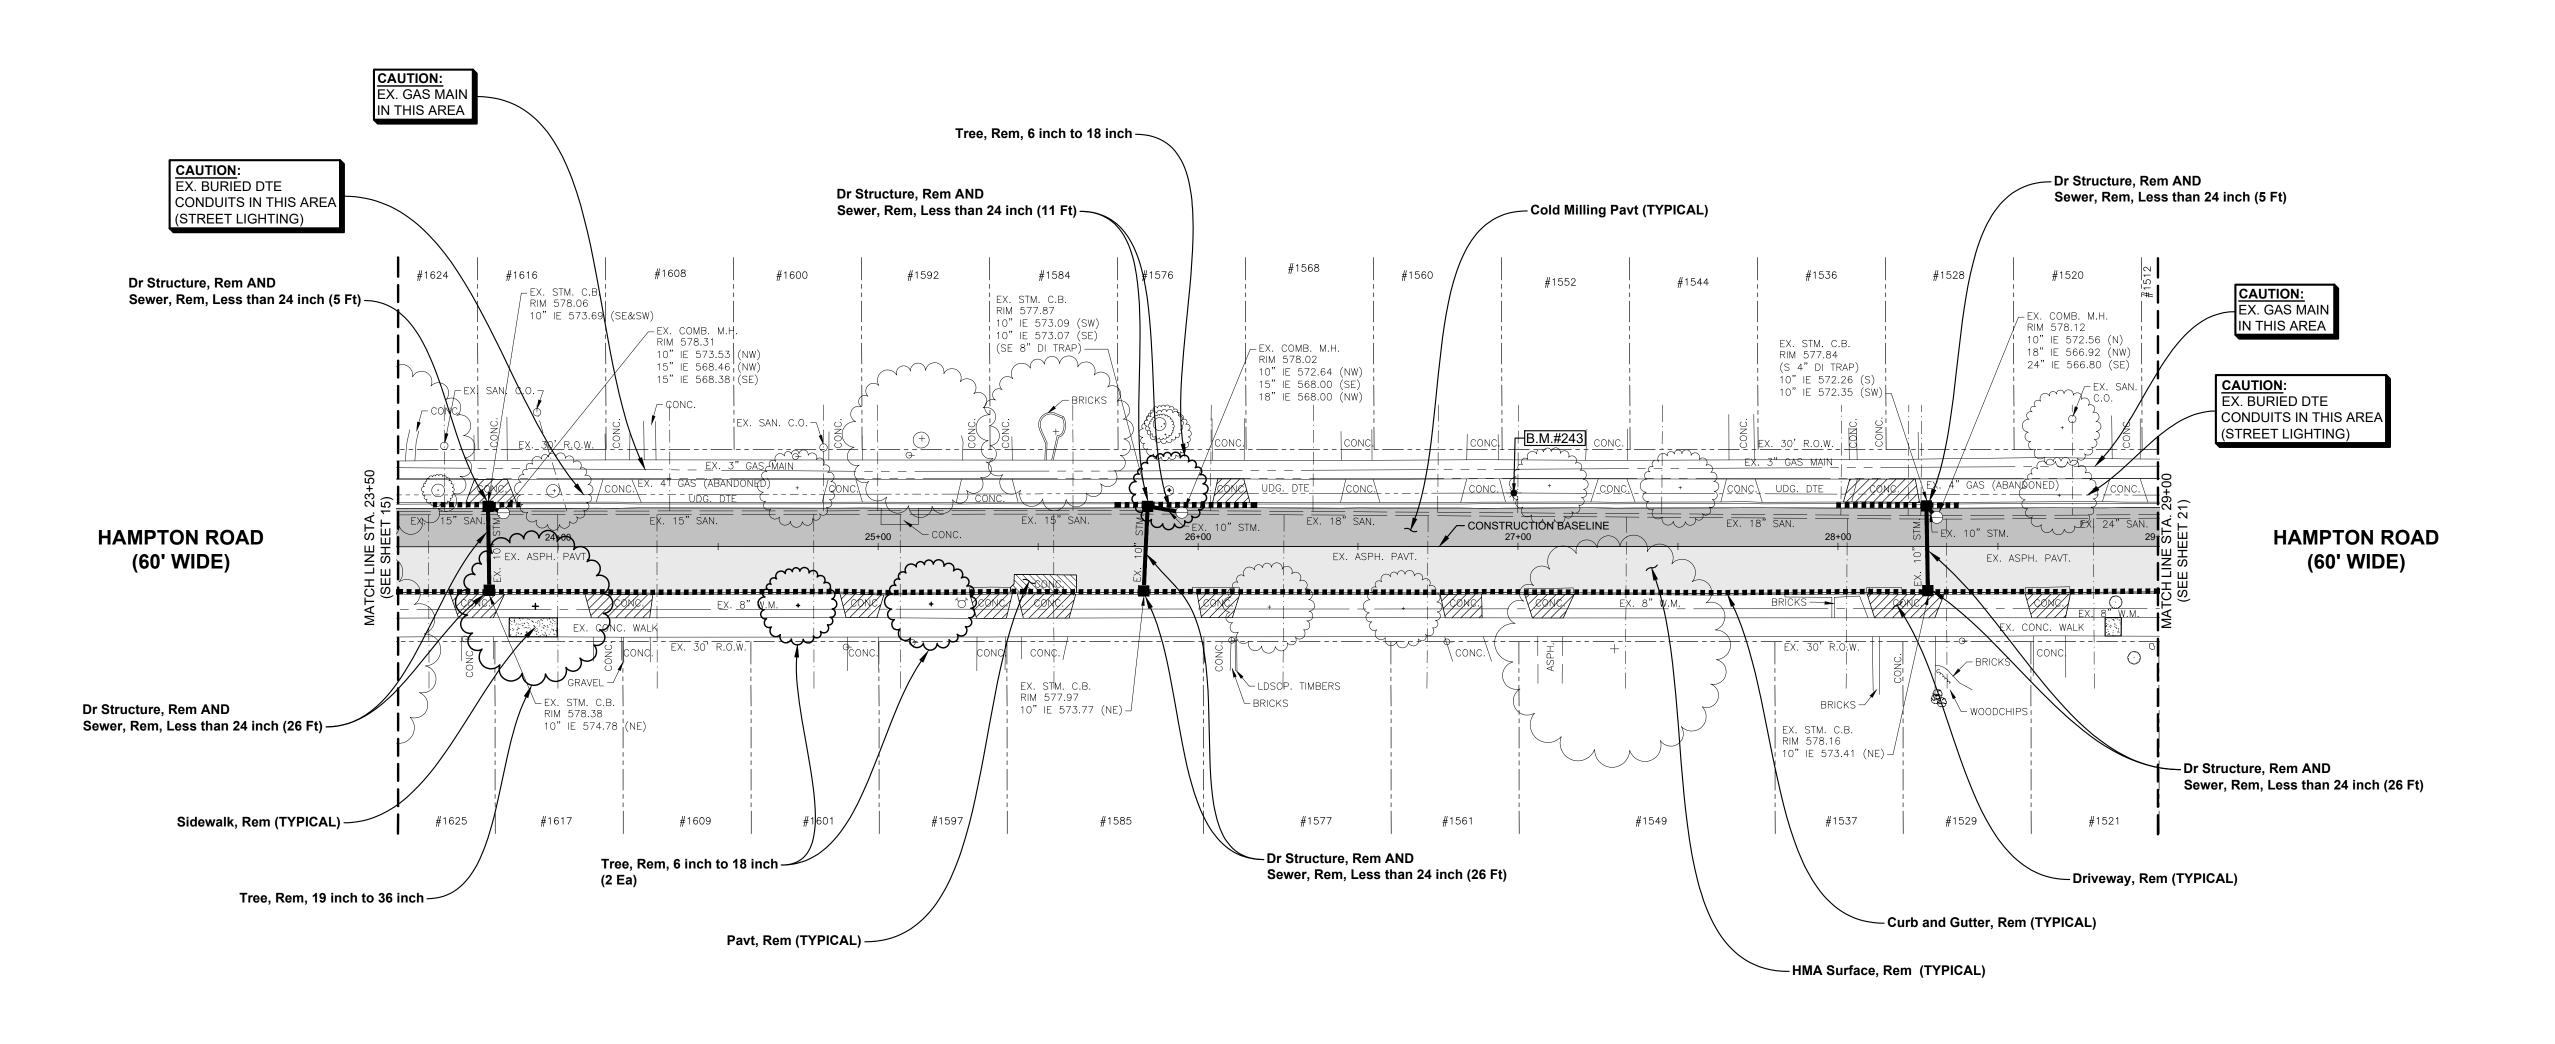
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Phone 586 726 1234 51301 Schoenherr Road Shelby Township Michigan 48315

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Fax 586 726 8780



#### **ESTIMATED QUANTITIES** (THIS SHEET)

1.	Pavt, Rem	13	Syd
2.	HMA Surface, Rem	870	Syd
3.	Cold Milling Pavt	735	Syd
4.	Curb and Gutter, Rem	660	Ft
5.	Sidewalk, Rem	14	Syd
6.	Driveway, Rem	154	Syd
7.	Dr Structure, Rem	6	Ea
8.	Sewer, Rem, Less than 24 inch	99	Ft
9.	Tree, Rem, 6 inch to 18 inch	3	Ea
0.	Tree, Rem, 19 inch to 36 inch	1	Ea

SUBMITTALS/REVISIONS

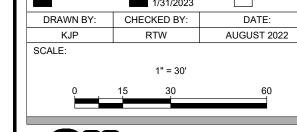
#### **HAMPTON ROAD** WATER MAIN & **RESURFACING**

(MACK AVE. TO MARTER RD.)

SHEET TITLE:

#### **REMOVAL PLAN** STA. 23+50 TO STA. 29+00

CITY OF GROSSE POINTE WOODS





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PROJECT NO. 0160-0456

M:\0160\0160-0456\DWG\CIVIL\00\_REMOVAL.DWG 18\_Rem 3--1/30/2023 4:54:16 PM SHEET NO.

Dr Structure, 48 inch dia WITH 2' SUMP AND Dr Structure Trap, 12 inch AND External Structure Wrap, 18 inch AND Catch Basin Cover, Restricted, GPW STA. 23+78.13, 12.7' LT. RIM 577.98 12" IE 574.50 (SE)

11 Dr Structure, 24 inch dia

WITH 2' SUMP AND

RIM 578.55

12" IE 574.86 (N)

STA. 23+90.00, 12.7' RT.

Dr Structure Trap, 12 inch AND

External Structure Wrap, 18 inch AND

Catch Basin Cover, Restricted, GPW

12.6 MH JOUT JOUS

Dr Structure, 48 inch dia WITH 2' SUMP AND Dr Structure Trap, 12 inch AND External Structure Wrap, 18 inch AND Catch Basin Cover, Restricted, GPW STA. 25.84.00, 12.5' LT. RIM 577.84 12" IE 572.86 (SE) 12" IE 574.00 (S)

ROAD CB
4" DECIDU
6" DECIDU
2" DECIDUC
COMBINED

BENCH MARK #243

CHIS "X" ON SOUTHWEST BOLT LIGHT POLE AT HSE. #1512.

ELEVATION: 579.09 (NAVD88)

Dr Structure, 48 inch dia WITH 2' SUMP AND Dr Structure Trap, 12 inch AND External Structure Wrap, 18 inch AND Catch Basin Cover, Restricted, GPW STA. 25.84.00, 12.5' LT. RIM 577.90 12" IE 572.61 (SE)

Dr Structure, 24 inch dia WITH 2' SUMP AND

STA. 28+27.38, 12.7' RT.

RIM 578.22

ROAD CB 13.8 3, DIA BUSH 3, DIA BUSH 3, DIA BUSH SERVICESHUTOI

12" IE 574.44 (NE)

Dr Structure Trap, 12 inch AND

External Structure Wrap, 18 inch AND

Catch Basin Cover, Restricted, GPW

15.9' 37.0' 39.8'

12" 12" SAN



ANDERSON, ECKSTEIN AND WESTRICK, INC.

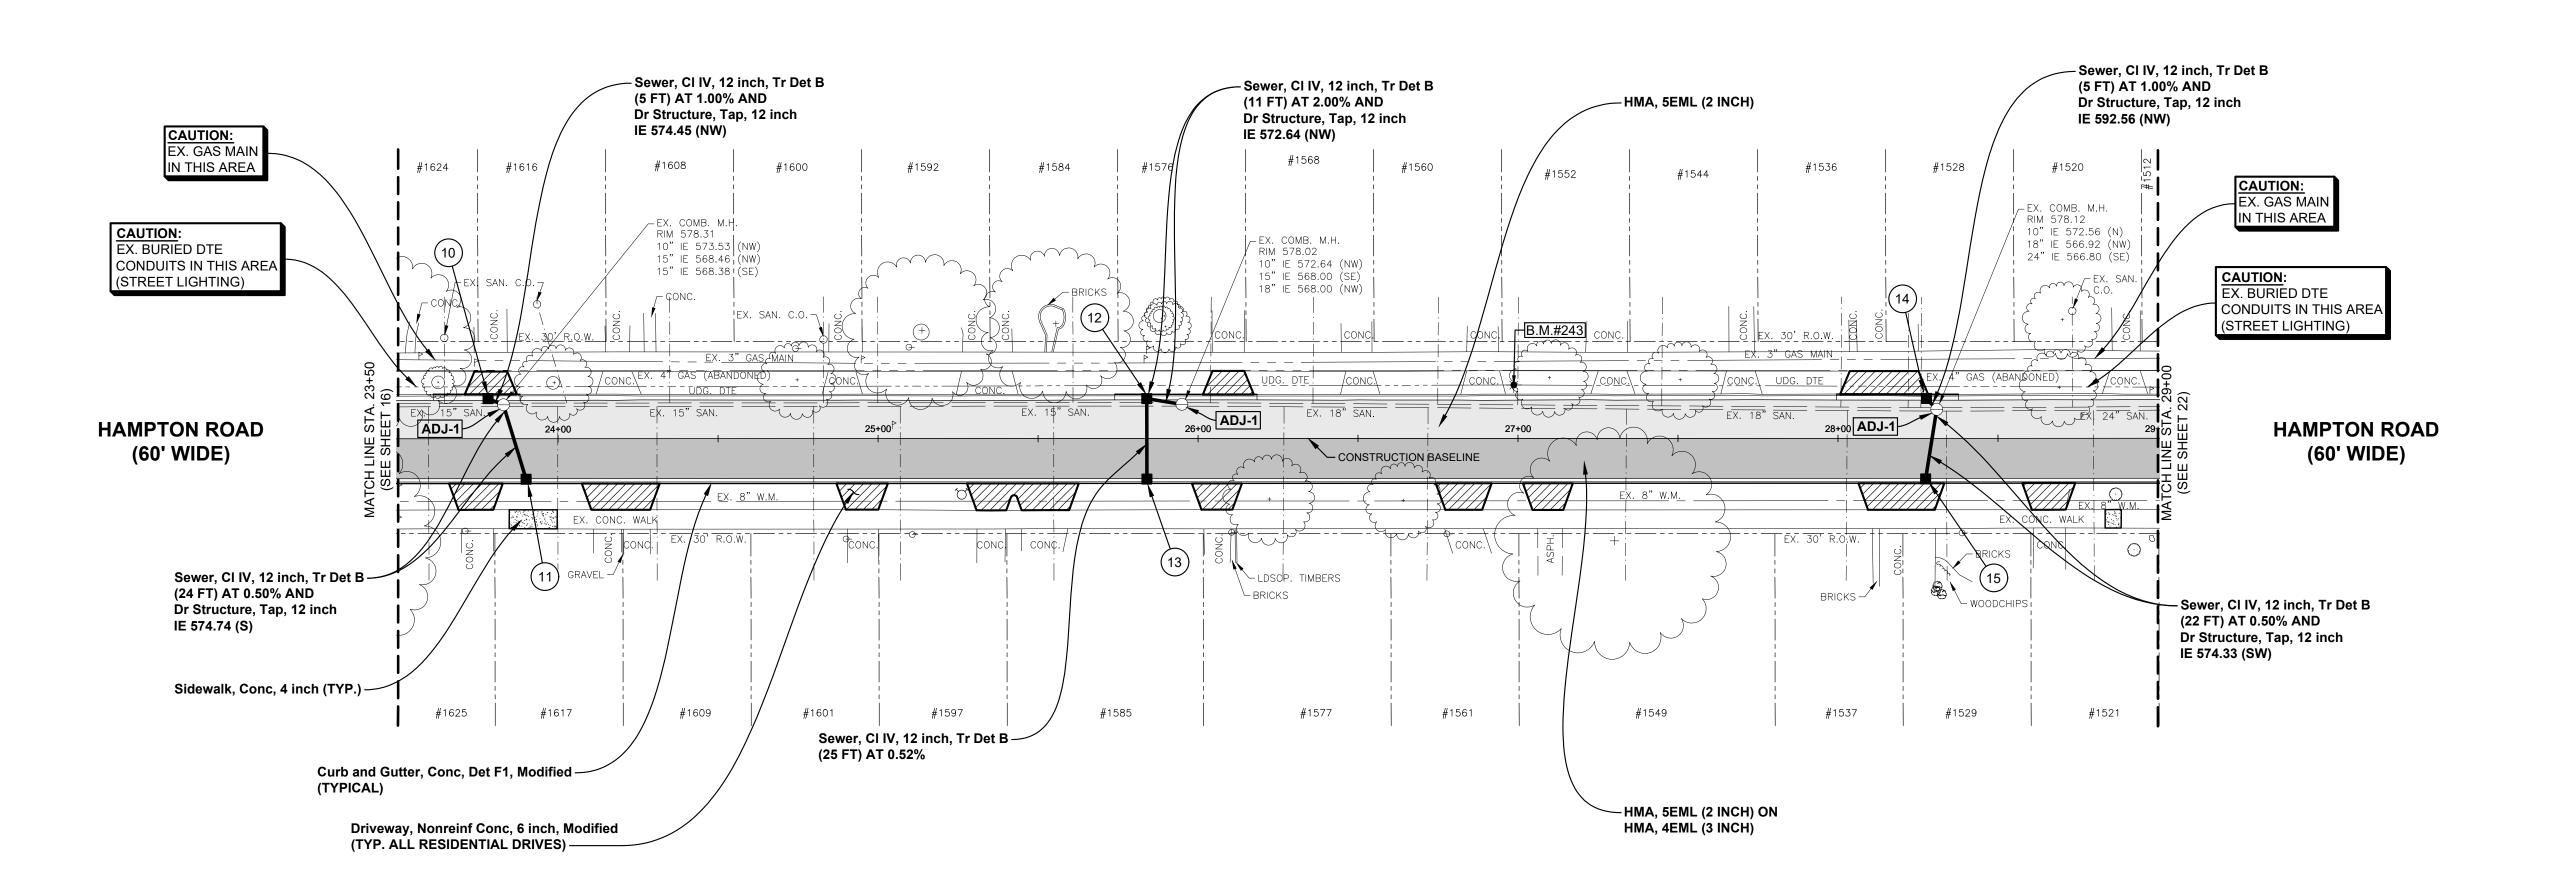
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ENGINEERING STRONG COMMUNITIES



Dr Structure, 24 inch dia WITH 2' SUMP AND

RIM 578.11

12" IE 574.13 (N)

Dr Structure Trap, 12 inch AND

STA. 25+84.00, 12.7' RT.

External Structure Wrap, 18 inch AND

Catch Basin Cover, Restricted, GPW

# **ESTIMATED QUANTITIES**

LOTHINATED GOARTHIEG	
(THIS SHEET)	
1. Dr Structure Cover, Adj, Case 1	3 Ea
2. Dr Structure, 24 inch dia	3 Ea
3. Dr Structure, 48 inch dia	3 Ea
4. Dr Structure Trap, 12 inch	5 Ea
5. Dr Structure, Tap, 12 inch	5 Ea
6. External Structure Wrap, 18 inch	9 Ea
7. Catch Basin Cover, Restricted, GPW	6 Ea
8. Combined Manhole Cover, GPW	3 Ea
9. Sewer, Cl IV, 12 inch, Tr Det B	92 Ft
10. Aggregate Base, 6 inch	216 Syd
11. Aggregate Base 11, inch	84 Syd
12. Aggregate Base, Conditioning	764 Syd
13. Driveway, Nonreinf Conc, 6 inch, Modified	185 Syd
14. HMA, 4EML	126 Toi
15. HMA, 5EML	165 Toı
16. Curb and Gutter, Conc, Det F1, Modified	660 Ft
17. Sidewalk, Conc, 4 inch	118 Sft

SUBMITTALS/REVISIONS

**HAMPTON ROAD WATER MAIN & RESURFACING** 

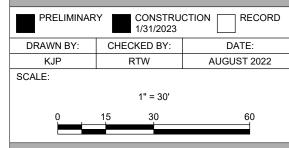
(MACK AVE. TO MARTER RD.)

SHEET TITLE:

#### **PAVEMENT** CONSTRUCTION **PLAN**

STA. 23+50 TO STA. 29+00

CITY OF GROSSE POINTE WOODS





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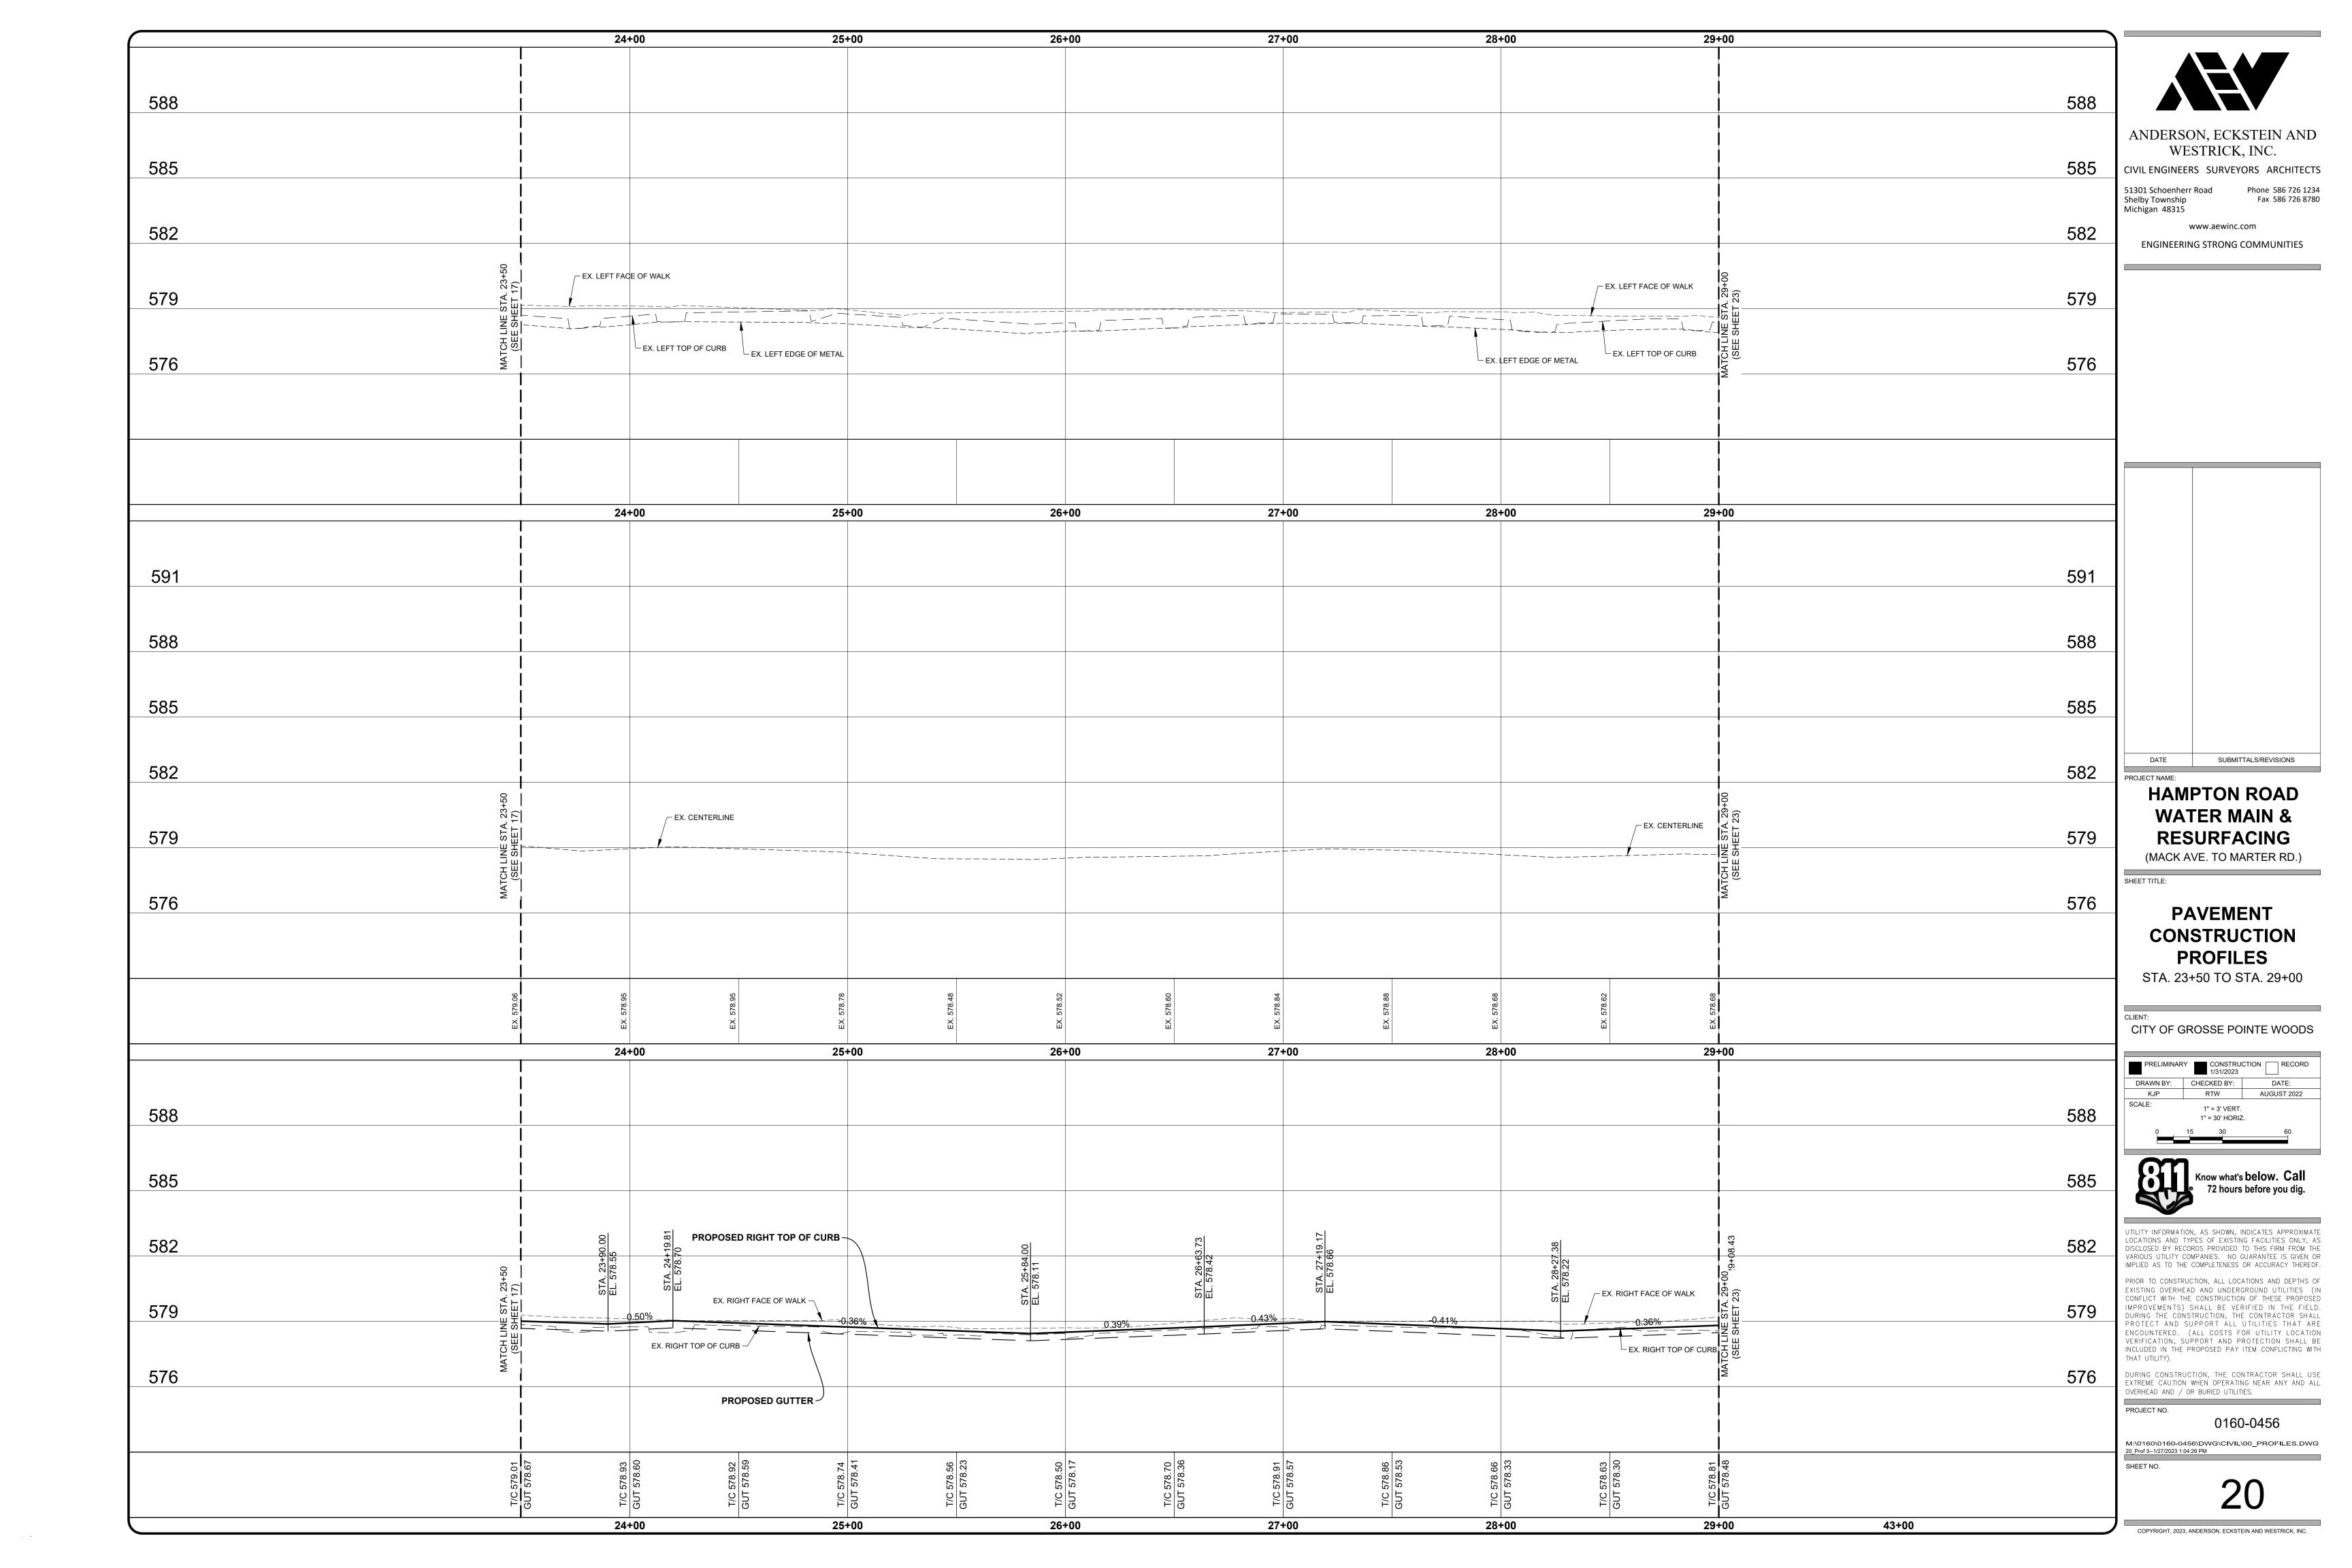
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OVERHEAD AND / OR BURIED UTILITIES. PROJECT NO.

0160-0456

M:\0160\0160-0456\DWG\CIVIL\00\_RESURF.DWG 19\_Resurf 3--1/30/2023 4:53:27 PM SHEET NO.



29+548 UGHT POLE 15.8\*
29+548 UGHT POLE 15.8\*
29+548 UGHT POLE 15.8\*
29+658 COMBINED MH 9.8\*
30+23.5 14" DEDDUOUS 15.5"
30+23.5 SERNESHUTOFF 29.0\*
30+23.5 14" DEDDUOUS 17.8"
30+52.5 SERNESHUTOFF 29.0\*
30+52.5 SERNESHUTOFF 29.0\*
30+31.9 COMBINED MH 9.8\*
30+31.9 COMBINED MH 14.3"
31+30.1 12" DECDUOUS 17.8\*

BENCH MARK #244
CHIS "X" ON SOUTHWEST BOLT
LIGHT POLE AT HSE. #1450.
ELEVATION: 578.98 (NAVD88)



ANDERSON, ECKSTEIN AND WESTRICK, INC.

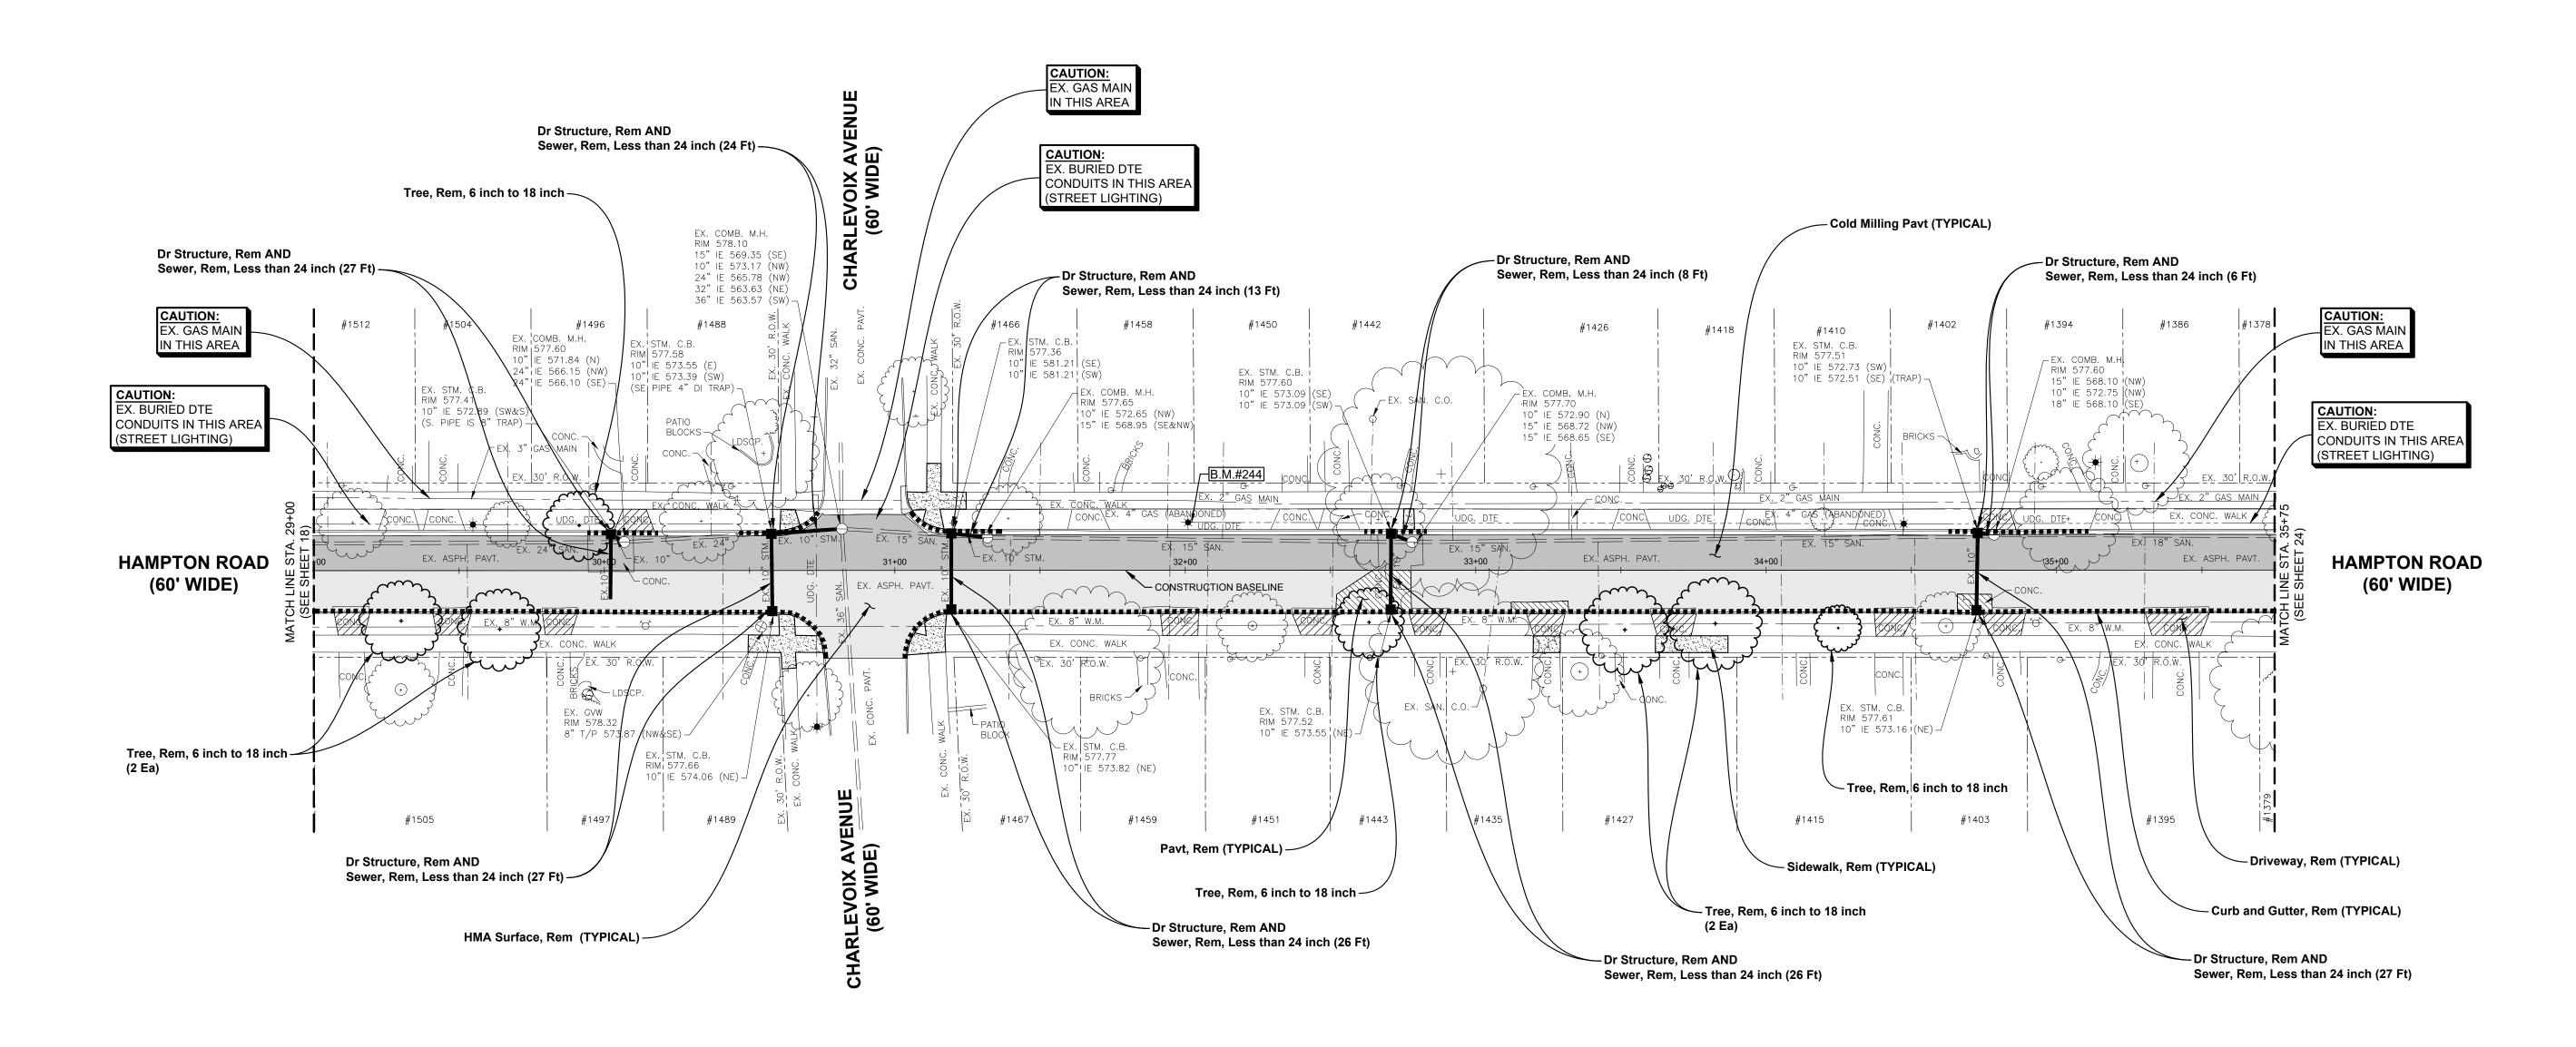
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Shelby Township
Michigan 48315

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Fax 586 726 8780



31.7, 38.6, 24.6, 29.2, 29.1,

DDAY.

# ESTIMATED QUANTITIES (THIS SHEET)

(11110-011221)		
1. Pavt, Rem	52	Syd
2. HMA Surface, Rem	1,092	Syd
<ol><li>Cold Milling Pavt</li></ol>	941	Syd
4. Curb and Gutter, Rem	823	Ft
5. Sidewalk, Rem	90	Syd
<ol><li>Driveway, Rem</li></ol>	133	Syd
7. Dr Structure, Rem	9	Ea
8. Sewer, Rem, Less than 24 inch	184	Ft
9. Tree, Rem, 6 inch to 18 inch	7	Ea

DATE SUBMITTALS/REVISIONS
PROJECT NAME:
HAMPTON ROAD

WATER MAIN & RESURFACING (MACK AVE. TO MARTER RD.)

SHEET TITLE:

REMOVAL PLAN STA. 29+00 TO STA. 35+75

CLIENT:
CITY OF GROSSE POINTE WOODS

PRELIMINARY CONSTRUCTION RECORD

1/31/2023

DRAWN BY: CHECKED BY: DATE:

KJP RTW AUGUST 2022

SCALE:

1" = 30'

0 15 30 60



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PROJECT NO. 0160-0456

M:\0160\0160-0456\DWG\CIVIL\00\_REMOVAL.DWG 21\_Rem 4--1/30/2023 4:54:18 PM SHEET NO.

21

Dr Structure, 24 inch dia
WITH 2' SUMP AND
Dr Structure Trap, 12 inch AND
External Structure Wrap, 18 inch AND
Catch Basin Cover, Restricted, GPW
STA. 30+02.30, 12.4' LT.
RIM 577.36
12" IE 573.80 (SE)

Dr Structure, 48 inch dia
WITH 2' SUMP AND
Dr Structure Trap, 12 inch AND
External Structure Wrap, 18 inch AND
Catch Basin Cover, Restricted, GPW
STA. 30+56.51, 12.4' LT.
RIM 577.61
12" IE 573.66 (E)
12" IE 574.15 (S)

Dr Structure, 48 inch dia
WITH 2' SUMP AND
Dr Structure Trap, 12 inch AND
External Structure Wrap, 18 inch AND
Catch Basin Cover, Restricted, GPW
STA. 31+19.91, 12.8' LT.
RIM 577.44
12" IE 572.89 (SE)
12" IE 574.14 (S)

Dr Structure, 24 inch dia
WITH 2' SUMP AND
Dr Structure Trap, 12 inch AND
External Structure Wrap, 18 inch AND
Catch Basin Cover, Restricted, GPW
STA. 31+72.71, 12.8' LT.
RIM 577.60
12" IE 573.04 (SE)

DDAY:

Dr Structure, 24 inch dia
WITH 2' SUMP AND
Dr Structure Trap, 12 inch AND
External Structure Wrap, 18 inch AND
Catch Basin Cover, Restricted, GPW
STA. 34+72.83, 12.8' LT.
RIM 577.55
12" IE 572.87 (E)
12" IE 574.12 (S)

CHIS "X" ON SOUTHWEST BOLT LIGHT POLE AT HSE. #1450. ELEVATION: 578.98 (NAVD88)



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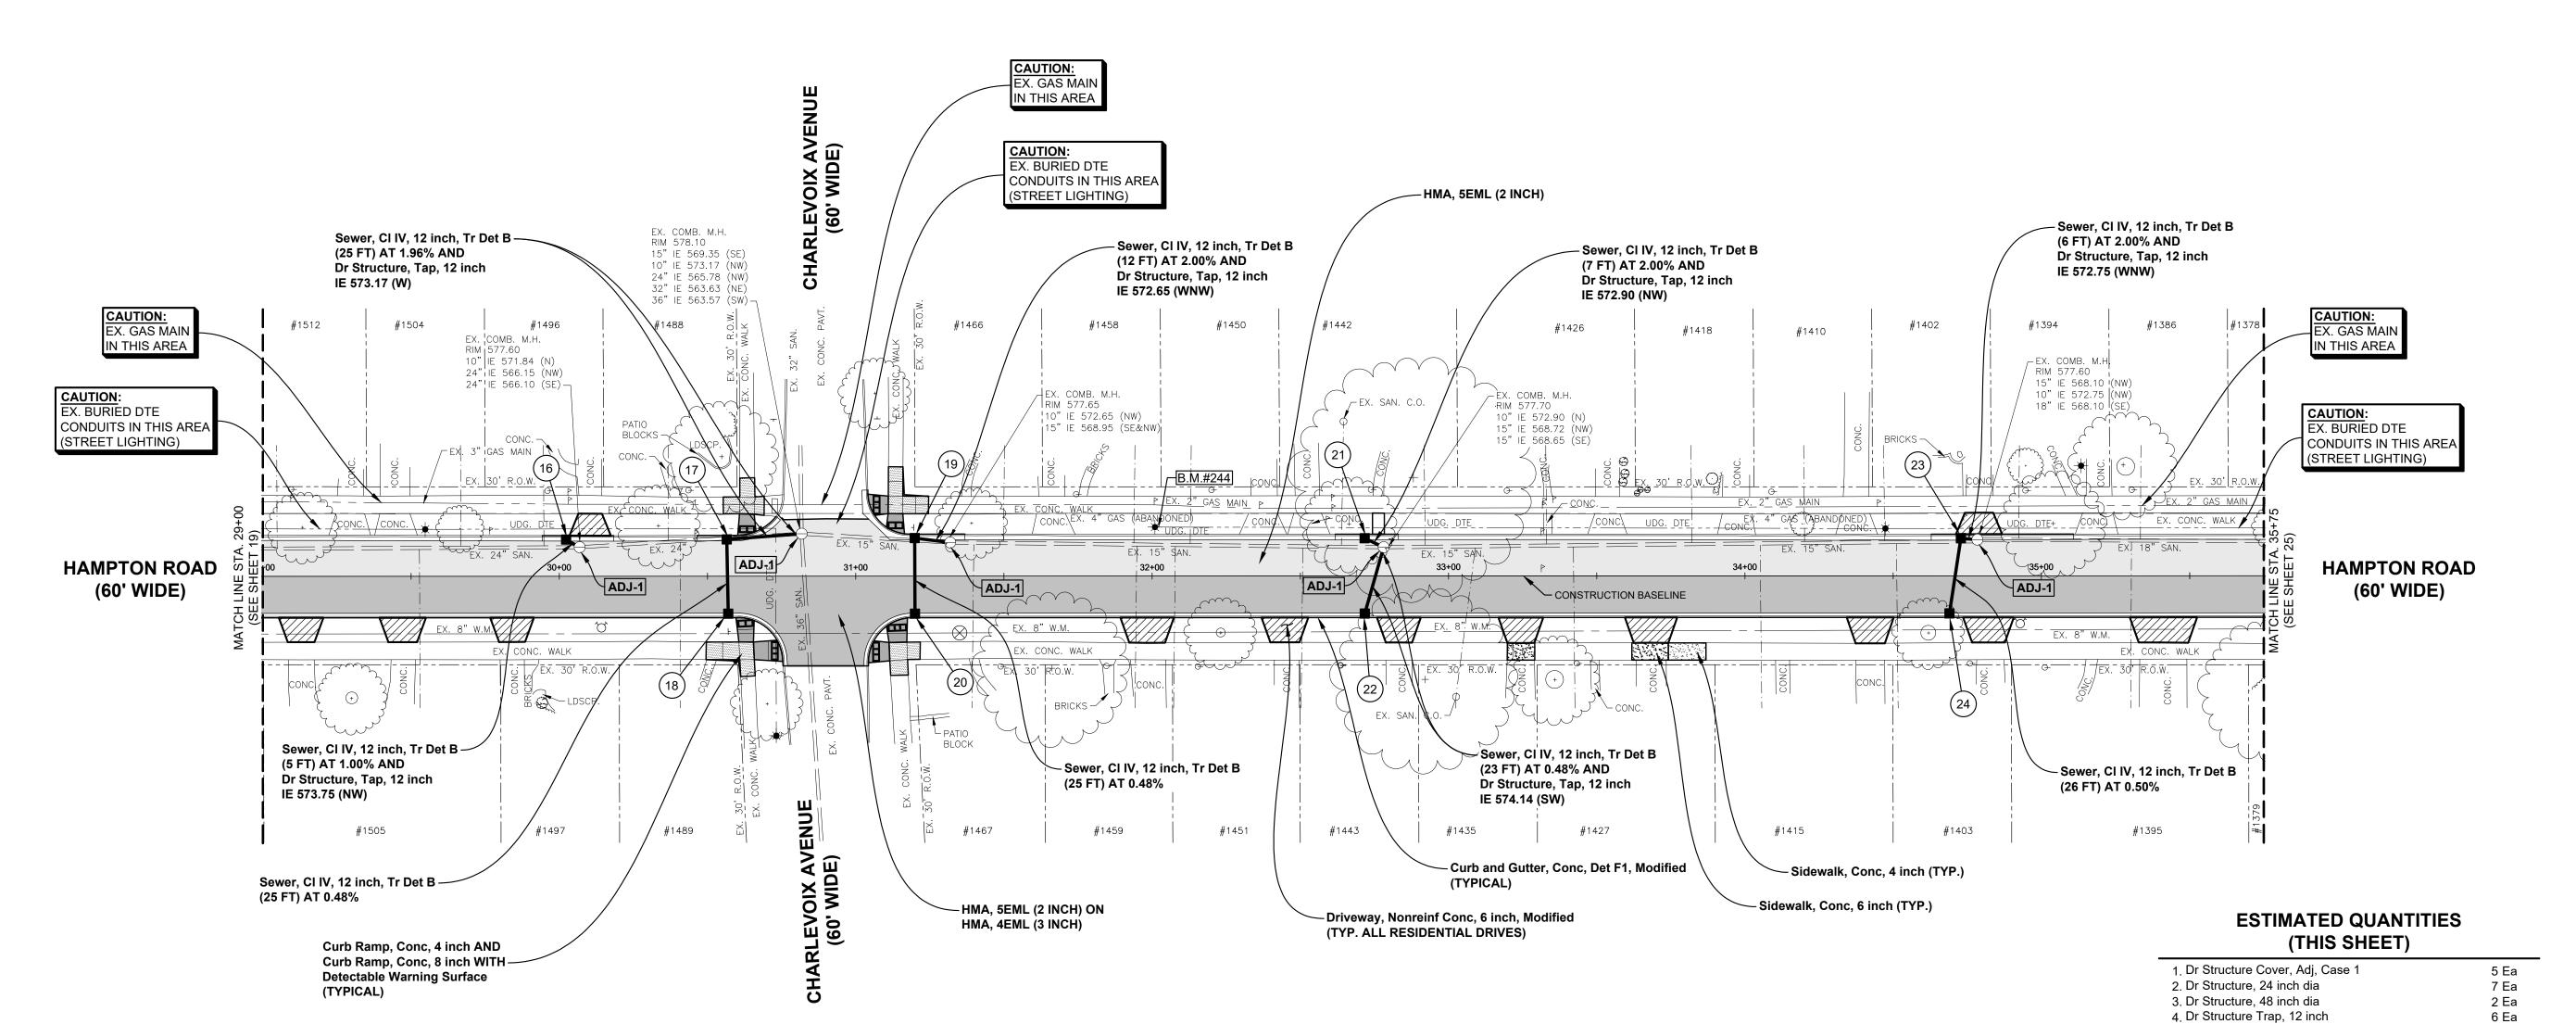
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 Shelby Township
 Fax 586 726 8780

 Michigan 48315

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Dr Structure, 24 inch dia
WITH 2' SUMP AND
Dr Structure Trap, 12 inch AND
External Structure Wrap, 18 inch AND
Catch Basin Cover, Restricted, GPW
STA. 30+57.00, 12.7' RT.
RIM 577.74
12" IE 574.27 (N)

Dr Structure, 24 inch dia
WITH 2' SUMP AND
Dr Structure Trap, 12 inch AND
External Structure Wrap, 18 inch AND
Catch Basin Cover, Restricted, GPW
STA. 31+20.00, 12.5' RT.
RIM 577.80
12" IE 574.26 (N)

Dr Structure, 24 inch dia
WITH 2' SUMP AND
Dr Structure Trap, 12 inch AND
External Structure Wrap, 18 inch AND
Catch Basin Cover, Restricted, GPW
STA. 32+71.32, 12.7' RT.
RIM 577.87
12" IE 574.25 (NE)

Dr Structure, 24 inch dia
WITH 2' SUMP AND
External Structure Wrap, 18 inch AND
Catch Basin Cover, Restricted, GPW
STA. 32+71.32, 12.7' RT.
RIM 577.76
12" IE 574.25 (N)

5. Dr Structure, Tap, 12 inch

10. Aggregate Base, 6 inch

14. HMA, 4EML

15. HMA, 5EML

11. Aggregate Base, 11 inch

17. Curb Ramp, Conc, 4 inch

18. Curb Ramp, Conc, 8 inch

20. Sidewalk, Conc, 4 inch

21. Sidewalk, Conc, 6 inch

19. Detectable Warning Surface

22. Curb Ramp Opening, Conc

12. Aggregate Base, Conditioning

6. External Structure Wrap, 18 inch

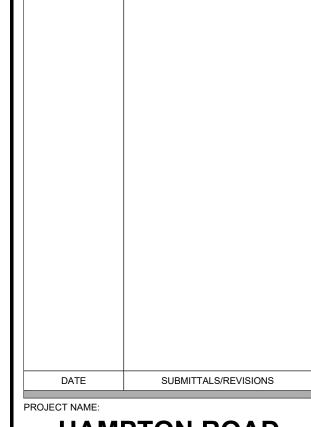
8. Combined Manhole Cover, GPW

9. Sewer, CI IV, 12 inch, Tr Det B

7. Catch Basin Cover, Restricted, GPW

13. Driveway, Nonreinf Conc, 6 inch, Modified

16. Curb and Gutter, Conc, Det F1, Modified



HAMPTON ROAD WATER MAIN & RESURFACING

(MACK AVE. TO MARTER RD.)

SHEET TITLE:

### PAVEMENT CONSTRUCTION PLAN

STA. 29+00 TO STA. 35+75

CLIENT:

6 Ea

14 Ea

9 Ea

5 Ea

117 Ft

229 Syd

145 Syd

160 Syd

165 Ton

214 Ton

289 Sft

305 Sft

35 Ft

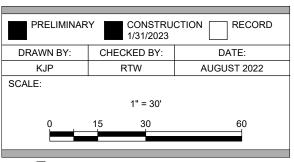
74 Sft

126 Sft

790 Ft

1,002 Syd

CITY OF GROSSE POINTE WOODS





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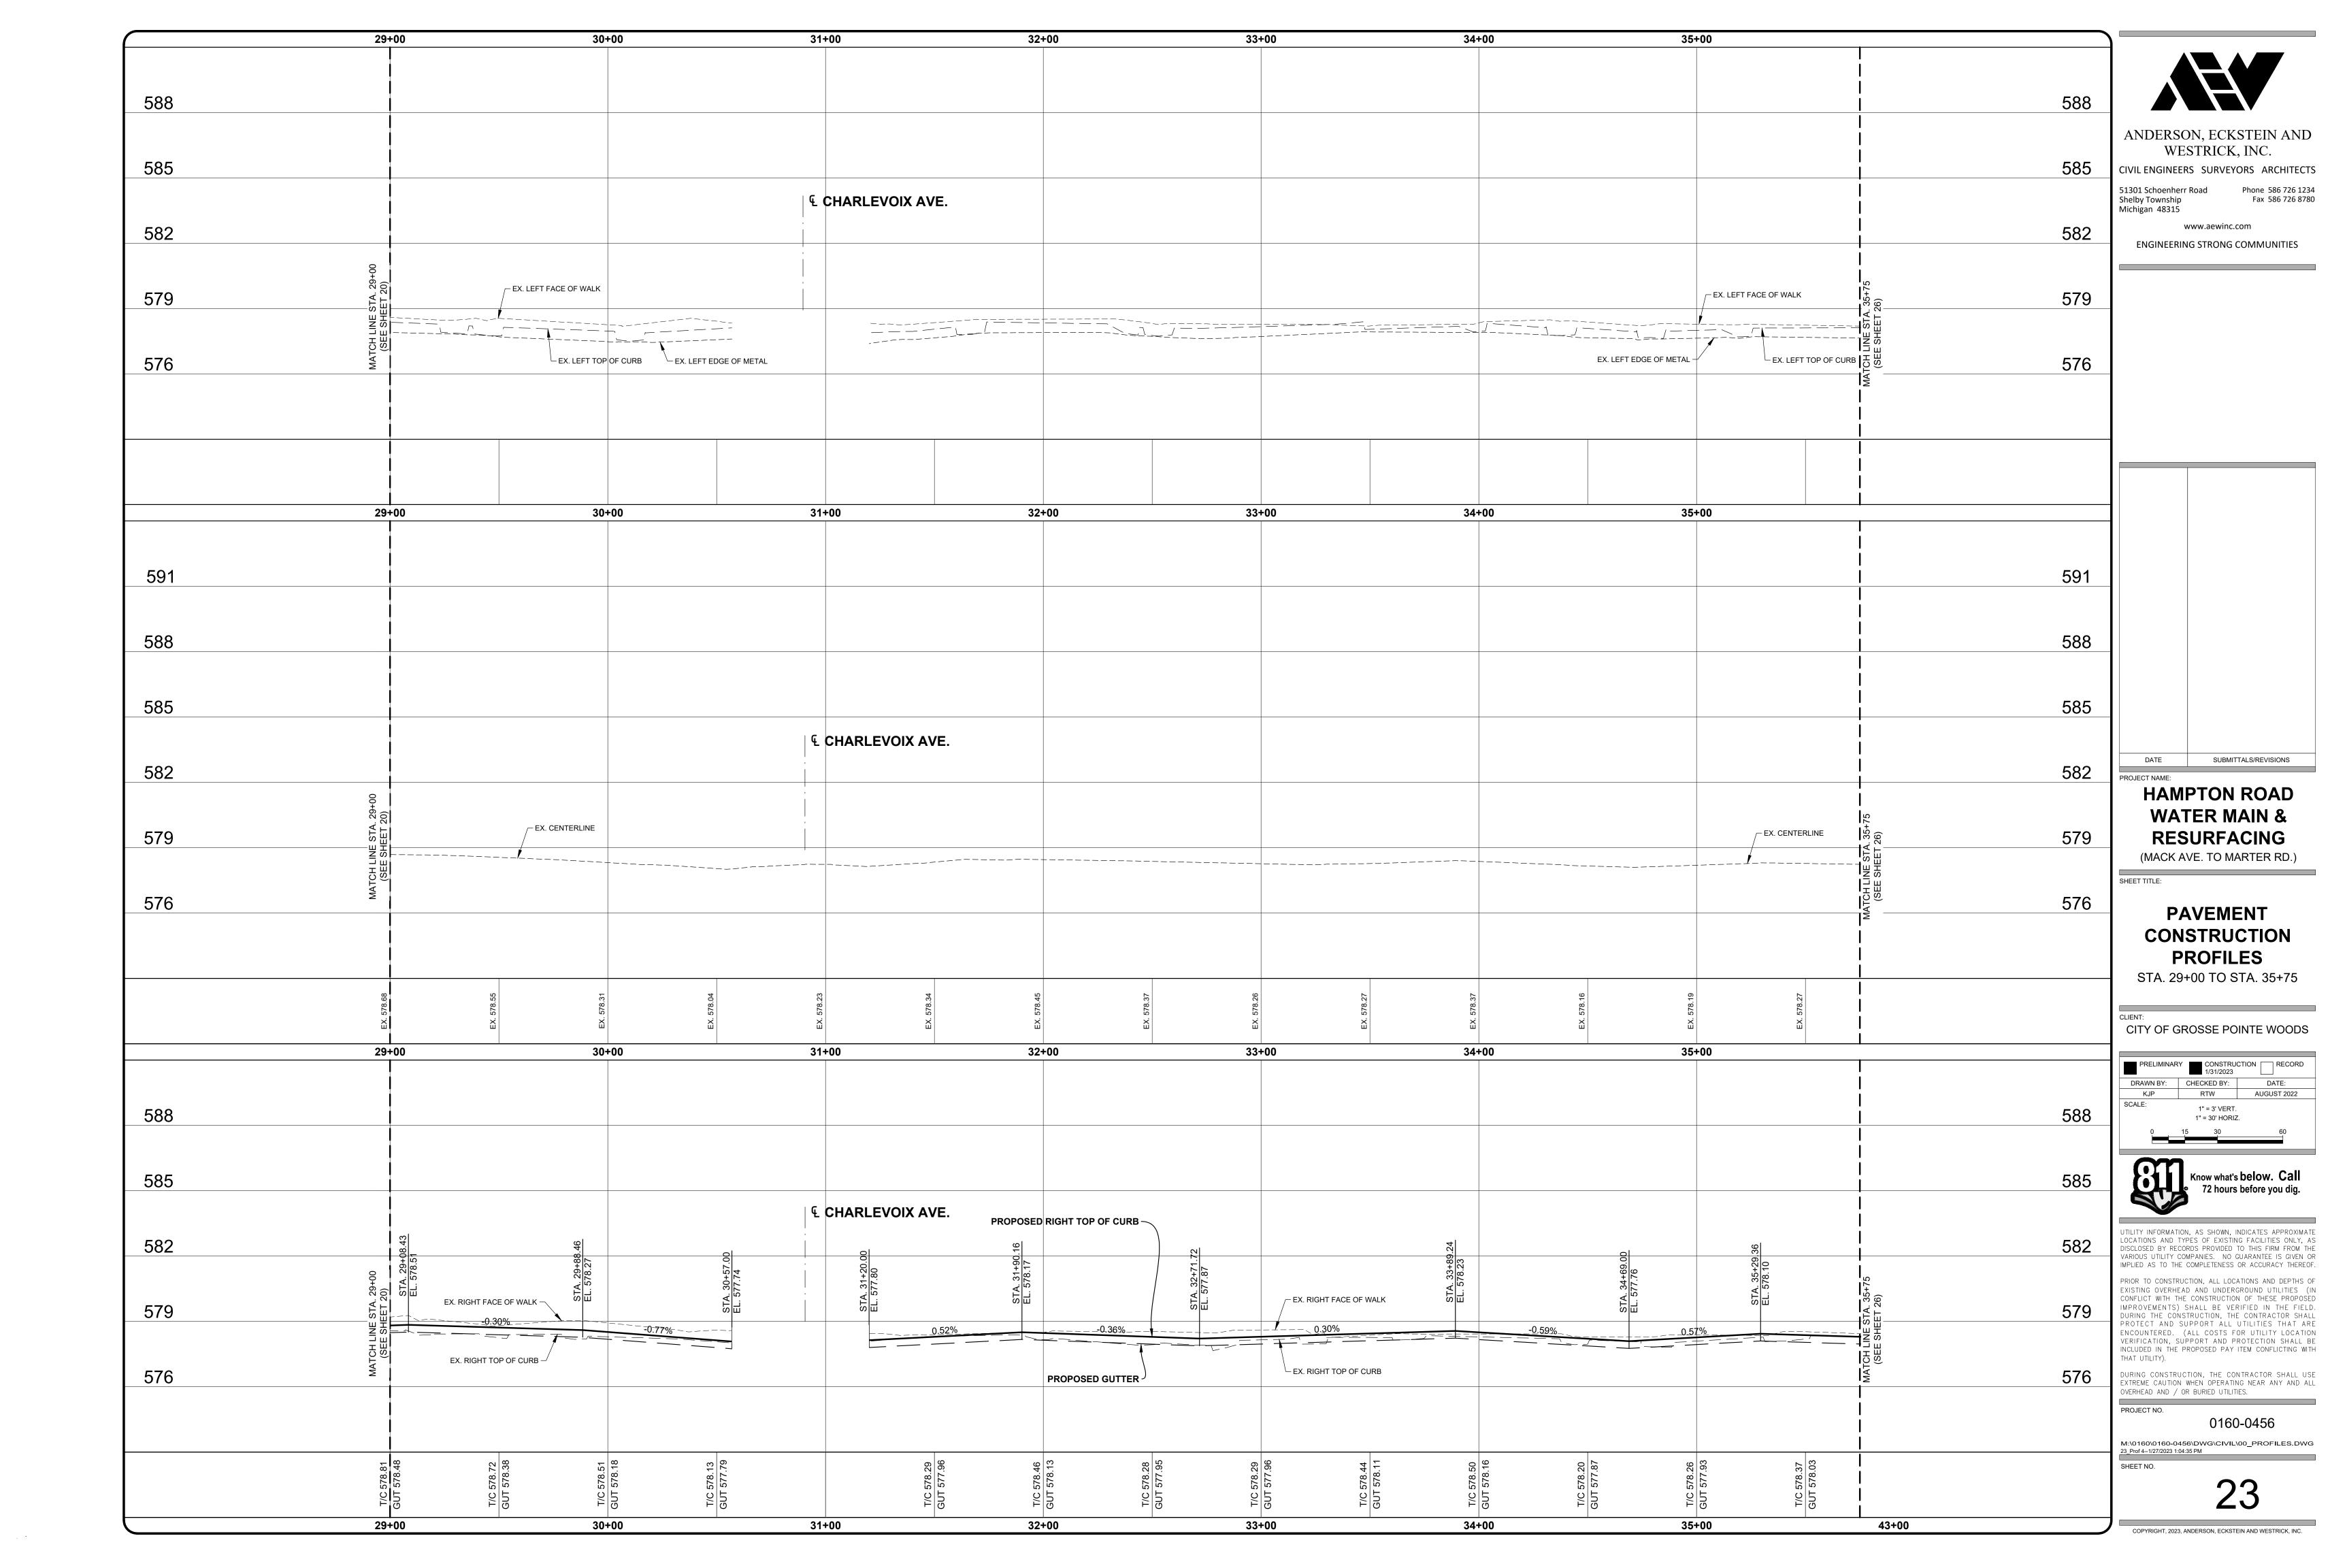
THAT UTILITY).

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PROJECT NO. 0160-0456

M:\0160\0160-0456\DWG\CIVIL\00\_RESURF.DWG 22\_Resurf 4--1/30/2023 4:53:29 PM SHEET NO.

22



BENCH MARK #246
CHIS "X" ON NORTH OF RIM
SANITARY M.H. ±15' NORTH

RHAMPTON IN GUT. LINE
OF HAMPTON RD.
ELEVATION: 578.11 (NAVD88)



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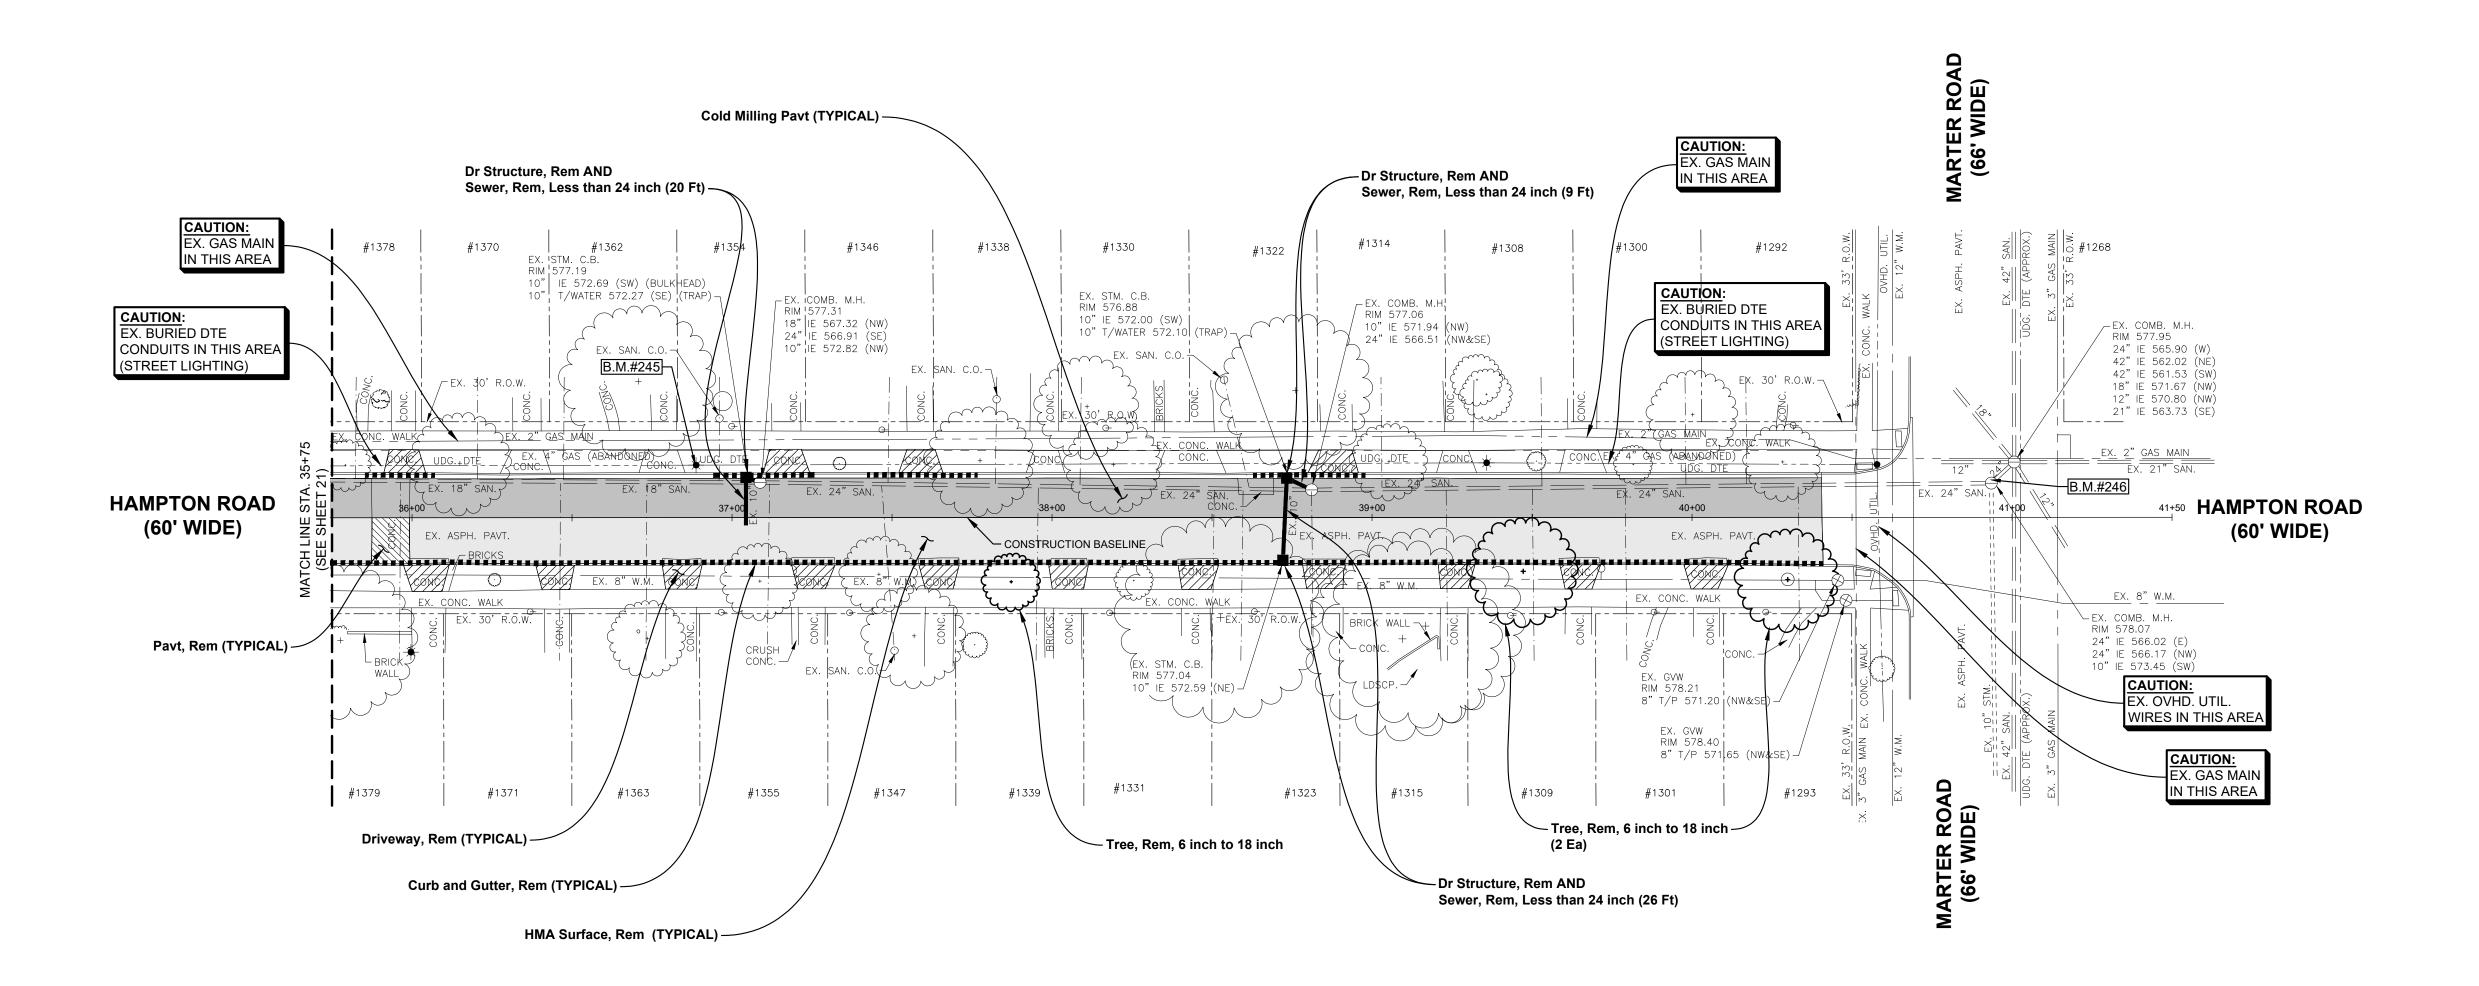
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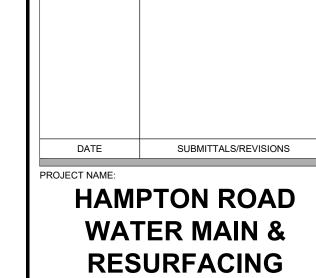
Fax 586 726 8780



39+32.8 39+35.8 39+35.8

# ESTIMATED QUANTITIES (THIS SHEET)

1. Pavt, Rem	19	Syd
2. HMA Surface, Rem	723	Syd
<ol><li>Cold Milling Pavt</li></ol>	634	Syd
4. Curb and Gutter, Rem	589	Ft
6. Driveway, Rem	141	Syd
7. Dr Structure, Rem	3	Ea
8. Sewer, Rem, Less than 24 inch	55	Ft
9. Tree, Rem, 6 inch to 18 inch	3	Ea



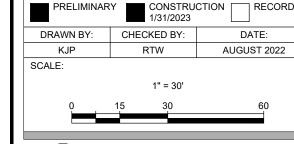
(MACK AVE. TO MARTER RD.)

SHEET TITLE:

**REMOVAL PLAN**STA. 35+75 TO MARTER RD

:NT:

CITY OF GROSSE POINTE WOODS





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THAT UTILITY).

PROJECT NO. 0160-0456

M:\0160\0160-0456\DWG\CIVIL\00\_REMOVAL.DWG 24\_Rem 5--1/30/2023 4:54:20 PM SHEET NO.

24

Dr Structure, 24 inch dia WITH 2' SUMP AND Dr Structure Trap, 12 inch AND External Structure Wrap, 18 inch AND Catch Basin Cover, Restricted, GPW STA. 37+04.00, 12.7' LT. RIM 577.21 12" IE 572.92 (SE)

Dr Structure, 24 inch dia WITH 2' SUMP AND Dr Structure Trap, 12 inch AND External Structure Wrap, 18 inch AND Catch Basin Cover, Restricted, GPW STA. 38+73.00, 12.6' LT. RIM 576.85 12" IE 572.12 (SE)

39+32.8 39+35.8 39+35.8

BENCH MARK #246 CHIS "X" ON NORTH OF RIM SANITARY M.H. ±15' NORTH € RHAMPTON IN GUT. LINE OF HAMPTON RD. ELEVATION: 578.11 (NAVD88)

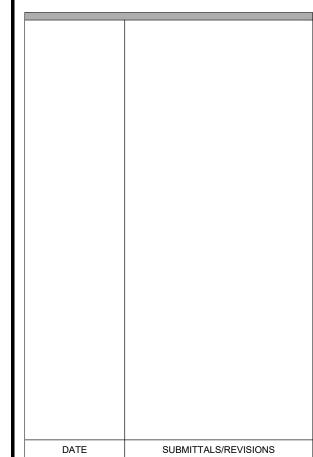


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#### **HAMPTON ROAD WATER MAIN & RESURFACING**

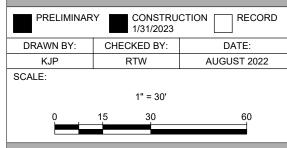
(MACK AVE. TO MARTER RD.)

SHEET TITLE:

#### **PAVEMENT** CONSTRUCTION **PLAN**

STA. 35+75 TO MARTER RD.

CITY OF GROSSE POINTE WOODS





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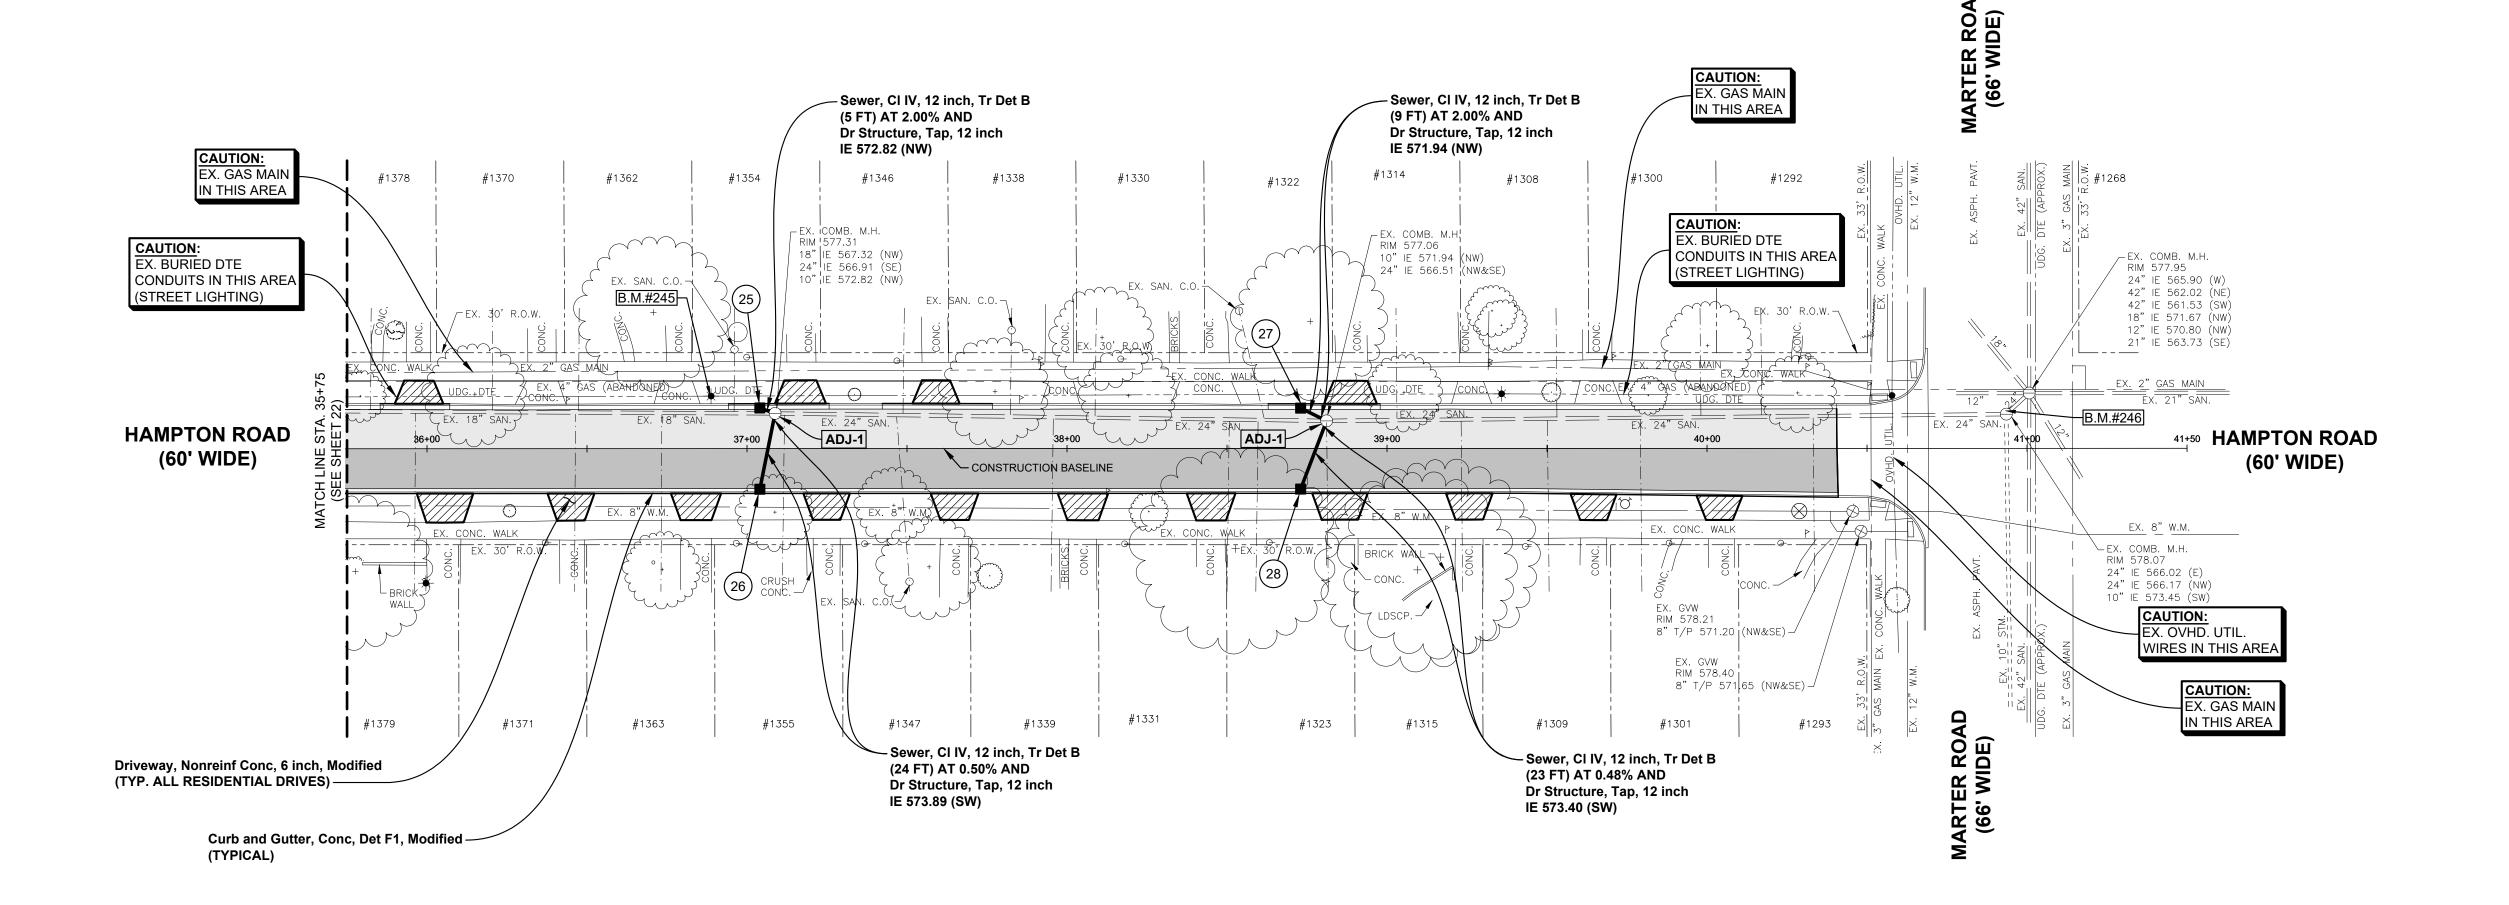
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PROJECT NO. 0160-0456

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1. Dr Structure Cover, Adj, Case 1 2 Ea 2. Dr Structure, 24 inch dia 4 Ea 3. Dr Structure Trap, 12 inch 4 Ea 4. Dr Structure, Tap, 12 inch 4 Ea 5. External Structure Wrap, 18 inch 6 Ea 6. Catch Basin Cover, Restricted, GPW 4 Ea 7. Combined Manhole Cover, GPW 2 Ea 8. Sewer, CI IV, 12 inch, Tr Det B 61 Ft 9. Aggregate Base, 6 inch 164 Syd 10. Aggregate Base, 11 inch 56 Syd 11. Aggregate Base, Conditioning 654 Syd 12. Driveway, Nonreinf Conc, 6 inch, Modified 167 Syd 108 Ton 13. HMA, 4EML 14. HMA, 5EML 142 Ton 15. Curb and Gutter, Conc, Det F1, Modified 589 Ft

**ESTIMATED QUANTITIES** 

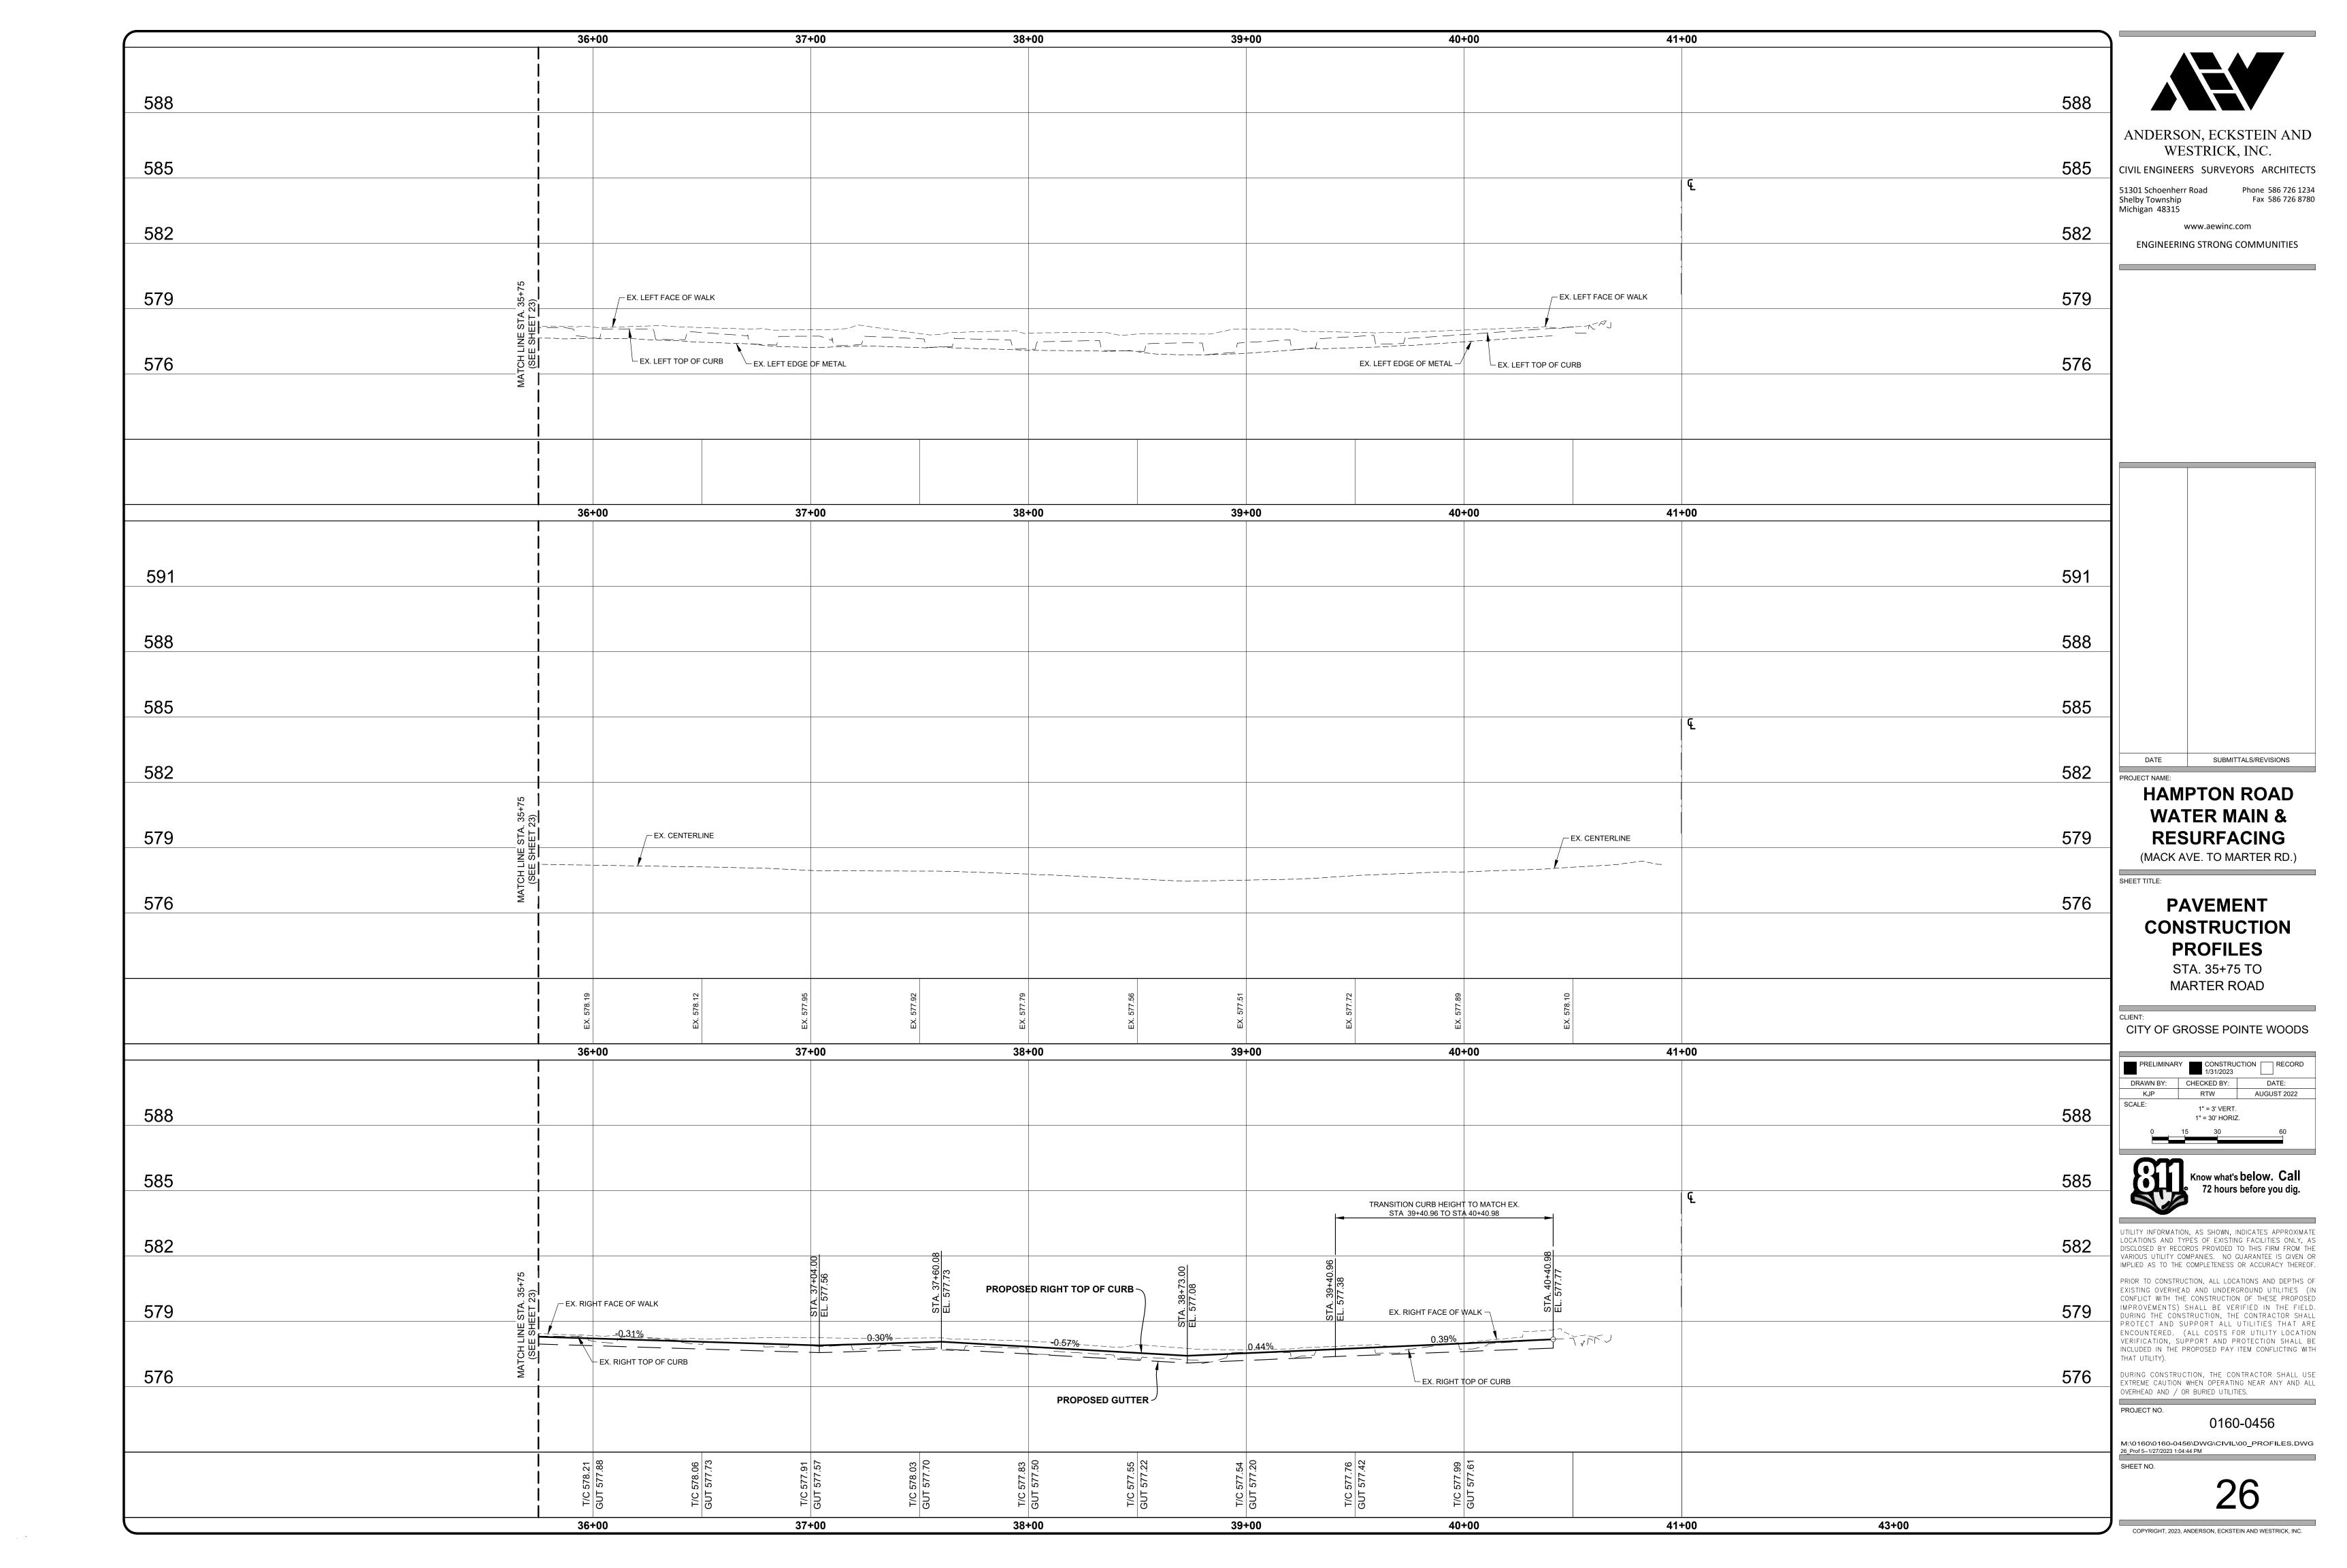
(THIS SHEET)

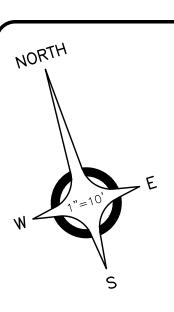
Dr Structure, 24 inch dia WITH 2' SUMP AND Dr Structure Trap, 12 inch AND External Structure Wrap, 18 inch AND Catch Basin Cover, Restricted, GPW STA. 37+04.00, 12.7' RT. RIM 577.56

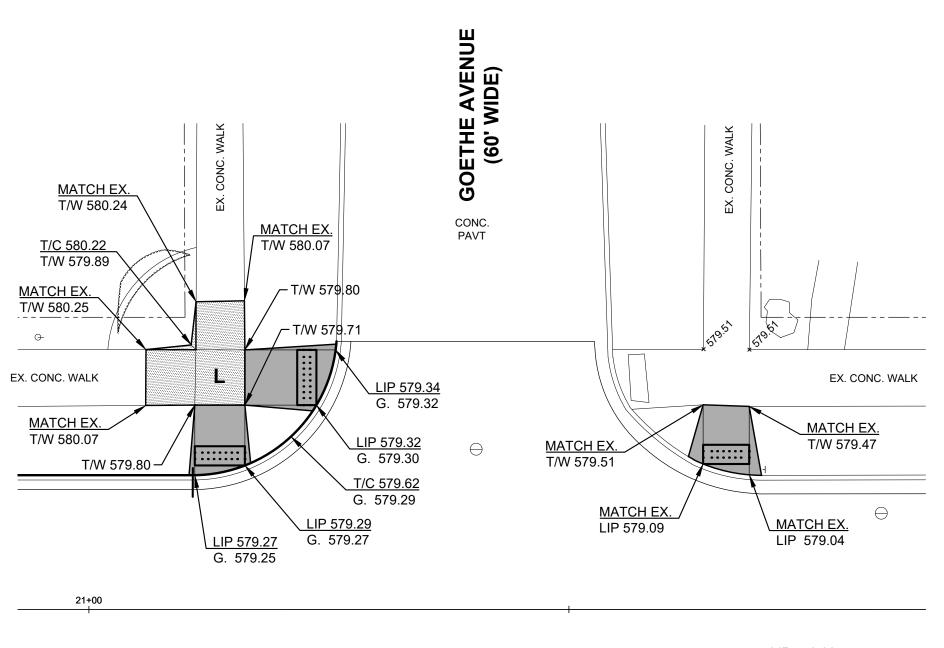
12" IE 574.01 (NE)

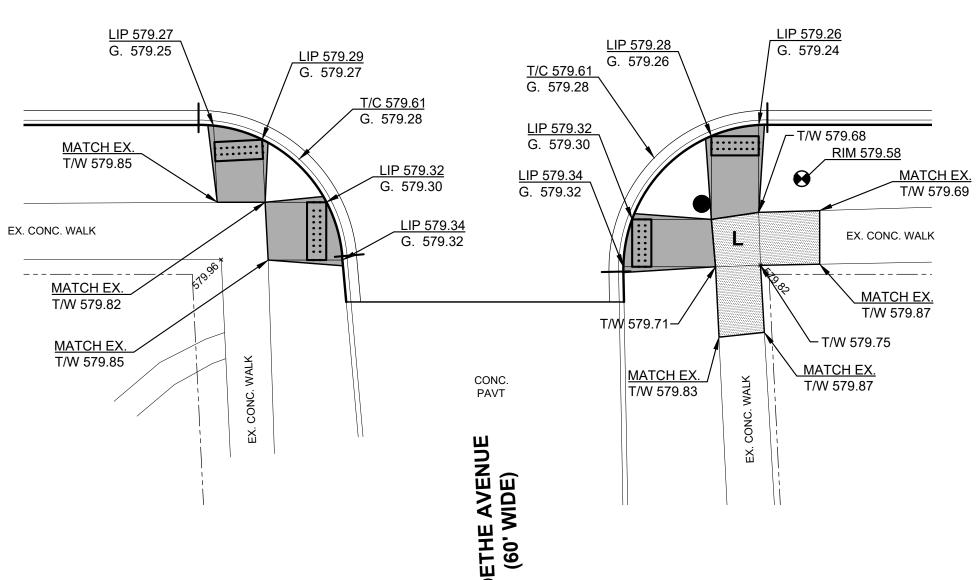
Dr Structure, 24 inch dia WITH 2' SUMP AND Dr Structure Trap, 12 inch AND External Structure Wrap, 18 inch AND Catch Basin Cover, Restricted, GPW STA. 38+73.00, 12.7' RT. RIM 577.08

12" IE 573.51 (NE)

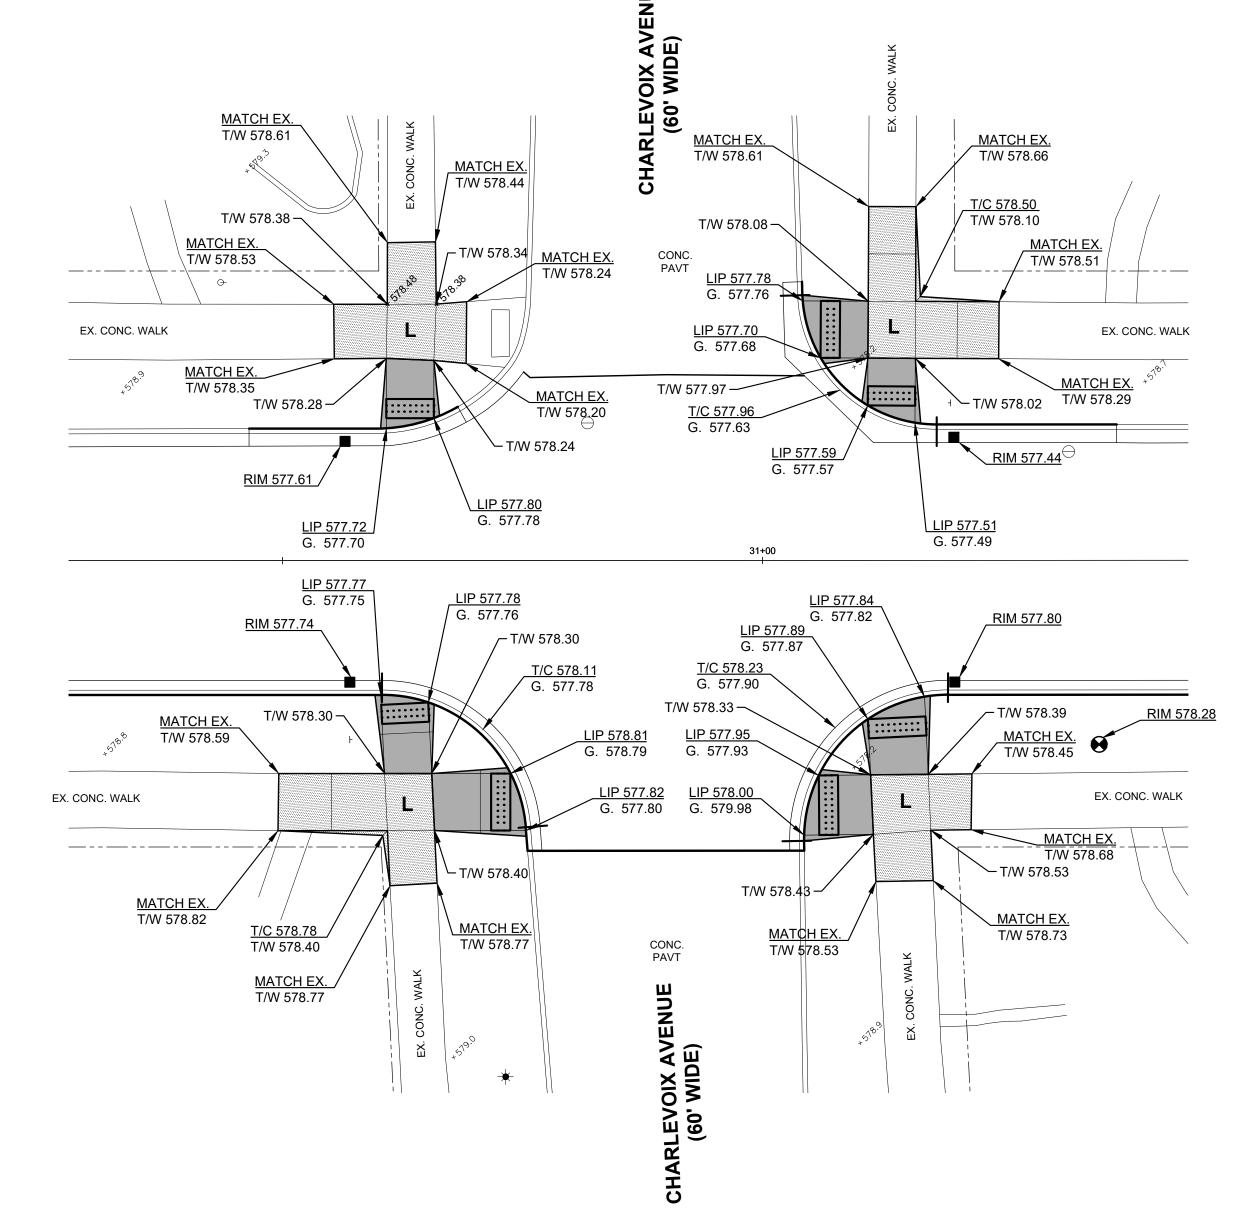












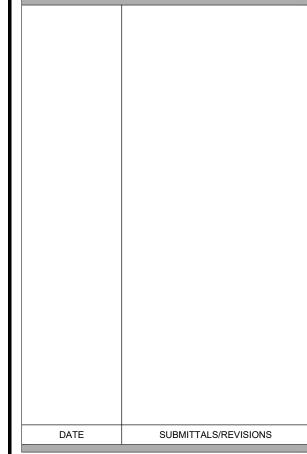


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HAMPTON ROAD
WATER MAIN &

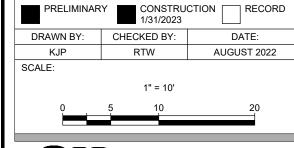
**RESURFACING** 

(MACK AVE. TO MARTER RD.)

SHEET TITLE:

INTERSECTION
GEOMETRICS &
SIDEWALK RAMP
SCHEMATICS

CITY OF GROSSE POINTE WOODS





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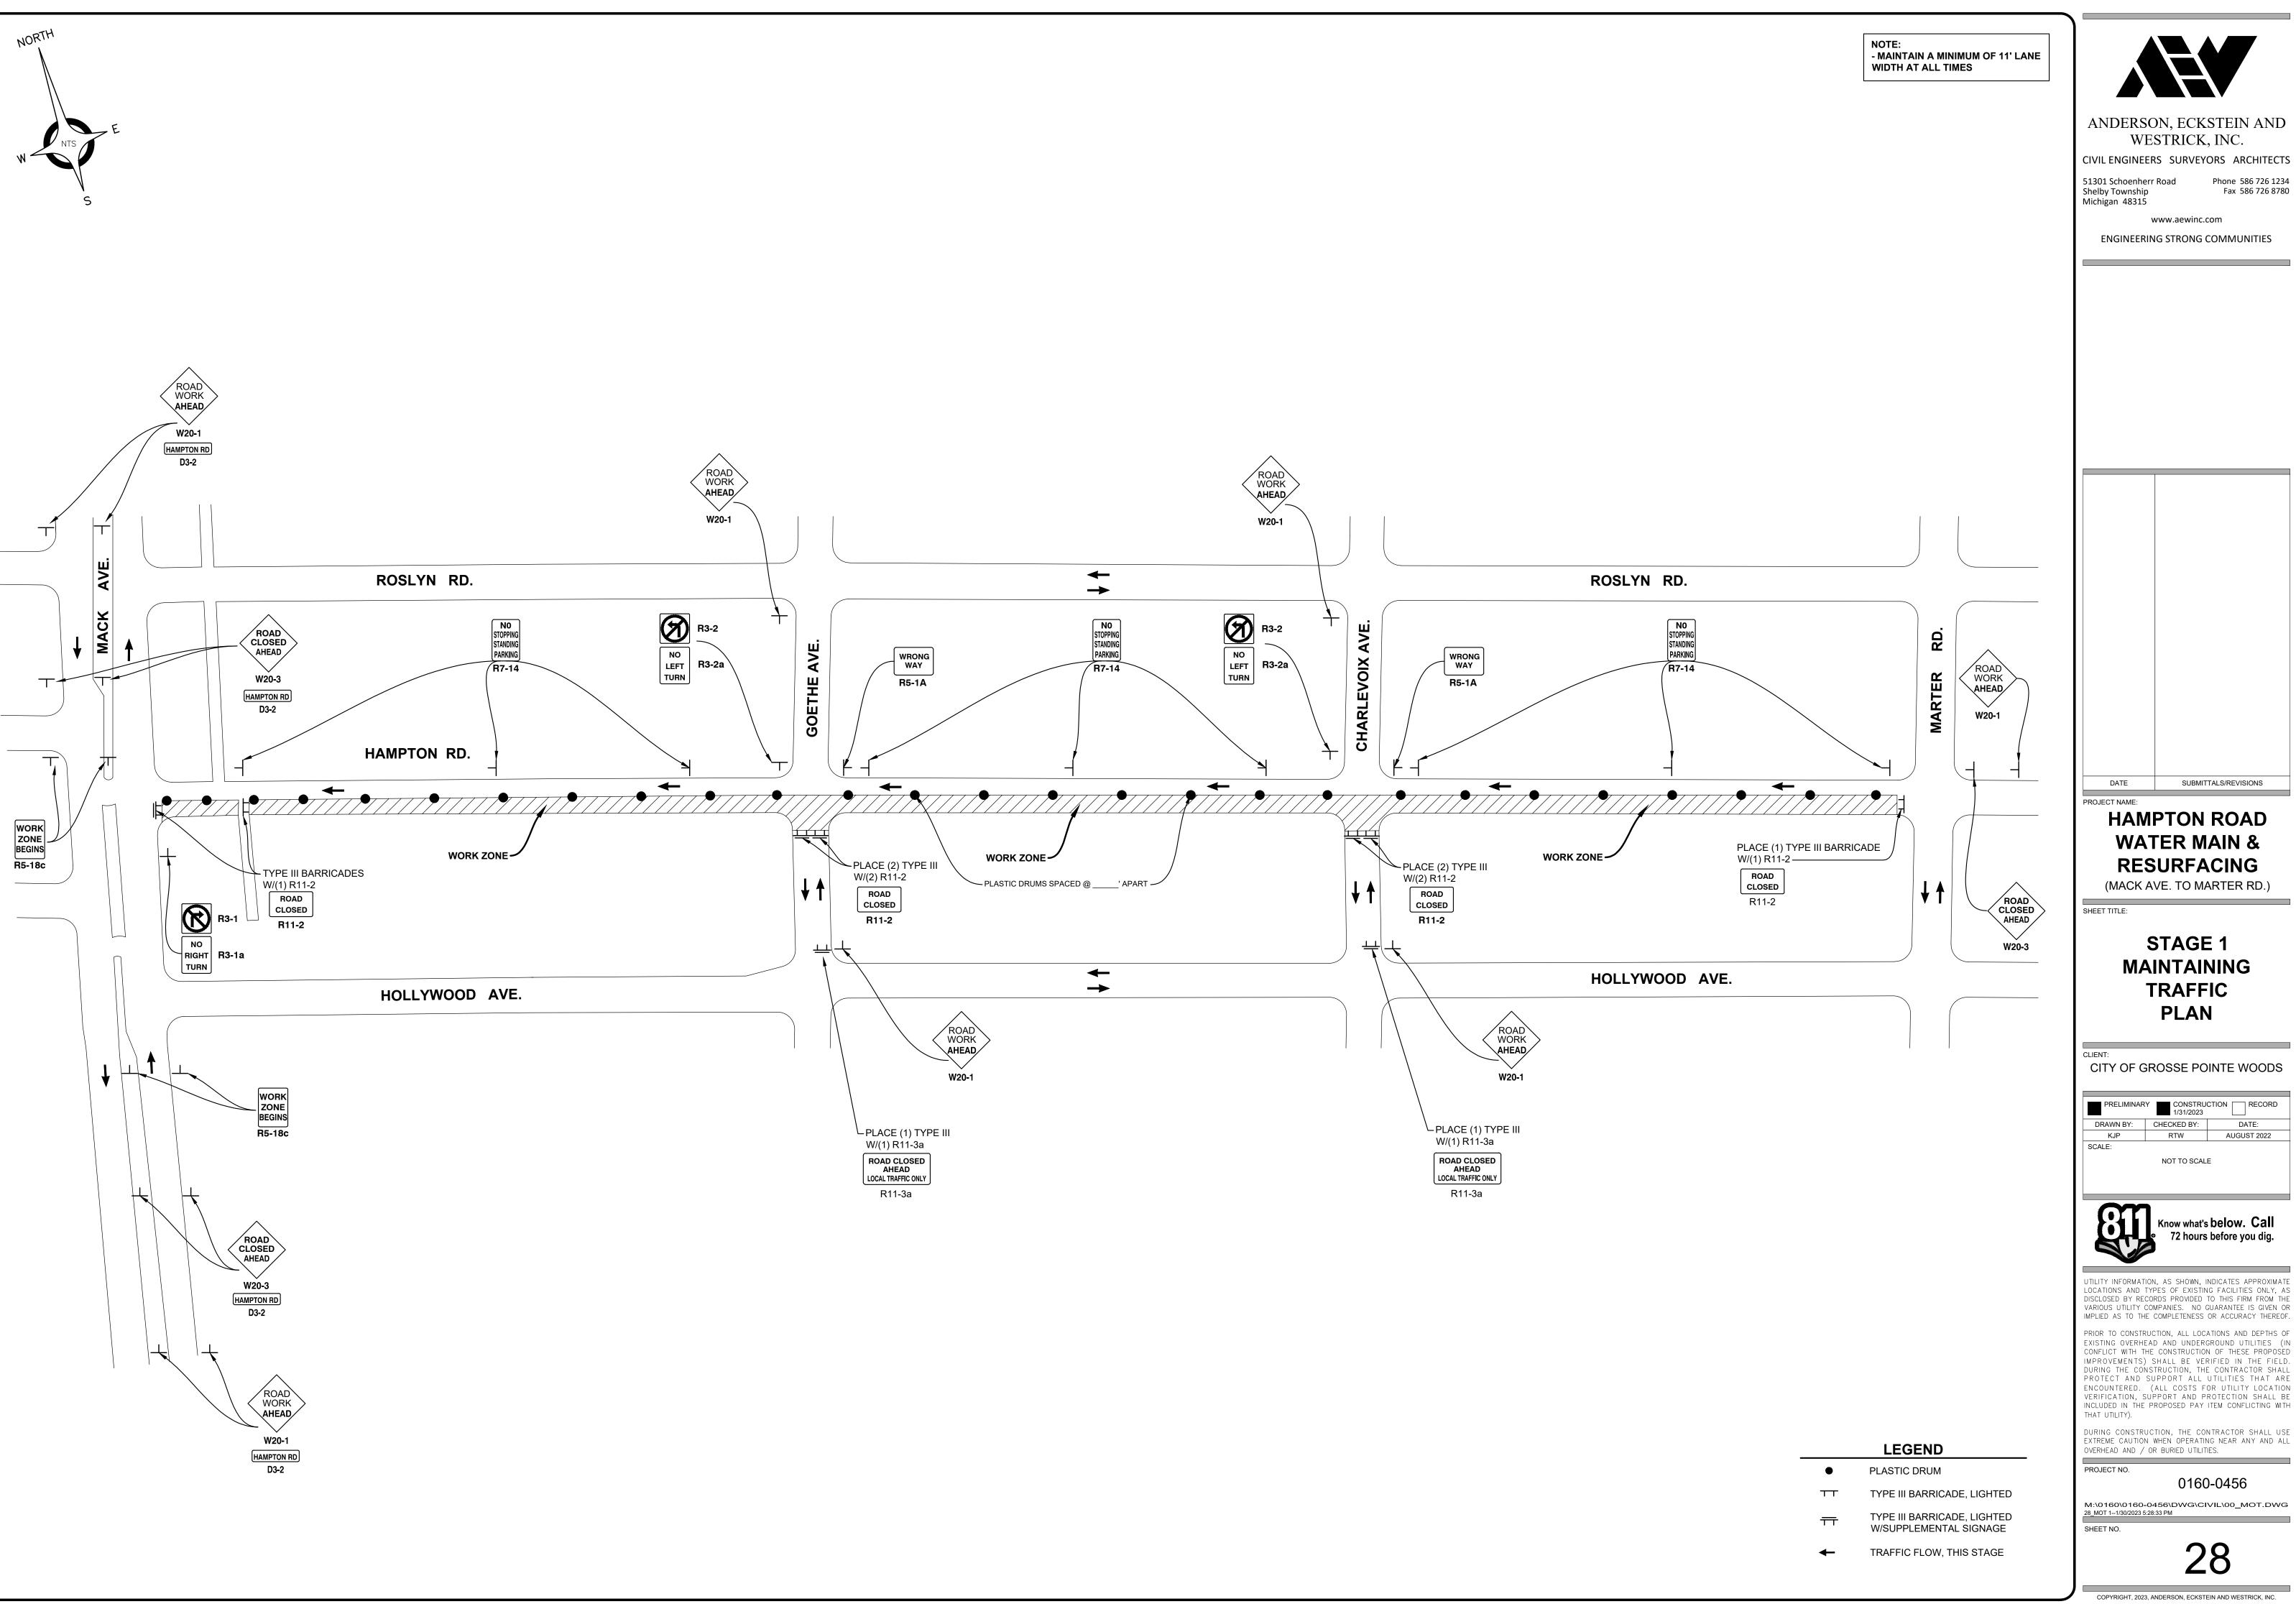
DURING CONSTRUCTION, THE CONTRACTOR SHALL USE EXTREME CAUTION WHEN OPERATING NEAR ANY AND ALL OVERHEAD AND / OR BURIED UTILITIES.

PROJECT NO. 0160-0456

THAT UTILITY).

M:\0160\0160-0456\DWG\CIVIL\00\_DETL GRADES.DWG 27\_Detl Grades 2--1/27/2023 12:55:49 PM SHEET NO.

27





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SUBMITTALS/REVISIONS

**HAMPTON ROAD** WATER MAIN & **RESURFACING** 

STAGE 1 **MAINTAINING TRAFFIC PLAN** 

CITY OF GROSSE POINTE WOODS

PRELIMINAR	1/31/2023	CTION RECORL
DRAWN BY:	CHECKED BY:	DATE:
KJP	RTW	AUGUST 2022
SCALE:		
	NOT TO SCAL	E



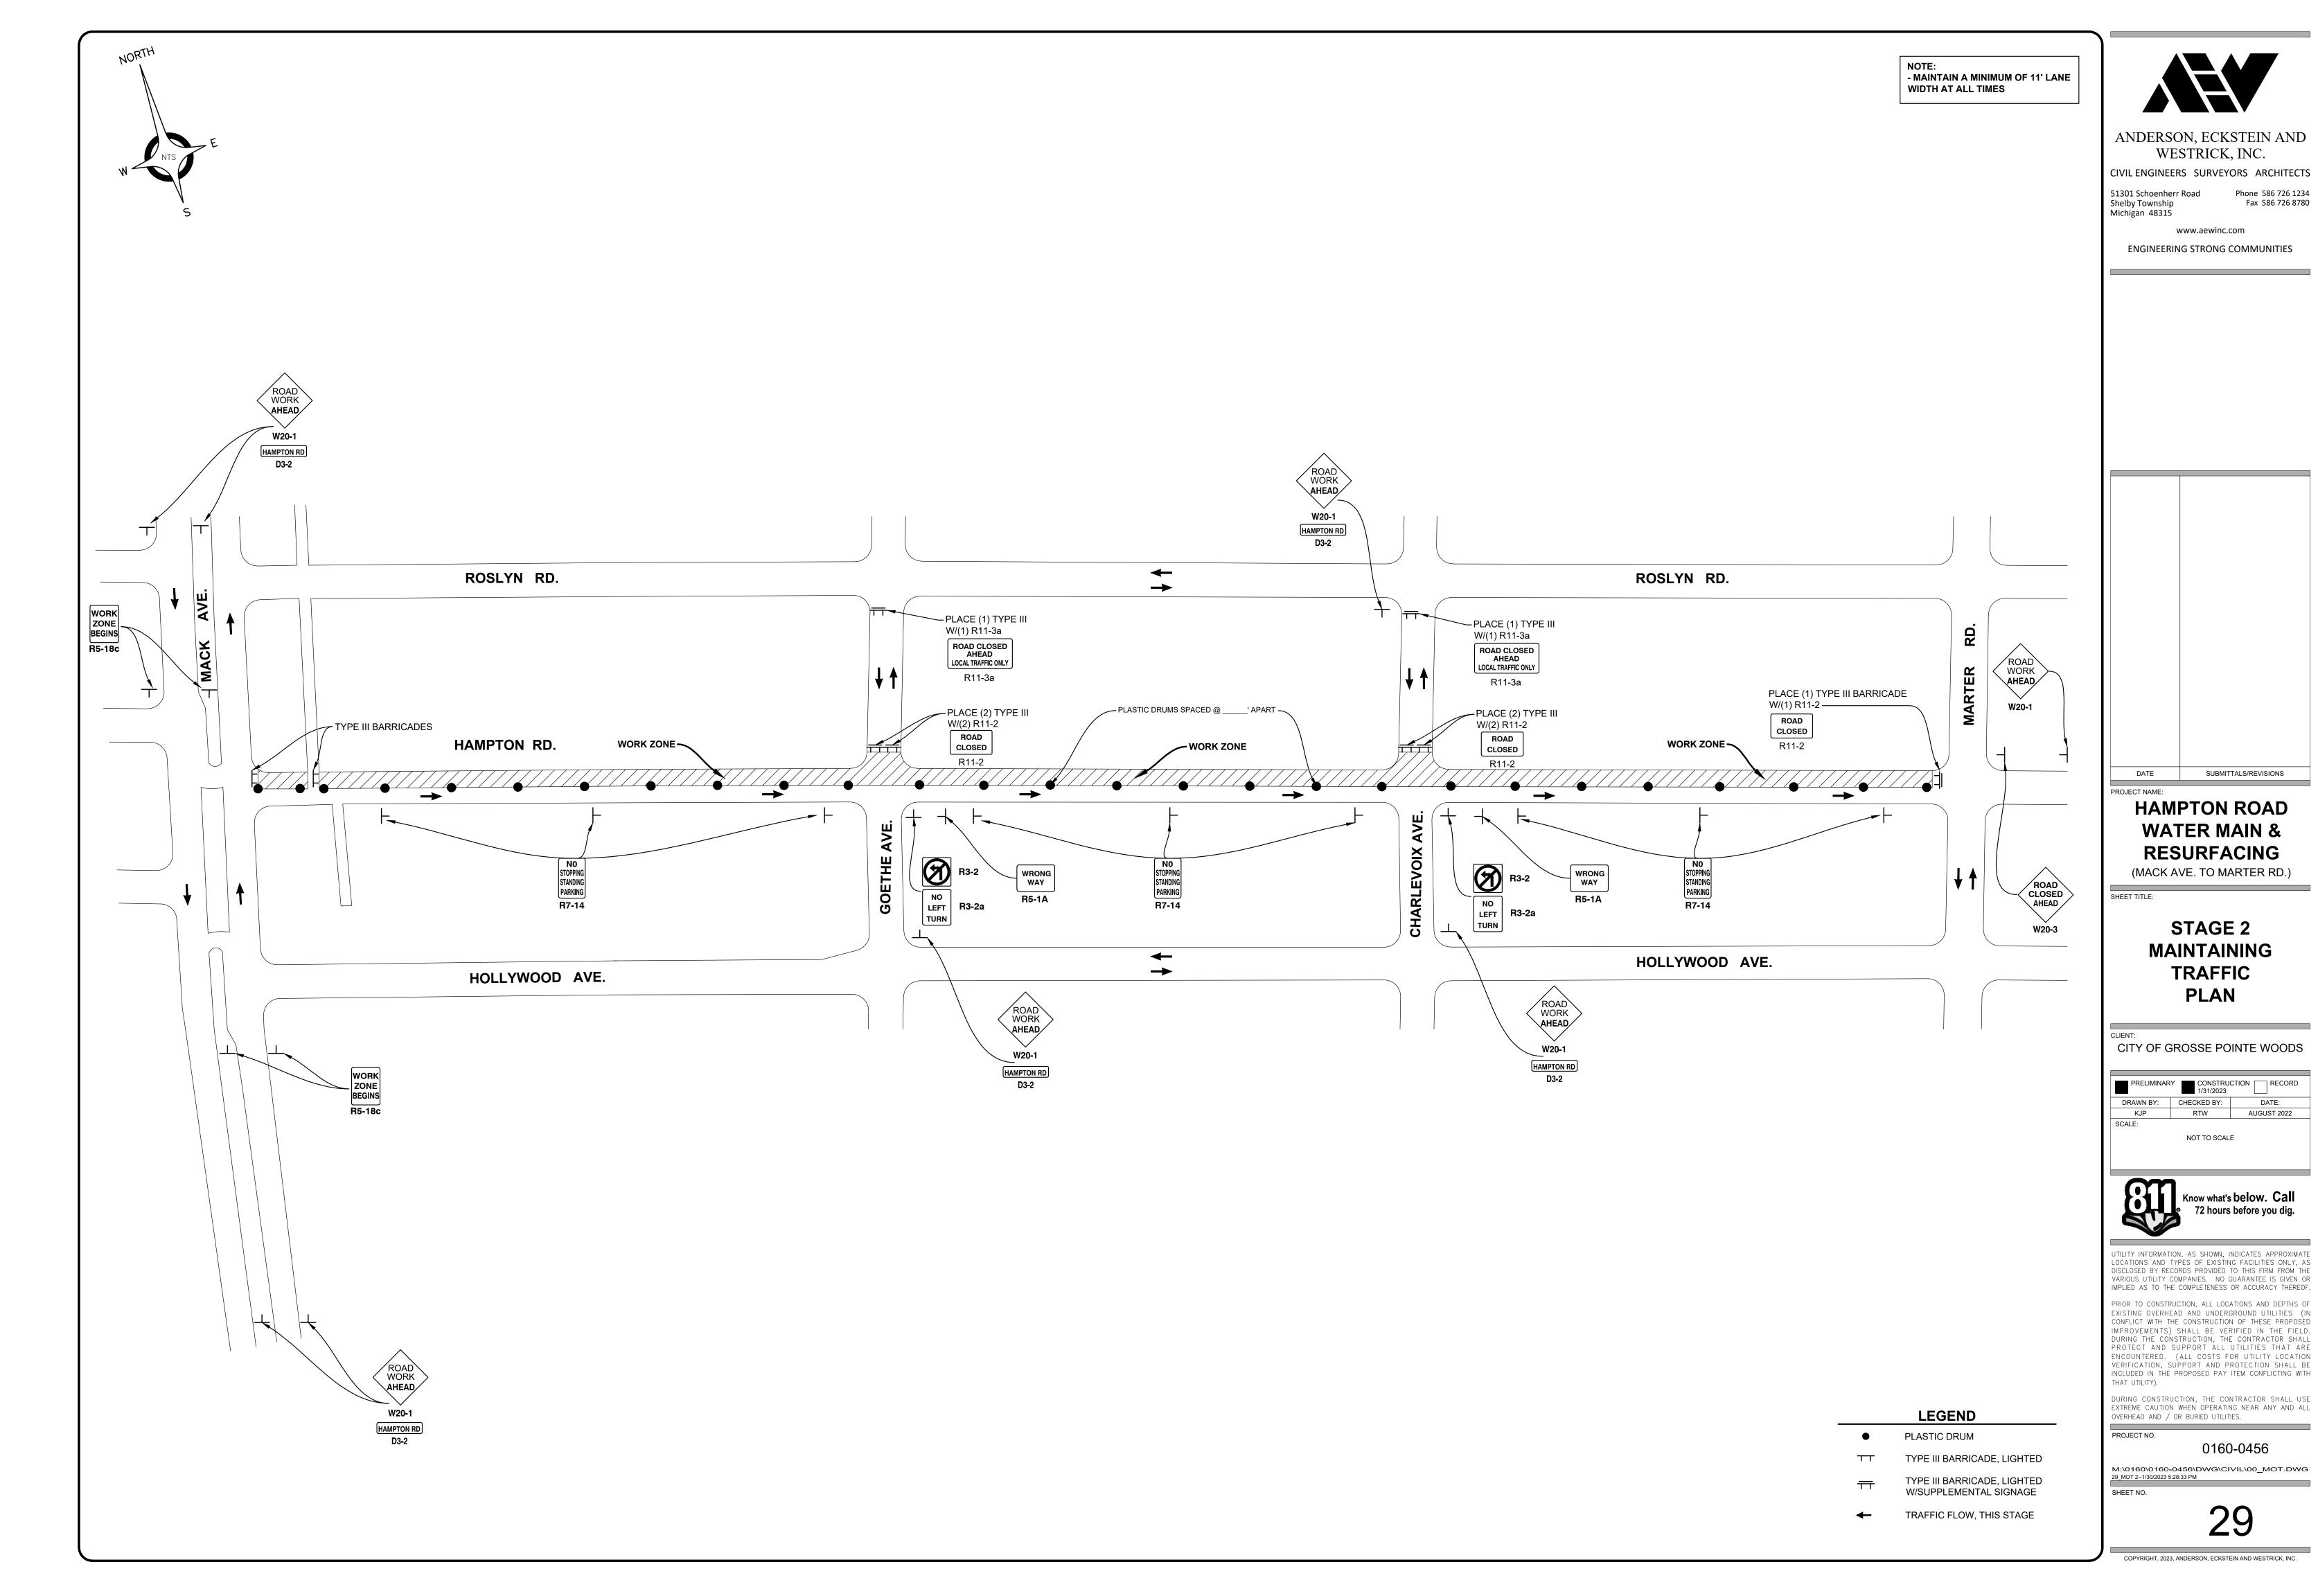
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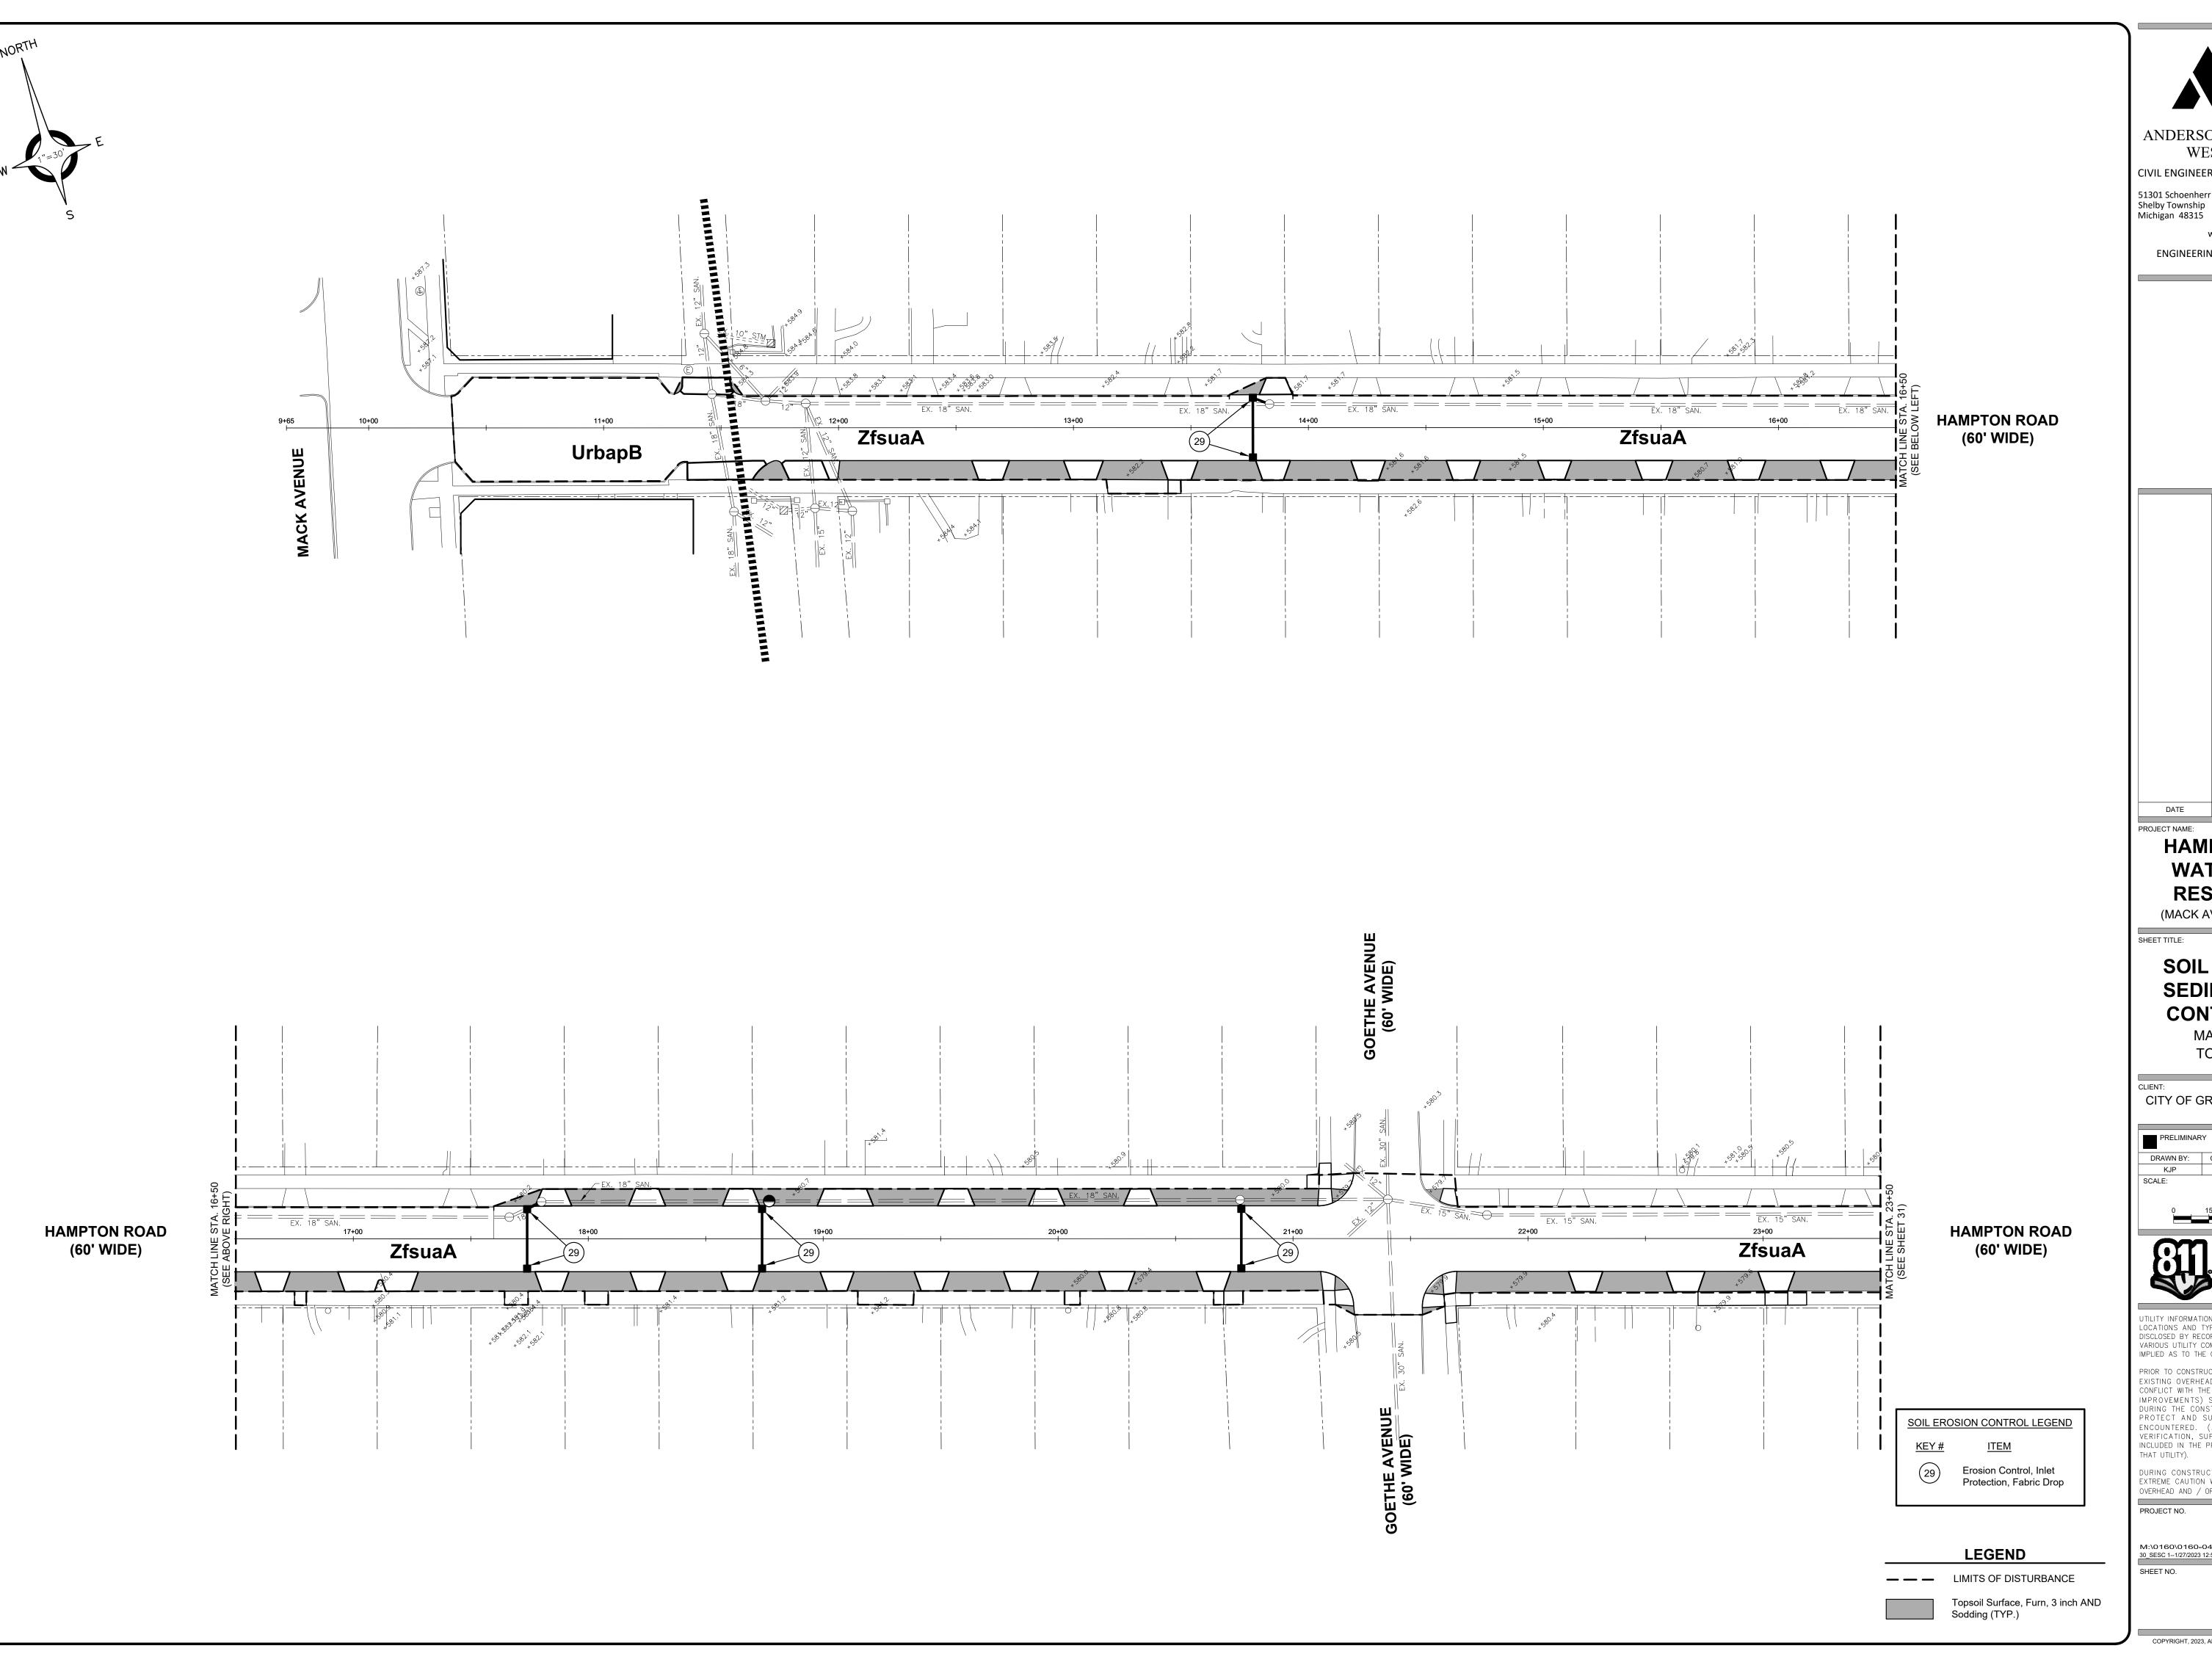
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0160-0456

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SUBMITTALS/REVISIONS

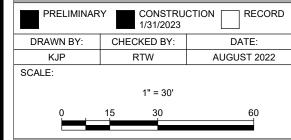
#### **HAMPTON ROAD WATER MAIN & RESURFACING**

(MACK AVE. TO MARTER RD.)

# **SOIL EROSION & SEDIMENTATION**

**CONTROL PLAN** MACK AVENUE TO STA. 23+50

CITY OF GROSSE POINTE WOODS





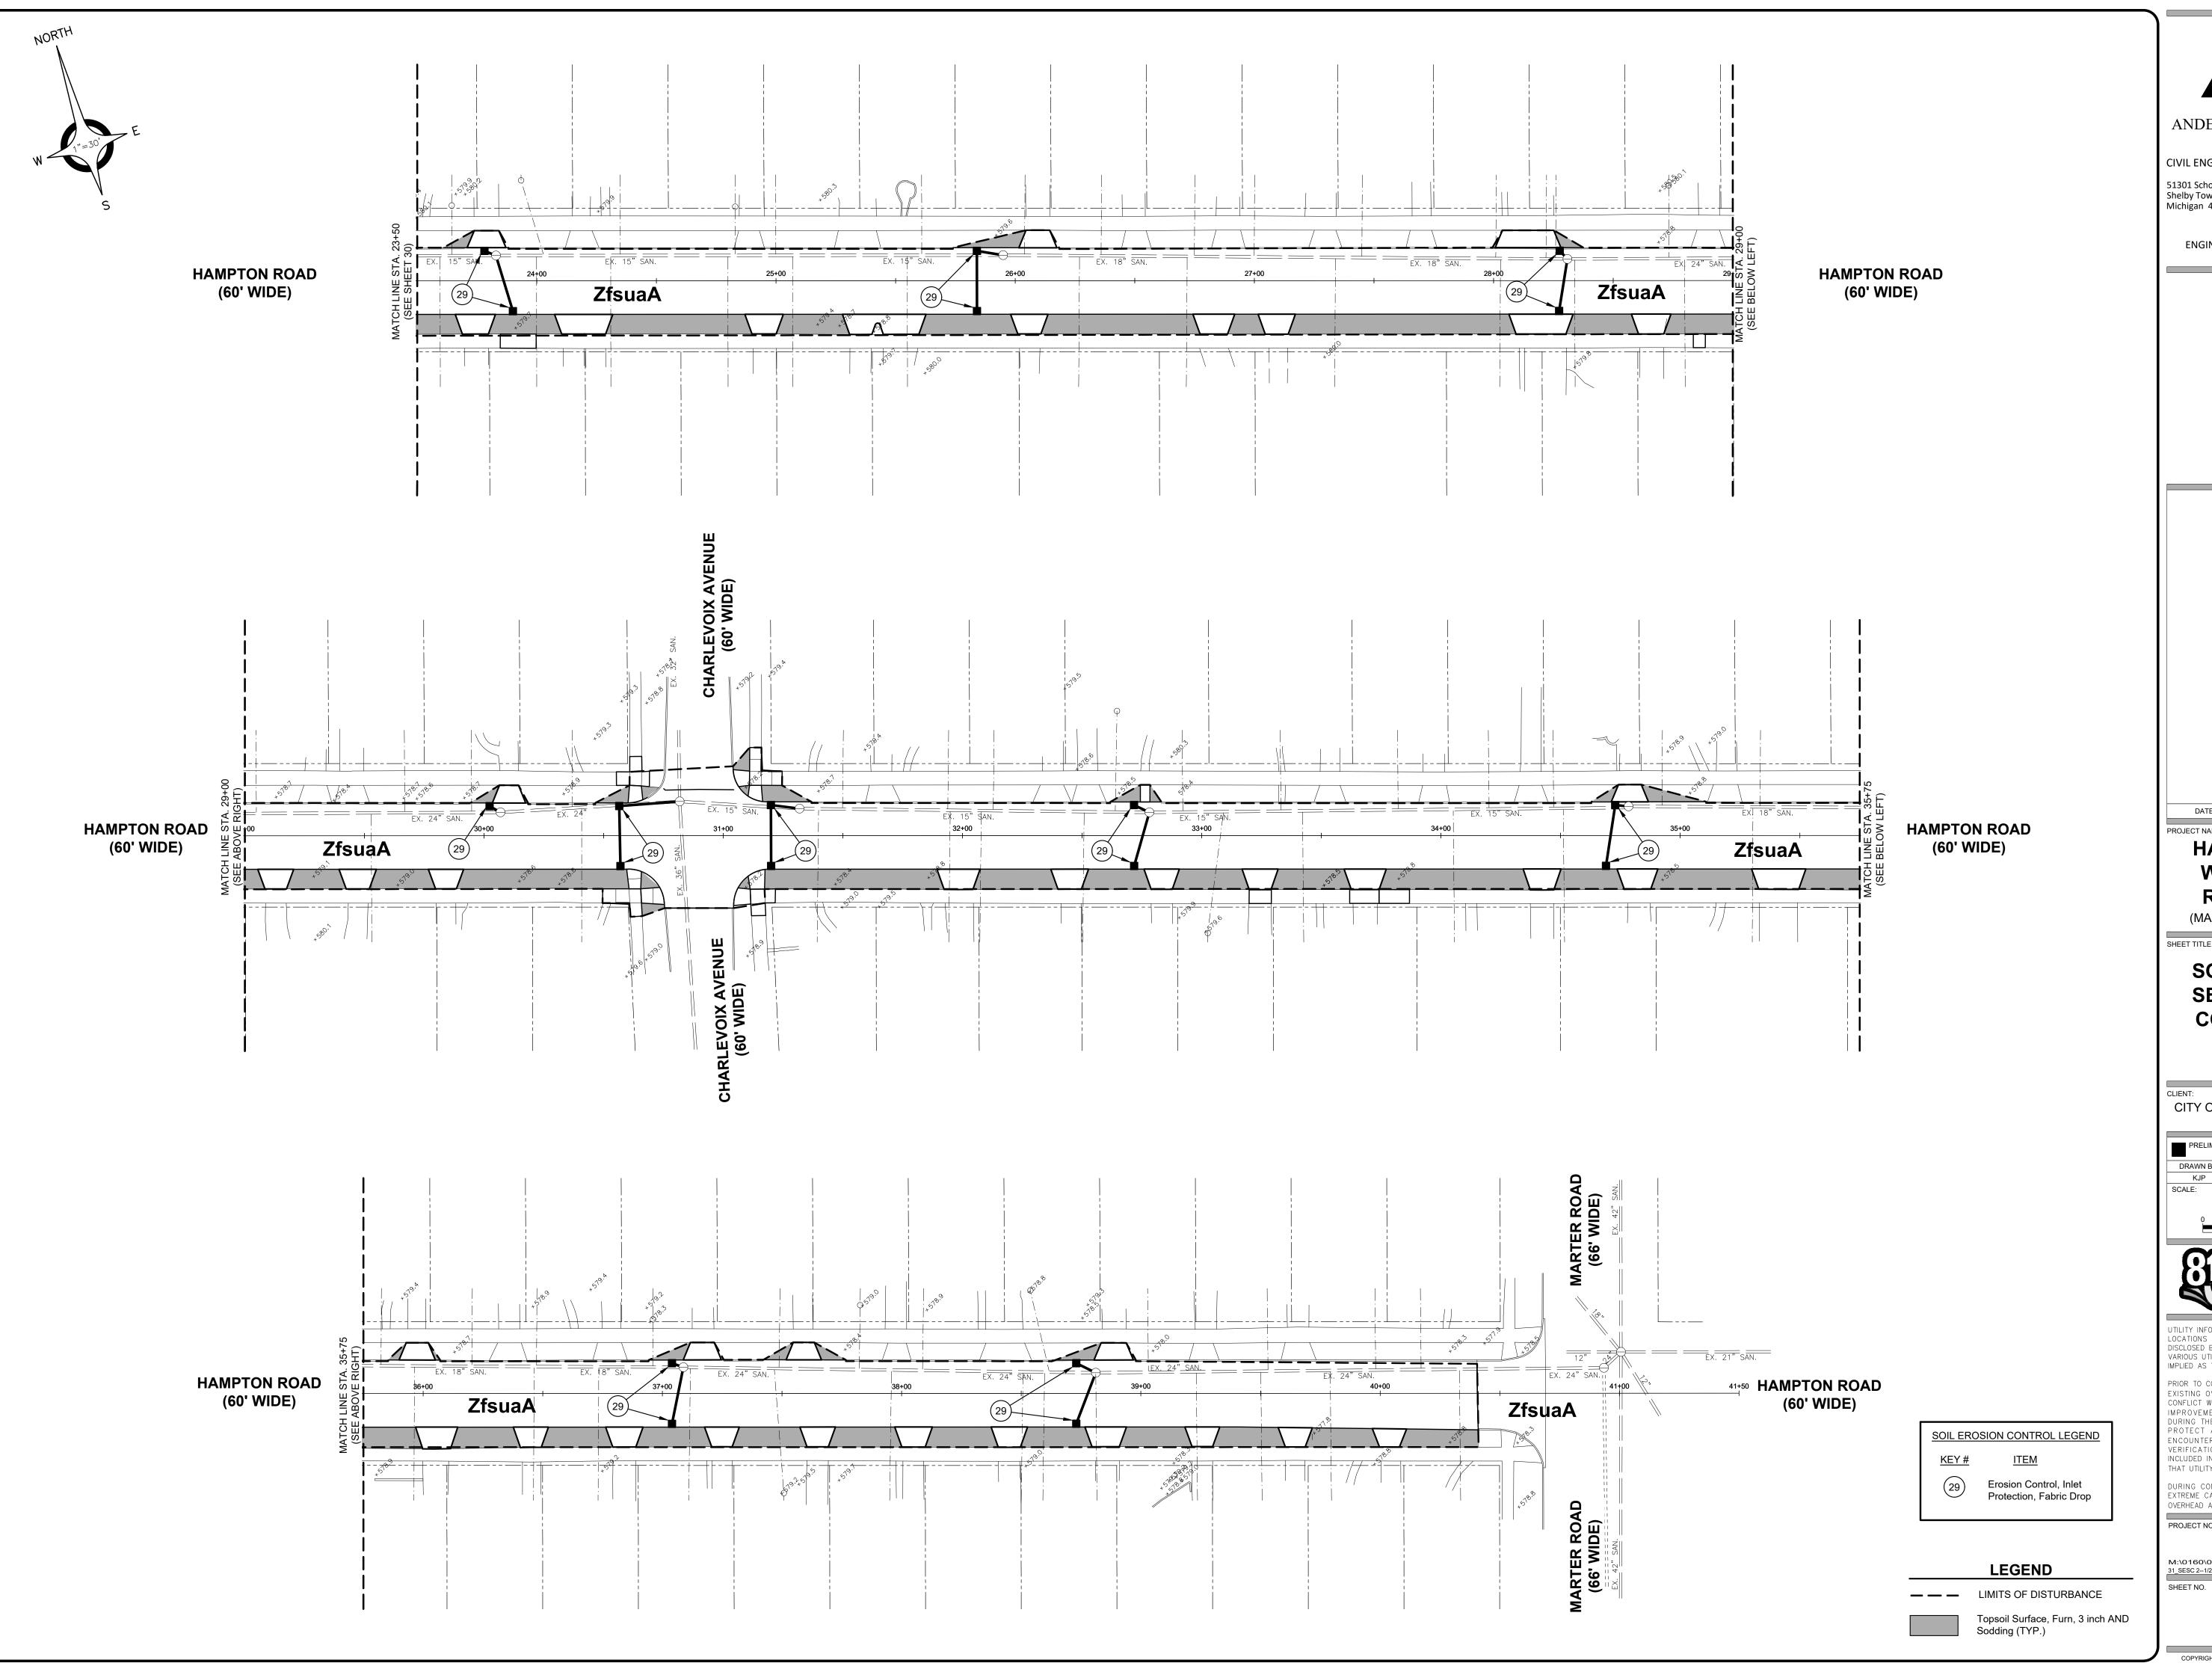
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PROJECT NO.

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CIVIL ENGINEERS SURVEYORS ARCHITECTS

Shelby Township Michigan 48315 Fax 586 726 8780

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ENGINEERING STRONG COMMUNITIES

SUBMITTALS/REVISIONS

**HAMPTON ROAD** WATER MAIN & **RESURFACING** 

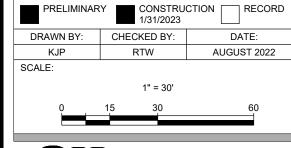
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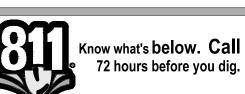
SHEET TITLE:

**SOIL EROSION & SEDIMENTATION CONTROL PLAN** 

STA. 23+50 TO MARTER ROAD

CITY OF GROSSE POINTE WOODS





UTILITY INFORMATION, AS SHOWN, INDICATES APPROXIMATE

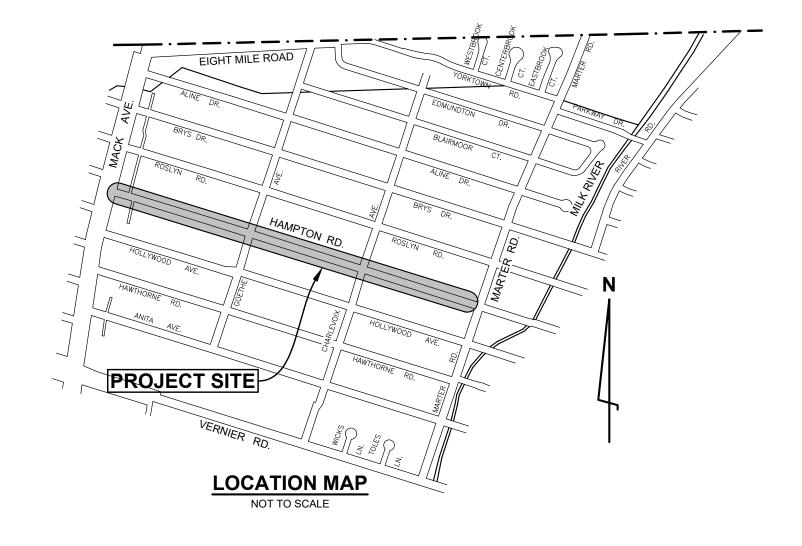
LOCATIONS AND TYPES OF EXISTING FACILITIES ONLY, AS DISCLOSED BY RECORDS PROVIDED TO THIS FIRM FROM THE VARIOUS UTILITY COMPANIES. NO GUARANTEE IS GIVEN OR IMPLIED AS TO THE COMPLETENESS OR ACCURACY THEREOF. PRIOR TO CONSTRUCTION, ALL LOCATIONS AND DEPTHS OF EXISTING OVERHEAD AND UNDERGROUND UTILITIES (IN

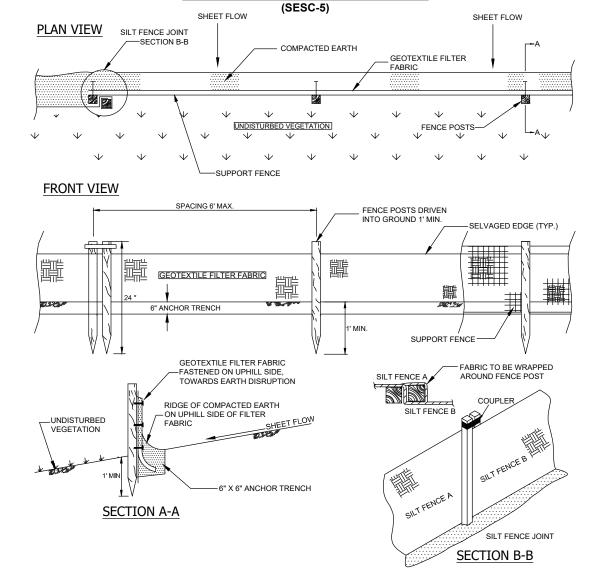
CONFLICT WITH THE CONSTRUCTION OF THESE PROPOSED IMPROVEMENTS) SHALL BE VERIFIED IN THE FIELD. DURING THE CONSTRUCTION, THE CONTRACTOR SHALL PROTECT AND SUPPORT ALL UTILITIES THAT ARE ENCOUNTERED. (ALL COSTS FOR UTILITY LOCATION VERIFICATION, SUPPORT AND PROTECTION SHALL BE INCLUDED IN THE PROPOSED PAY ITEM CONFLICTING WITH

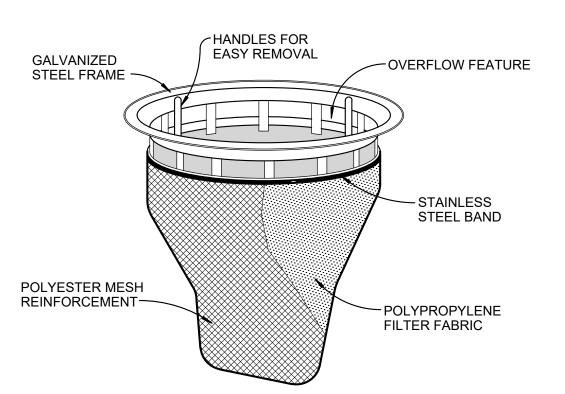
THAT UTILITY). DURING CONSTRUCTION, THE CONTRACTOR SHALL USE EXTREME CAUTION WHEN OPERATING NEAR ANY AND ALL OVERHEAD AND / OR BURIED UTILITIES.

PROJECT NO. 0160-0456

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**INLET PROTECTION, FABRIC DROP** 

#### **SEQUENCE OF CONSTRUCTION**

- 1. REMOVE PAVEMENT DROP-IN INLET FILTERS
- 2. ROAD PAVING DROP-IN INLET FILTERS
- 3. FINAL CLEANUP AND REMOVE DROP-IN INLET FILTERS

#### MAINTENANCE REQUIREMENTS:

- STREET SCRAPING DAILY
- STREET SWEEPING WEEKLY MINIMUM
- STRUCTURAL SEDIMENT CONTROLS INSPECT AND MAINTAIN ON A WEEKLY BASIS

#### **SOILS INFORMATION**

AREA OF CONSTRUCTION: UrbapB = Urban land-Fortress family complex, dense substratum ZfsuaA = Ziegenfuss-Urban land complex

#### **ESTIMATED QUANTITIES** (ENTIRE PROJECT)

1. Erosion Control, Inlet Protection, Fabric Drop 28 Ea 2. Topsoil Surface, Furn, 3 inch 2,177 Syd 3. Sodding 2,177 Syd

- THIS PROJECT SHALL BE CONSTRUCTED IN COMPLIANCE WITH PART 91 OF ACT 451 OF 1994, AS AMENDED. "THE SOIL EROSION AND SEDIMENT CONTROL ACT"
- GROSS ACREAGE DISTURBED IS 2.68 ACRES.
- NO WETLANDS WITHIN CONSTRUCTION
- PHYSICAL LIMITS OF EARTH DISTURBANCE SHALL REMAIN WITH THE ROAD RIGHT OF WAYS.
- IF NECESSARY, SILT FENCE SHALL BE USED AND INSTALLED AS SHOWN IN THE DETAIL ON THIS SHEET.



ANDERSON, ECKSTEIN AND WESTRICK, INC.

CIVIL ENGINEERS SURVEYORS ARCHITECTS

51301 Schoenherr Road Phone 586 726 1234 Fax 586 726 8780 Shelby Township Michigan 48315

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SUBMITTALS/REVISIONS

**HAMPTON ROAD** WATER MAIN & **RESURFACING** 

(MACK AVE. TO MARTER RD.)

SHEET TITLE:

# **SOIL EROSION & SEDIMENTATION CONTROL PLAN**

NOTES AND DETAILS

CITY OF GROSSE POINTE WOODS

PRELIMINARY CONSTRUCTION RECORD 1/31/2023 DRAWN BY: CHECKED BY:

KJP RTW AUGUST 2022 AS NOTED



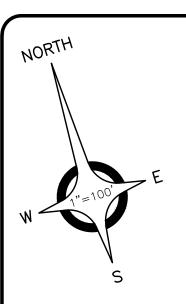
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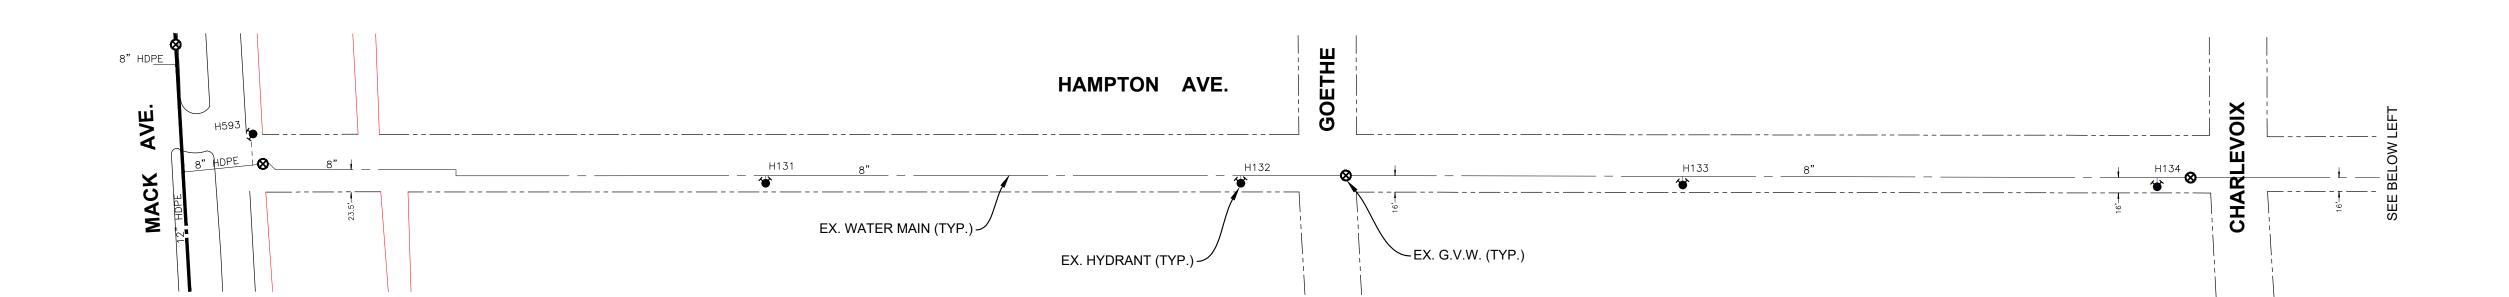
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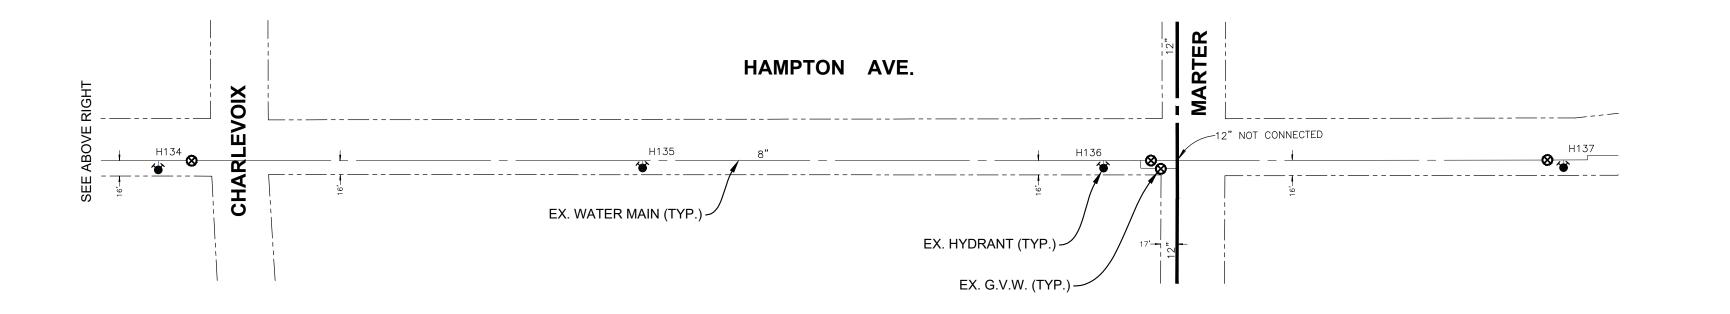
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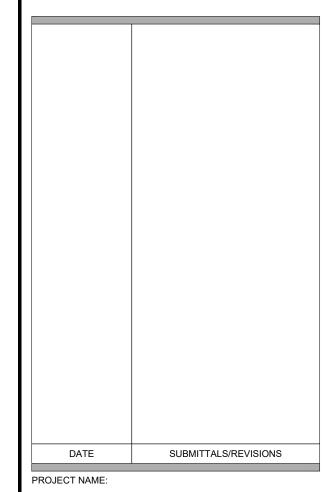


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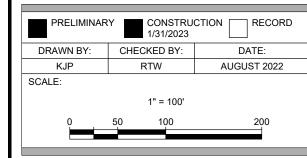
HAMPTON ROAD WATER MAIN & RESURFACING

(MACK AVE. TO MARTER RD.)

SHEET TITLE:

#### **EXISTING VALVE MAP**

CLIENT:
CITY OF GROSSE POINTE WOODS





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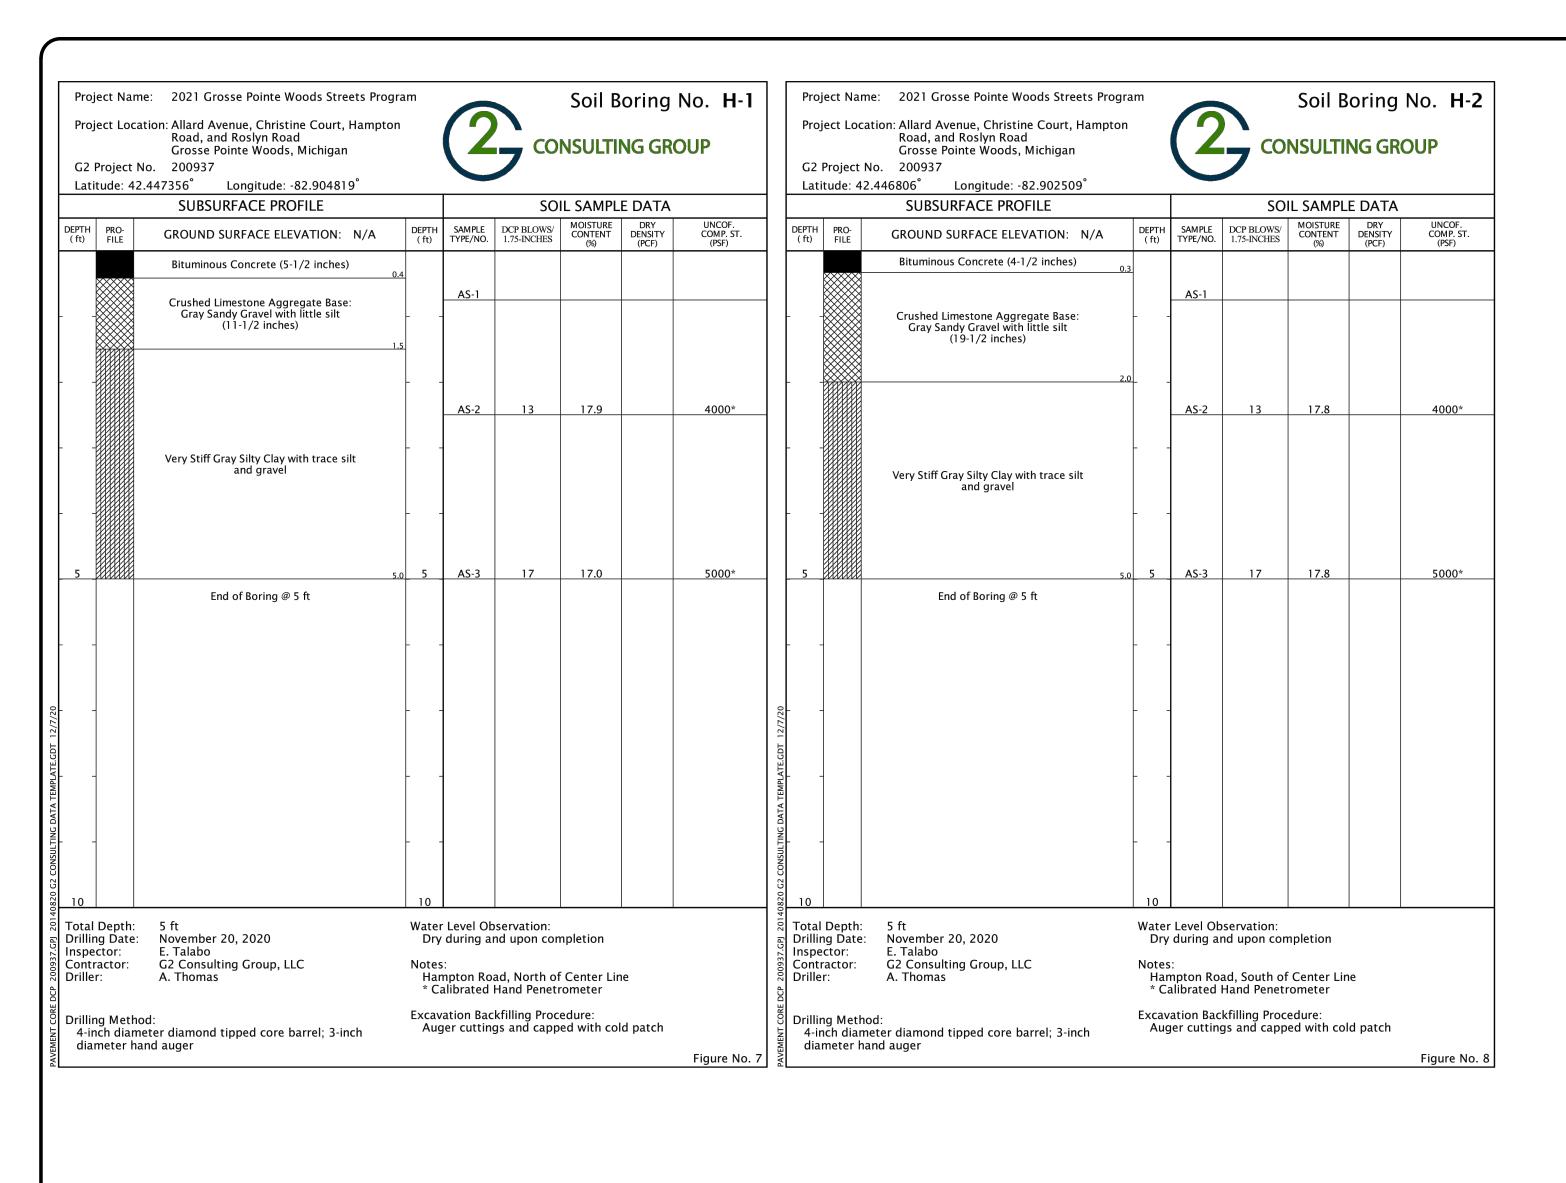
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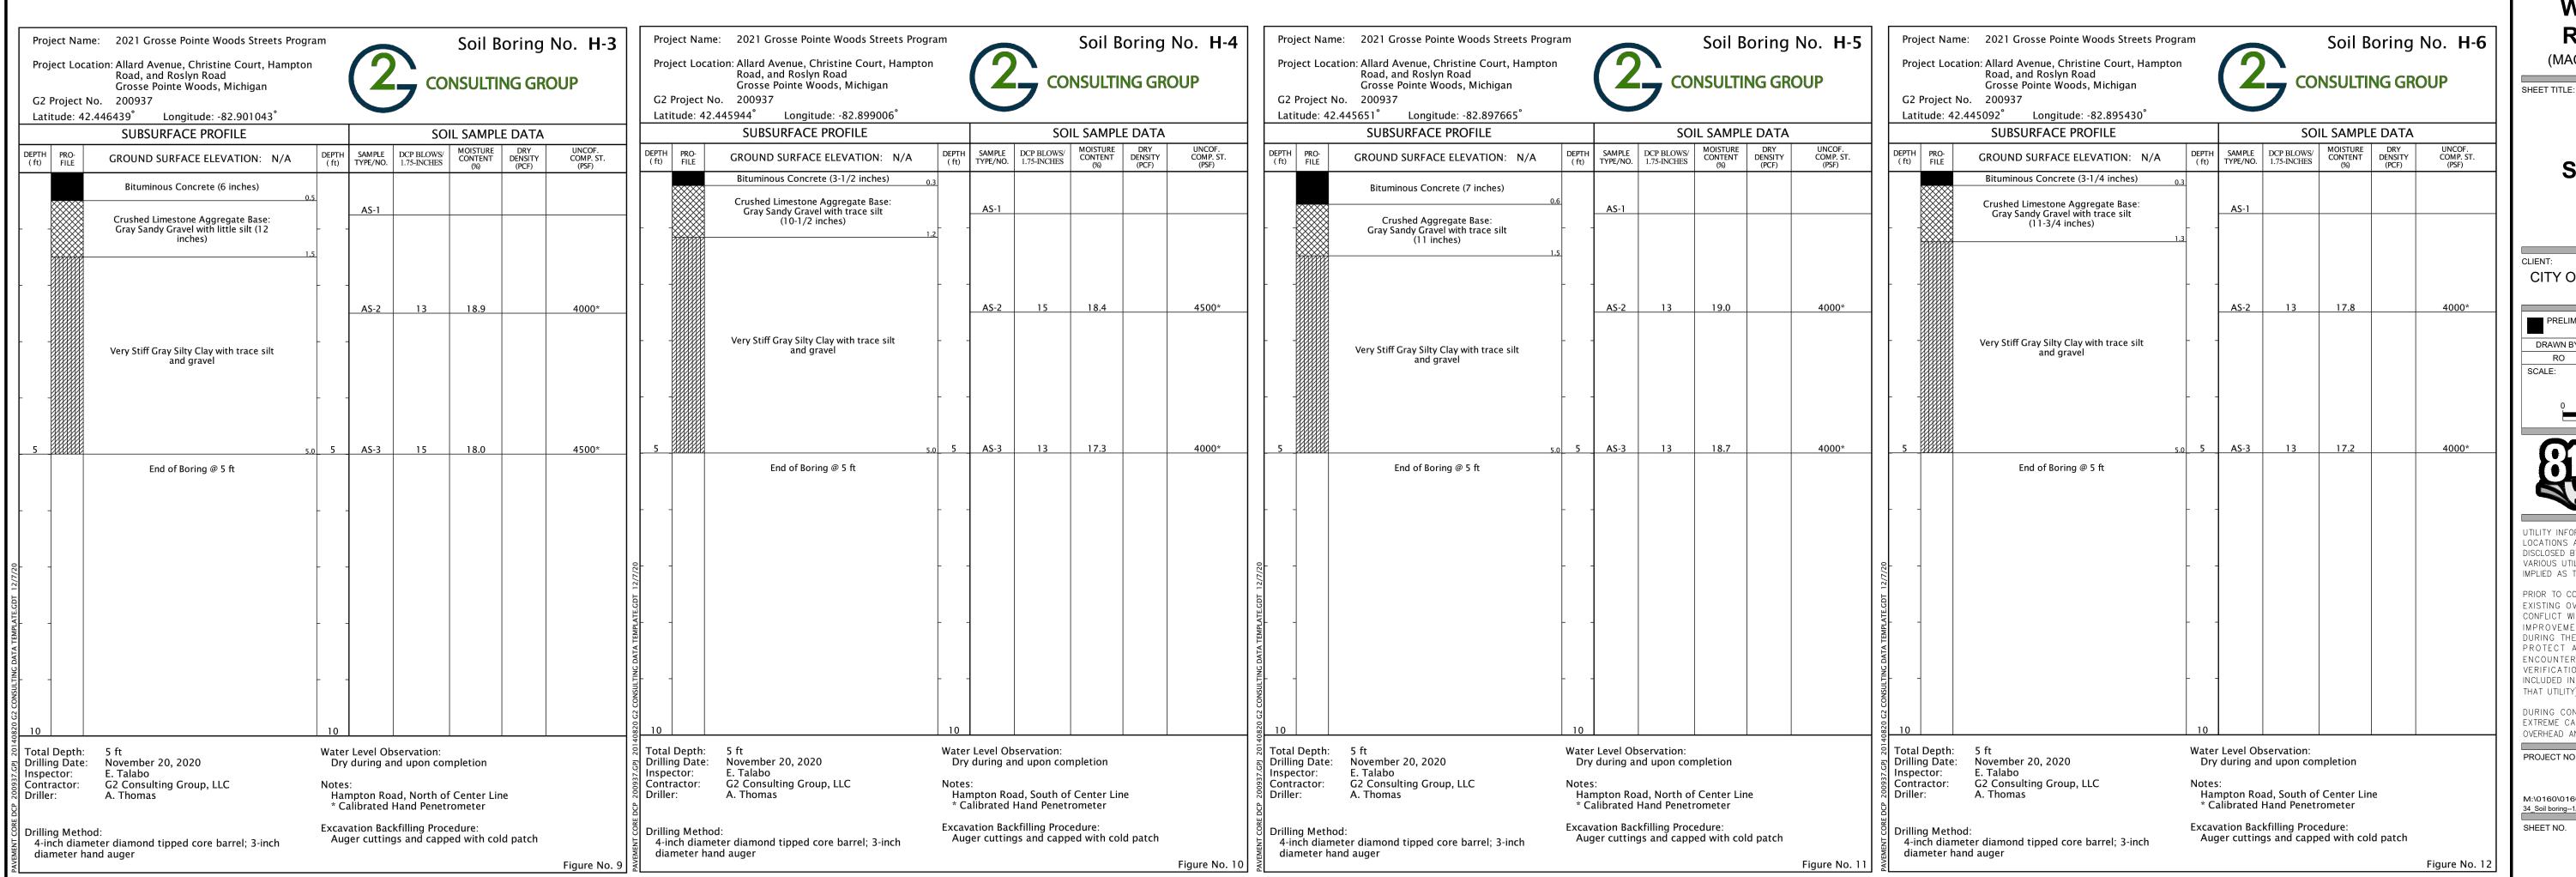
THAT UTILITY).

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DATE SUBMITTALS/REVISIONS
PROJECT NAME:

HAMPTON ROAD WATER MAIN & RESURFACING

(MACK AVE. TO MARTER RD.)

**SOIL BORINGS** 

IENT:

CITY OF GROSSE POINTE WOODS

PRELIMINARY CONSTRUCTION RECORD
DRAWN BY: CHECKED BY: DATE:
RO RW AUGUST 2022
SCALE:



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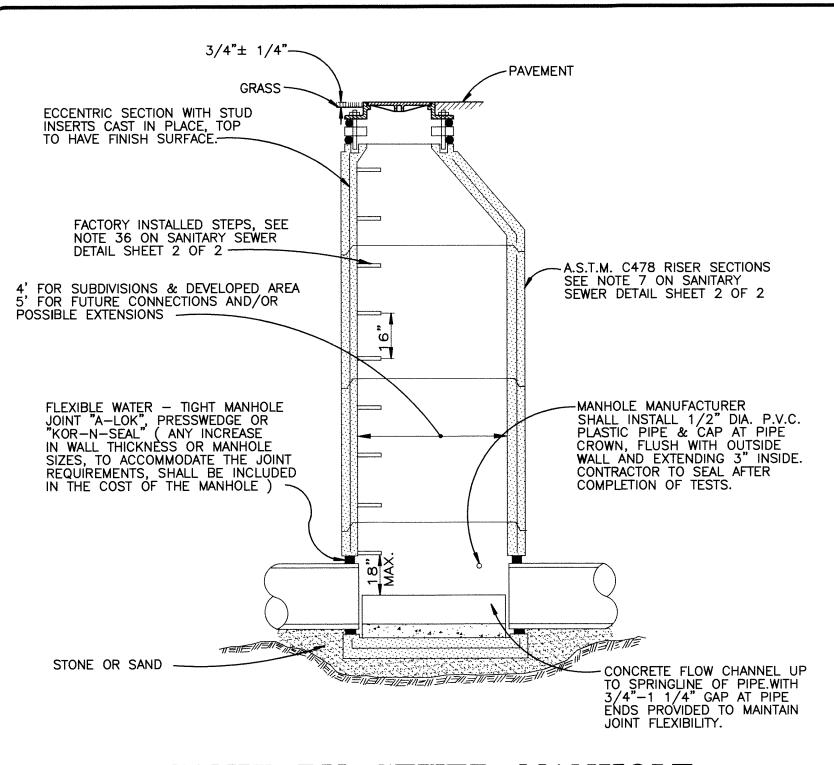
PROTECT AND SUPPORT ALL UTILITIES THAT ARE ENCOUNTERED. (ALL COSTS FOR UTILITY LOCATION VERIFICATION, SUPPORT AND PROTECTION SHALL BE INCLUDED IN THE PROPOSED PAY ITEM CONFLICTING WITH THAT UTILITY).

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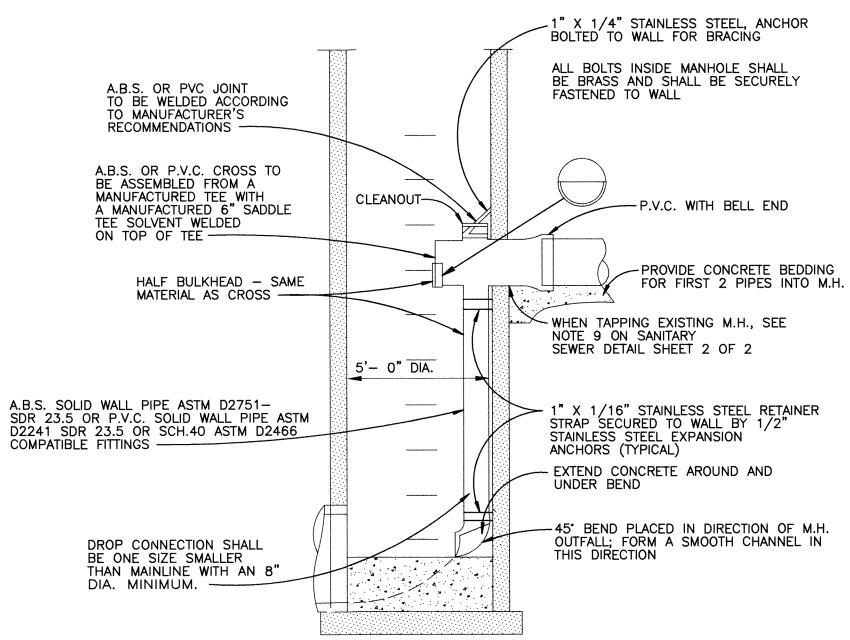
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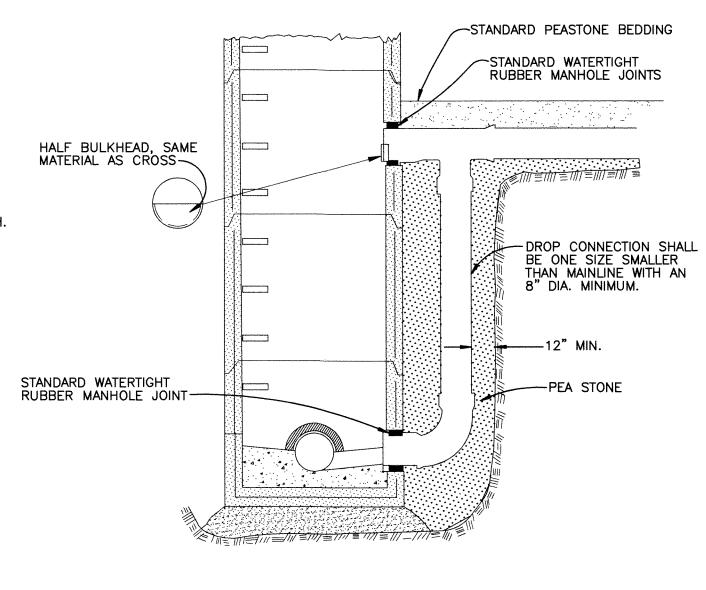
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#### SEE MINIMUM MANHOLE REQUIREMENTS FOR 8"-15" DIAMETER SEWERS PAVEMENT-FACTORY INSTALLED STEPS, SEE NOTE 36 ON SANITARY ECCENTRIC SECTION WITH STUD SEWER DETAIL SHEET 2 OF 2 INSERTS CAST IN PLACE, TOP TO HAVE FINISH SURFACE.-- A.S.T.M. C 478 RISER SECTIONS SEE NOTE 7 ON SANITARY SEWER DETAIL SHEET 2 OF 2 MANHOLE MANUFACTURER SHALL INSTALL 1/2" DIA. P.V.C. PLASTIC PIPE & CAP AT PIPE CROWN, FLUSH WITH OUTSIDE 5'- 0" DIA. WALL AND EXTENDING 3" INSIDE. CONTRACTOR TO SEAL AFTER COMPLETION OF TESTS. PIPE TO BE LAID CONTINUOUS, FOR PIPE 42" & GREATER CHANNEL FILLETS POURED AND TOP HALF OF PIPE REMOVED, EXCEPT AT BENDS, WHERE A HYDRAULICALLY SMOOTH CHANNEL SHALL BE MADE WITH POURED GRADE "A" CONCRETE 5'-0" DIA. FOR 18"-36" PIPE 6'-0" DIA. FOR 42" PIPE -FLEXIBLE WATER-TIGHT MANHOLE JOINTS "A-LOK", PRESS-WEDGE OR "KOR-N-SEAL" WENTENETENENAL TENET STONE OR SAND--PRECAST BASE SECTION





# SANITARY SEWER MANHOLE

# (8" THRU 15" DIA. SEWERS )

COVER TO BE EMBASSED
"GROSSE POINTE WOODS SEWER"

1. COVER EQUAL TO EAST JORDAN 1040 ZPT
WITH GASKET SEAL COVER WITH 1"
ANCHOR BASE FLANGE HOLES, FOUR (4)
AS SHOWN. WEIGHT = 400 LBS. WHEN
& WHERE SPECIFIED

2. FOUR (4) CADMIUM COATED 5/8" THREADED
STUDS, 3/4" X 2" X 1/8" FLAT WASHERS
& NUTS

3. FOUR (4) 3/4" X 2" X 1/16" NEOPRENE
SEALING WASHERS

4. 1" DIA PUBBER O-RING CASKETS LD = 36" MIN

- 4. 1" DIA. RUBBER O-RING GASKETS I.D.-36" MIN. DUROMETER 20, MAX. 40
  5. FOUR (4) 5/8" THREADED INSERTS CAST AS
- SHOWN

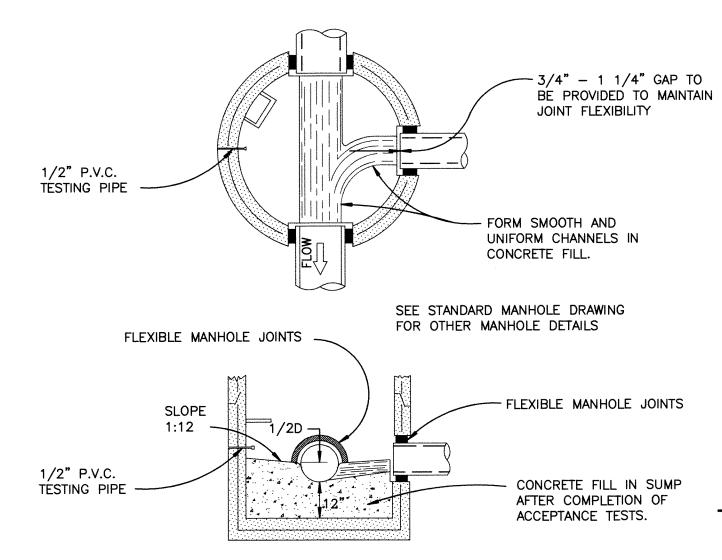
  6. 4" OR 6" GRADE RINGS WITH FINISH TOP AND BOTTOM SURFACES PER A.S.T.M. C 478 SPECIFICATIONS, MAXIMUM 12" ADJUSTMENT. BRICK AND MORTAR LEVELING COURSES MAY BE USED WITH WATER AND SEWER DEPARTMENT APPROVAL ONLY.

  7. FORM OUTSIDE MANHOLE & COMPLETELY FILL SPACE WITH STIFF MIN. 6 BAG MIX CONCRETE.

USE AIR ENTRAINED CEMENT.

# WATERPROOF MANHOLE FRAME & COVER

33 3/4"



# SUMP MANHOLE

FOR
TESTING, CLEANING & DEWATERING

# SANITARY SEWER MANHOLE

( 18" THRU 42" DIA. SEWERS )

# INTERIOR DROP ASSEMBLY

( ONLY WITH SEWER AND WATER DEPARTMENT APPROVAL )

# EXTERIOR DROP CONNECTION

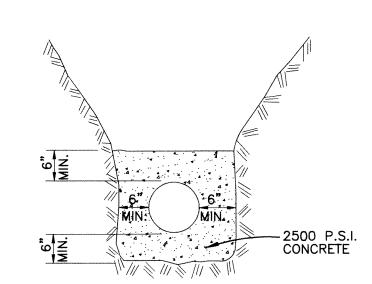
FOR ALL DROP CONNECTIONS

# MAXIMUM TRENCH WIDTH = O.D. + 12" FOR 18" - 36" I.D. O.D. + 24" FOR 42" I.D. & LARGER INITIAL BACKFILL: TYPE I FOR DEWATERED TRENCHES TYPE III FOR UN-DEWATERED TRENCHES TYPE III FOR ALL DEWATERED TRENCHES 2. TYPE I OR II FOR ALL UN-DEWATERED TRENCHES

# BEDDING & TRENCH DETAIL, 18" & LARGER SEWER

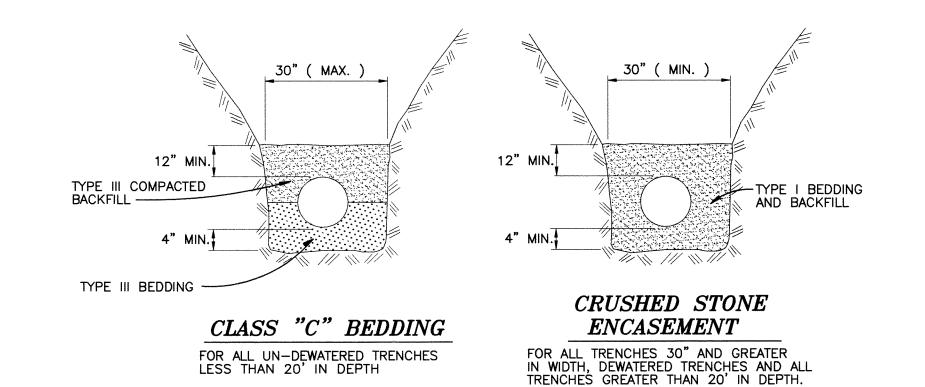
CLASS C

NOTE: APPROVAL MAY BE GIVEN TO ALTERNATE MATERIALS AND METHODS TO ACHIEVE CLASS C BEDDING.



# CONCRETE ENCASEMENT DETAIL

- 1. PLACE 2,500 PSI CONCRETE AGAINST UNDISTURBED EARTH FOR ENTIRE WIDTH OF TRENCH.
- FOR SANITARY SEWER IN EXCESS OF 15 INCHES IN DIAMETER CLASS V REINFORCED PIPE MAY BE SUBSTITUTED FOR CONCRETE ENCASEMENT, WITH OWNER'S APPROVAL.



# BEDDING & TRENCH DETAIL, 6"-15" SEWERS

# GENERAL PIPE BEDDING TRENCH NOTES

- 1. THE CONTRACTOR SHALL INSTALL THE PIPE IN ACCORDANCE WITH THE CLASS BEDDING DETAIL REQUIRED FOR THE TYPE OF PIPE DEPTH (MEASURED TO THE TOP OF THE PIPE), AND TRENCH WIDTH (MEASURED ACROSS THE TRENCH AT THE TOP OF THE PIPE) CONSTRUCTED. A CONTRACTOR MAY ALWAYS USE A HIGHER QUALITY BEDDING CLASS THAN REQUIRED. ANY OTHER VARIATIONS MUST BE APPROVED IN WRITING BY THE ENGINEER.
- 2. CRUSHED STONE ENCASEMENT SHALL BE UTILIZED FOR ALL DEWATERED GROUND TRENCHES AND SHALL UTILIZE A TRENCH WIDTH OF 30" ( MINIMUM ).
- 3. BACKFILL MATERIAL SHALL BE AS FOLLOWS:
- TYPE I: SHALL CONSIST OF WELL GRADED CRUSHED STONE. THE STONE SHALL CONFORM TO ASTM D 448 #5, 56, 57, 6, 67 & 68, ASTM D 2321 CLASS I, OR ALTERNATIVE APPROVED BY THE ENGINEER ANY MATERIAL INCORPORATED SHALL PROVIDE A MINIMUM OF 95% CRUSHED MATERIAL. MDOT COURSE AGGREGATES 6A, 6AA, 9A, 17A & 25 SERIES ARE ALSO APPROVED FOR USE IF THEY ARE MANUFACTURED WITH SUFFICIENT CRUSHED MATERIAL AND NO STONE IS LARGER THAN 1".
- TYPE II: SHALL CONSIST OF WELL GRADED COURSE SANDS AND GRAVEL ( 1 INCH MAXIMUM DIAMETER )
  CONTAINING A SMALL PERCENTAGE OF FINES. THE MATERIAL SHALL CONFORM TO ASTM D
  2321 CLASS II AND SHALL INCLUDE PEA PEBBLE AND MDOT AGGREGATES 20 SERIES, 21
  SERIES, 22 SERIES, 23A, 26A, 28 SERIES & 31 SERIES. 95% MINIMUM DENSITY REQUIRED.
  TYPE II MAY BE SUBSTITUTED FOR TYPE III BACKFILL.
- TYPE III: SHALL CONSIST OF FINE SAND AND CLAYEY GRAVELS CONFORMING TO ASTM 2321 CLASS III AND SHALL INCLUDE PEA PEBBLE. IT SHALL NOT CONTAIN ANY STONE LARGER THAN 1 INCH IN DIAMETER AND SHALL REQUIRE 95% MINIMUM DENSITY.

DATE: 2/6/07

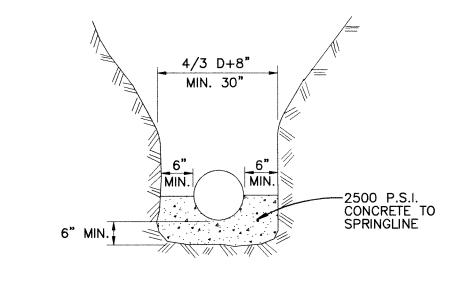
CHECKED BY

FEBRUARY, 2007

PROJECT NO.

DRAWN BY

KJP/KAO



# CONCRETE CRADLE DETAIL

1. CONCRETE CRADLE MAY BE SPECIFIED AT OWNER'S DISCRETION WHERE THE TRENCH WIDTH IS EXCESSIVE, OR WHERE THE TRENCH IS NOT SUITABLE FOR PIPE LAYING.

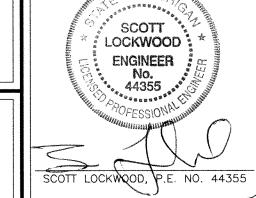
# CITY OF GROSSE POINTE WOODS SANITARY SEWER (1 of 2)

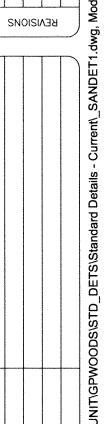


ANDERSON, ECKSTEIN AND WESTRICK, INC.
Civil Engineers • Surveyors • Architects
51301 Schoenherr Road, Shelby Township, Michigan 48315
Phone 586•726•1234 Fax 586•726•8780

JOSEPH J. AHEE JR. : DPW DIRECTOR

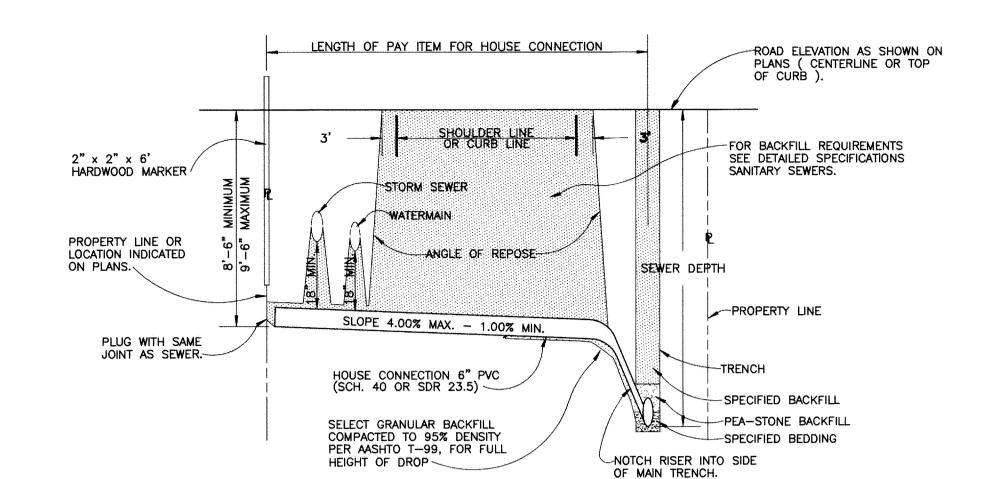
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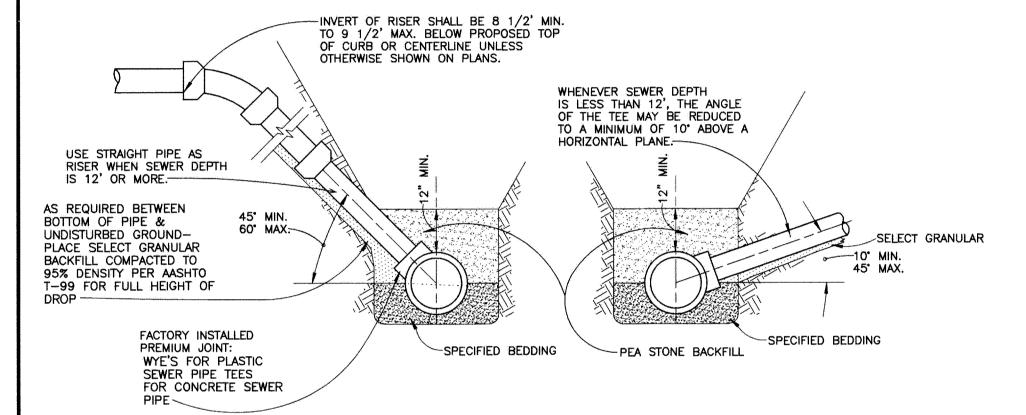




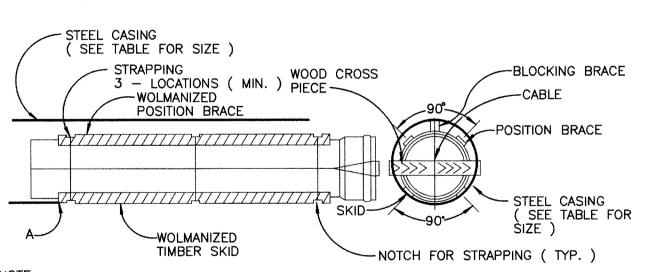
*KENISIONS* 

## SANITARY SEWER CONSTRUCTION NOTES





# SANITARY SEWER HOUSE/ BUILDING CONNECTION



NOTE:
THE ENDS OF THE CASING SHALL
BE SEALED AFTER THE SEWER
IS INSTALLED THROUGH THE CASING

**KEVISIONS** 

*KENIZIONZ* 

PIPE SIZE	RECOMMENDED MINIMUM CASTING DIAMETER	MINIMUM WALL THICKNESS
6"	12"	.375
8"	16"	.375
10"	18"	.375
12"	20"	.375
15"	24"	.406
18" & 21"	36"	.532
24"	42"	.563
27" & 30"	48"	.625
36"	<b>54</b> "	.688
42"	60"	.750
48"	66"	.813

STEEL CASING REQUIREMENTS

- ALL CONSTRUCTION SHALL CONFORM TO THE CURRENT STANDARDS AND SPECIFICATIONS OF THE CITY OF GROSSE POINTE WOODS SEWER AND WATER DEPARTMENT. ALL SANITARY SEWER CONSTRUCTION SHALL HAVE COMPETENT FULL TIME INSPECTION PROVIDED BY OR CAUSED TO BE PROVIDED BY THE CITY OF GROSSE POINTE WOODS.
- 2. AT ALL CONNECTIONS TO CITY OF GROSSE POINTE WOODS SANITARY SEWERS OR TO EXTENSIONS THERE TO, AND BEFORE START OF CONSTRUCTION, THE CONTRACTOR MUST REQUEST AND HAVE IN HIS POSSESSION AN APPROVED CONNECTIONS PERMIT ISSUED BY THE CITY OF GROSSE POINTE WOODS SEWER & WATER DEPARTMENT. THE CONTRACTOR SHALL NOTIFY THE CITY OF GROSSE POINTE WOODS SEWER AND WATER DEPARTMENT 48 HOURS PRIOR TO THE BEGINNING OF ANY CONSTRUCTION.
- NO SEWER INSTALLATION SHALL HAVE AN INFILTRATION EXCEEDING 50 GALLONS PER INCH OF DIAMETER PER MILE OF PIPE PER 24 HOUR PERIOD. EXFILTRATION TESTING SHALL BE CONDUCTED WHERE GROUND WATER IS INSUFFICIENT. ALL INSTALLATIONS SHALL ALSO PASS LOW PRESSURE AIR TEST AS SPECIFIED IN THE CITY OF GROSSE POINTE WOODS STANDARD SPECIFICATIONS.

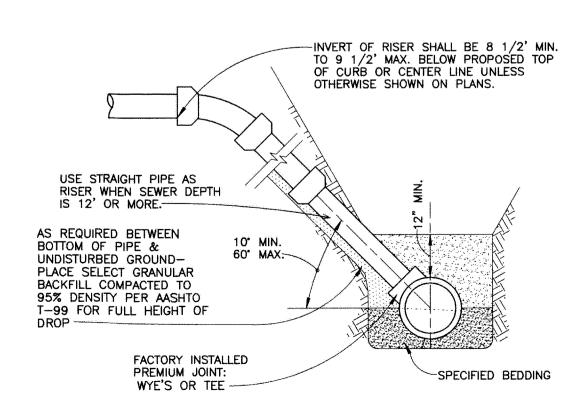
ABS COMPOSITE PIPE AND ANY APPROVED PLASTIC PIPE SHALL BE SUBJECT TO DEFLECTION TEST 30 DAYS AFTER CONSTRUCTION WITH A NINE SIDED MANDREL. THE CONTRACTOR MUST SUPPLY THE MANDREL AND PERFORM THE TEST. THE OWNER WILL WITNESS THE TEST. DEFLECTION SHALL NOT EXCEED 5%. THE OWNER OR THEIR REPRESENTATIVE RESERVES THE RIGHT TO TEST THE SEWER FOR DEFLECTION NOT TO EXCEED 7% DURING THE PERIOD OF THE MAINTENANCE BOND. ANY SEWER FOUND EXCEEDING THESE LIMITS SHALL BE REPLACED BY AND AT THE CONTRACTOR'S EXPENSE.

AS PART OF THE FINAL INSPECTION, THE CONTRACTOR SHALL PROVIDE FOR TELEVISION INSPECTION OF THE SANITARY SEWER LINES INSTALLED UNDER THIS CONTRACT. THE CONTRACTOR SHALL ARRANGE FOR, ENGAGE AND PAY ALL EXPENSES INVOLVED FOR THE SERVICES OF A COMPETENT COMPANY TO PERFORM THIS TELEVISION INSPECTION. THE INSPECTION SHALL BE CARRIED OUT UNDER THE DIRECT SUPERVISION OF THE ENGINEER WITH ALL TELEVISION INSPECTION BEING OBSERVED BY REPRESENTATIVES OF THE OWNER OR ENGINEER AND THE CONTRACTOR. ANY TELEVISION VIEWING PERFORMED THE ABSENCE OF THE ENGINEER OR A REPRESENTATIVE OF THE OWNER SHALL NOT BE CONSIDERED A PART OF THE FINAL INSPECTION. THE COLOR TELEVISION CAMERA SHALL BE ONE SPECIFICALLY DESIGNED AND CONSTRUCTED FOR SUCH INSPECTION. THE CAMERA SHALL BE OPERATIVE IN 100± HUMIDITY, HAVE A HIGH RESOLUTION LENS CAPLABLE OF SCANNING 360° CIRCUMFERENCE AND 270° ON A HORIZONTAL AXIS TO TELEVISE SEWER LINES AND LATERALS. ALL TELEVISION INSPECTION SHALL BE RECORDED ON VIDEO TAPE AND TURNED OVER TO THE OWNER FOR READY REFERENCE AT A LATER DATE. THE VIDEO RECORDING SHALL DISPLAY CONTINUOUSLY THE DATE, TIME AND ENGINEERING STATIONS AND SHALL PERIODICALLY DISPLAY THE NAME OF THE PROJECT, NAME OF THE AREA COVERED AND DIRECTION OF TRAVEL. THE TAPE MUST BE COMPATIBLE WITH RCA MODEL VKT-275 VIDEO CASSETTE PLAYER 1/2 INCH VHS FORMAT.

- 4. INFILTRATION SHALL BE TESTED BY THE OWNER UTILIZING CALIBRATED WEIRS OR FLUMES INSERTED IN THE PIPE FLOWLINE AT A MANHOLE. TEST SECTIONS SHALL GENERALLY BE LIMITED TO A MAXIMUM LENGTH OF ONE HALF MILE. THE OWNER RESERVES THE RIGHT TO TEST SHORTER PIPE LENGTH SEGMENTS IF HE DEEMS IT NECESSARY TO ASSURE THAT NO SEGMENT EXCEEDS THE INFILTRATION LIMITS.
- HOUSE OR BUILDING LEAD PIPE, WYES AND CAPS SHALL BE SOLID WALL PLASTIC PIPE, ABS (A.S.T.M. D-2751, SDR 23.5) OR PVC (A.S.T.M. D-2241, SDR 23.5 OR A.S.T.M. D-2466, SCH. 40) WITH JOINTS AS SPECIFIED IN NOTE #15. THE JOINT BETWEEN TWO DISSIMILAR SIZES OR TYPES OF BUILDING LEAD PIPE SHALL BE MADE WITH A PROPER SIZE FERNCO DONUT, OR APPROVED EQUAL, WITH POLYVINYL JOINT SEALER. A RUBBER BOOT WITH CLAMPS IS NOT ACCEPTABLE.
- 6. ALL SEWER PIPE SHALL BE INSTALLED IN CLASS "C" BEDDING OR BETTER, IN CONFORMANCE WITH THE DETAILS PROVIDED.
- ALL NEW MANHOLES SHALL HAVE WATER AND SEWER DEPARTMENT APPROVED FLEXIBLE, WATER-TIGHT SEALS WHERE PIPES PASS THROUGH WALLS. MANHOLES SHALL BE PRECAST REINFORCED CONCRETE IN ACCORDANCE WITH ASTM C478 CURRENT SPECIFICATIONS. PRECAST MANHOLE JOINTS AND GASKETS SHALL BE MODIFIED TONGUE AND GROOVE IN ACCORDANCE WITH ASTM C361 CURRENT SPECIFICATIONS. PRECAST MANHOLE CONE SECTIONS SHALL BE CITY OF GROSSE POINTE WOODS APPROVED SEWER & WATER MODIFIED ECCENTRIC CONE TYPE. ALL MANHOLES SHALL BE PROVIDED WITH GASKET SEAL FRAMES. MANHOLE STEPS SHALL NORMALLY BE PROVIDED ON A BACK WALL OF THE MANHOLE FURTHEST FROM TRAFFIC.
- AT THE CONNECTIONS TO MANHOLES, SEWERS OR EXTENSIONS THERETO, DROP CONNECTIONS WILL BE REQUIRED WHEN THE DIFFERENCE IN INVERT ELEVATIONS EXCEEDS 18 INCHES. THE DROP CONNECTIONS WILL BE EXTERIOR TYPE AS APPROVED BY THE SEWER AND WATER DEPARTMENT. THE USE OF INTERIOR TYPE DROP CONNECTIONS WILL BE BASED UPON MANHOLE SIZE, GROUND WATER AND SOIL CONDITIONS AT THE LOCATION WHERE THE TAP WILL BE PERFORMED.
- 9. EXISTING PRE-CAST CONCRETE MANHOLES SHALL BE TAPPED WITH THE "KOR-N-SEAL" METHOD FOR SEWERS 6" THRU 15" IN DIAMETER. EXISTING BRICK AND MANHOLE TAPS FOR 18" DIAMETER SEWERS AND LARGER WILL HAVE HOLES DRILLED AT 4 INCHES CENTER TO CENTER AROUND THE PERIPHERY OF THE OPENING TO CREATE A PLANE OF WEAKNESS BEFORE BREAKING OUT THE SECTION. NON-SHRINK GROUT SHALL BE USED TO SEAL THE OPENING AND A CONCRETE COLLAR SHALL BE POURED 12 INCHES AROUND THE PIPE AND EXTEND 12 INCHES BEYOND THE OPENING.
- 10. NEW MANHOLES CONSTRUCTED DIRECTLY ON CITY OF GROSSE POINTE WOODS SANITARY SEWER SHALL BE PROVIDED WITH COVERS READING "GROSSE POINTE WOODS SANITARY SEWER" IN RAISED LETTERS. NEW MANHOLES BUILT OVER ANY EXISTING SANITARY SEWERS SHALL HAVE MONOLITHIC POURED BOTTOMS.

- 11. PRIOR TO ANY EXCAVATION, THE CONTRACTOR SHALL TELEPHONE MISS DIG
  ( 1-800-482-7171 ) FOR THE LOCATION OF UNDERGROUND GAS AND CABLE FACILITIES
  AND SHALL ALSO NOTIFY REPRESENTATIVES OF OTHER UTILITIES LOCATED IN THE
  VICINITY OF THE WORK.
  - THE CONTRACTOR SHALL ASSUME RESPONSIBILITY FOR THE PROTECTION OF ALL EXISTING UTILITIES DURING CONSTRUCTION. ALL COSTS FOR LOCATING, REMOVING AND REPLACING OR RELOCATING THESE UTILITIES SHALL BE INCLUDED IN THE COST OF CONSTRUCTING THE SANITARY SEWER. ALL UTILITIES DAMAGED DURING CONSTRUCTION SHALL BE REPAIRED WITH LIKE MATERIAL. THE CONTRACTOR SHALL VERIFY THE DEPTH AND HORIZONTAL LOCATION OF ALL EXISTING UTILITIES BEFORE ANY WORK IS STARTED. THE EXACT LOCATION OF EXISTING UTILITIES SHALL BE DETERMINED BY
- 12. THE CONTRACTOR SHALL MAINTAIN ALL EXISTING SANITARY SEWER, WATER OR STORM SEWER SERVICE CONNECTIONS DURING CONSTRUCTION. ANY ADJUSTMENTS OR REPAIRS TO THESE SERVICES SHALL BE MADE BY THE CONTRACTOR AND THE COST SHALL BE INCLUDED IN THE COST FOR CONSTRUCTING THE SANITARY SEWER, UNLESS OTHERWISE PROVIDED IN THE CONTRACT.
- 13. SEWER PIPE MATERIAL:
- 1. 8" THROUGH 15" PIPE SHALL BE A.B.S. ( ACRYLONITRILE—BUTADIENE—STYRENE )
  OR P.V.C. ( POLY—VINYL—CHLORIDE ) COMPOSITE SEWER PIPE CONFORMING TO
  THE CURRENT ASTM D2680 SPECIFICATIONS WITH TYPE SC JOINTS FOR A.B.S. AND
  GASKETED JOINTS FOR P.V.C. SOLID WALL PIPE SHALL BE SDR 23.5.
- 2. 18" AND LARGER PIPE SHALL BE REINFORCED CONCRETE CIRCULAR SEWER PIPE CONFORMING TO THE CURRENT ASTM SPECIFICATION C-76 ( WALL C ) WITH SIZE AND CLASS AS INDICATED ON THE PLANS. ALL REINFORCED CONCRETE SEWER PIPE SHALL BE CAST WITH REINFORCING STEEL EXTENDING INTO THE SPIGOTS. ALL JOINTS AND GASKETS SHALL BE MODIFIED TONGUE AND GROOVE, CONFORMING WITH THE REQUIREMENTS OF ASTM ( C 361 ).
- JUCTILE IRON PIPE-DOUBLE CEMENT LINED CLASS 54 PER ANSI A21.51 AND A21.4. JOINTS AND GASKETS SHALL BE PUSH-ON TYPE PER ANSI A21.11 (TYTON, BELL, TITE, FAST TITE OR APPROVED EQUAL).
- 14. IN INDUSTRIAL AREAS, PRIVATE SERVICE CONNECTIONS MADE TO THE SERVICE LEAD MUST HAVE AN ACCESSIBLE SAMPLING AND MONITORING MANHOLE. THE MANHOLE SHALL BE LOCATED ON PRIVATE PROPERTY AT A LOCATION APPROVED BY THE CITY OF GROSSE POINTE WOODS SEWER AND WATER DEPARTMENT. VITRIFIED PIPE MAY NOT BE USED.
- 15. BUILDING LEAD CONNECTIONS SHALL BE MADE WITH 6" WYES FOR A.B.S. AND P.V.C. PIPE AND 6" TEES FOR CONCRETE PIPE. WYES FOR ABS AND P.V.C. PIPE SHALL BE FACTORY FABRICATED ( NOT EXTRUDED ) AND SHALL BE CHECKED FOR IRREGULARITIES WHICH COULD AFFECT THE DEFLECTION TEST PRIOR TO INSTALLATION.
- 16. A CITY, WAYNE COUNTY ROAD COMMISSION, AND/OR MICHIGAN DEPARTMENT OF TRANSPORTATION PERMIT IS REQUIRED FOR ALL CONSTRUCTION WITHIN THEIR ROAD RIGHT-OF-WAYS. IT IS THE CONTRACTOR'S RESPONSIBILITY TO SECURE ALL PERMITS AND BONDS PRIOR TO CONSTRUCTION, OR INSURE THAT ALL REQUIRED PERMITS AND BONDS HAVE BEEN OBTAINED PRIOR TO CONSTRUCTION.
- 17. THE CONTRACTOR SHALL ABIDE BY ALL THE REQUIREMENTS OF THE ROAD RIGHT—OF—WAY OWNER REGARDING CONSTRUCTION OF WATER AND SEWER MAINS, MAINTAINING TRAFFIC, BARRICADING, BORING, BACKFILL AND RESTORATION.
- 18. NO WASTE EXCAVATION MATERIAL SHALL BE DISPOSED OF BY PLACING IT IN ANY FLOODPLAIN OR WET LAND OF THE STATE UNLESS APPROPRIATE PERMITS HAVE BEEN ISSUED. THE CONTRACTOR OR PROPERTY OWNER MUST OBTAIN LOCAL FILL PERMITS FOR ANY MATERIALS DEPOSITED UPON LANDS WITHIN ANY CITY, VILLAGE OR TOWNSHIP.
- 19. THE CONTRACTOR SHALL FURNISH A DETAILED PLAN TO THE WAYNE COUNTY DEPARTMENT OF PUBLIC WORKS AND OBTAIN A SOIL EROSION CONTROL PERMIT UNDER THE ACT 347 PRIOR TO MAKING ANY EARTH CHANGES.
- 20. PRIOR TO THE START OF CONSTRUCTION, THE CONTRACTOR SHALL FURNISH MATERIAL CERTIFICATES TO THE OWNER VERIFYING THAT ALL THE MATERIALS USED ON THE PROJECT ARE IN ACCORDANCE WITH THE SPECIFICATIONS.
- 21. IF AN EXISTING GRAVEL ROAD IS DISTURBED BY CONSTRUCTION EQUIPMENT OR BY STOCKPILING OF MATERIALS OUTSIDE THE EXCAVATION AREA, A MINIMUM OF 8" OF 23A GRAVEL SHALL BE USED TO REPLACE THE DISTURBED
- 22. ALL CONSTRUCTION CHANGES MUST HAVE WRITTEN APPROVAL OF THE PROJECT ENGINEER.
- 23. THE CONTRACTOR SHALL BE REQUIRED TO COMPLETE ALL WORK IN AN EXPEDITIOUS MANNER AND SHALL NOT STOP CONSTRUCTION EXCEPT FOR REASONS BEYOND HIS CONTROL SUCH AS, BUT NOT LIMITED TO STRIKES, WEATHER AND UNAVAILABILITY OF MATERIALS.

- 24. THE CONTRACTOR SHALL PROVIDE A ONE YEAR MAINTENANCE AND GUARANTEE BOND TO THE CITY, DATED FROM THE TIME OF FINAL ACCEPTANCE BY THE CITY.
- 25. THE CONTRACTOR SHALL HAVE THE OPTION OF STARTING CONSTRUCTION AT THE FIRST MANHOLE UPSTREAM OF THE POINT OF CONNECTION TO THE EXISTING SYSTEM. A TEMPORARY TEST MANHOLE MAY BE USED NEAR THE POINT OF CONNECTION RATHER THAN A PERMANENT ONE, AND THE CONTRACTOR MAY LEAVE THE BASE OF THE TEMPORARY MANHOLE IN PLACE. LINES UP TO 400 FEET IN LENGTH ( TOTAL LENGTH OF EXTENSION ) MAY BE TESTED WITHOUT PLACEMENT OF THE MANHOLE BASE PROVIDED THE LINES ARE TESTED AND PUT IN SERVICE IMMEDIATELY FOLLOWING CONSTRUCTION.
- 26. THE ENTIRE PROJECT AREA OF PUBLICLY FUNDED PROJECTS, AND ALL AREAS NOT UNDER THE OWNERSHIP OF ANY PRIVATE DEVELOPER FOR PRIVATELY FUNDED PROJECTS, SHALL BE VIDEO TAPED IN COLOR PRIOR TO THE START OF CONSTRUCTION. THE TAPE SHALL BE UTILIZED BY THE CITY TO DETERMINE CONSTRUCTION RELATED DAMAGE AND TO ASSURE ADEQUATE RESTORATION. THE TAPE SHALL BE STANDARD 1/2" VHS FORMAT.
- 27. ALL PRECAST MANHOLES, SLAB BASES AND CONCRETE PIPE SHALL BE MANUFACTURED WITH TYPE II, IP OR IIA CEMENT. ALL CONCRETE FOR CHANNELIZATION SHALL BE MADE WITH TYPE II, IP OR IIA CEMENT.
- 28. ALL TERMINAL MANHOLES AND ANY INTERMEDIATE MANHOLES WHERE FUTURE DROP CONNECTIONS ARE A POTENTIAL SHALL BE 1 FOOT LARGER IN DIAMETER THAN WOULD OTHERWISE BE REQUIRED, AND SHALL BE NO SMALLER THAN 5 FEET IN DIAMETER.
- 29. DUCTILE IRON PIPE SHALL BE USED FOR THE SANITARY SEWER AT ALL WATER MAIN AND SANITARY SEWER CROSSINGS WITH LESS THAN 2 (TWO) FEET OF VERTICAL CLEARANCE AND WHERE THE WATER MAIN CROSSES BELOW THE SEWER, REGARDLESS OF VERTICAL CLEARANCE DISTANCE. THE DUCTILE IRON PIPE SHALL BE OF EQUAL SIZE (OR LARGER) AS THE PROPOSED SEWER AND SHALL EXTEND FROM MANHOLE TO MANHOLE.
- 30. TRENCH DETAIL "A" ( T.D.-A ) BACKFILL TO A POINT 12" ABOVE THE PIPE SHALL BE AS SPECIFIED ON THE PLANS. THE REMAINDER OF THE BACKFILL SHALL BE MADE WITH SUITABLE EXCAVATED MATERIAL ( EXCLUDING BLUE CLAY ) PLACED IN ONE-FOOT LAYERS WITH EACH LAYER BEING THOROUGHLY COMPACTED BY APPROVED MECHANICAL METHODS, OR OTHER EFFECTIVE MEANS HAVING THE APPROVAL OF THE ENGINEER, TO A DENSITY EQUIVALENT TO THE UNDISTURBED ADJACENT SOIL, OR 90% OF MAX. UNIT WEIGHT, WHICHEVER IS GREATER.
- WHEN TRENCH DETAIL "A" IS SPECIFIED, THERE WILL BE NO ADDITIONAL COMPENSATION FOR SAND BACKFILL. ALL AREAS OF SUCH TRENCH DETAIL "A" SHALL BE SURFACED WITH GRAVEL, STONE, PAVEMENT OR TOPSOIL IN ACCORDANCE WITH THE REQUIREMENTS OF RESTORATION ( SEE NOTE 23 ).
- 31. TRENCH DETAIL "B" ( T.D.-B ) BACKFILL TO A POINT 12" ABOVE THE PIPE SHALL BE AS SPECIFIED ON THE PLANS. THE REMAINDER OF ALL TRENCHES UNDER PUBLIC ROADWAYS AND WITHIN THAT AREA BELOW A LINE PROJECTED AT A 1 ON 1 SLOPE DOWN AND AWAY FROM A POINT 3 FEET OUTSIDE OF THE BACK OF CURB, EDGE OF PAVEMENT OR EDGE OF SHOULDER AREA, OR AS SPECIFIED ON THE PLANS, SHALL BE BACKFILLED WITH BANKRUN SAND MEETING THE REQUIREMENTS OF POROUS MATERIAL, MOOT SEC. 8.02.05, CLASS II, AND IS TO BE COMPACTED TO 95% OF MAX. UNIT WEIGHT. WHEN TRENCH DETAIL B IS IN A DITCH OR TURF AREA, IT SHALL BE SURFACED WITH 2" TO 12" OF ORGANIC CLAY MATERIAL AND WITH 3" OF TOPSOIL. ALL OTHER AREAS OF TRENCH DETAIL B SHALL BE SURFACED WITH GRAVEL, STONE OR PAVEMENT IN ACCORDANCE WITH THE REQUIREMENTS OF RESTORATION ( SEE NOTE 23 ).
- 32. THE END OF A SANITARY LEAD SHALL BE CONSTRUCTED TO A MINIMUM DEPTH OF 8 1/2 FEET OR 9 1/2 FEET MAXIMUM BELOW THE PROPOSED GRADE AS SHOWN ON THE BUILDING LEAD DETAIL. THE LEAD LOCATION SHALL BE MARKED AS SHOWN IN THE DETAIL.
- 33. THE VERTICAL TOLERANCE FOR SANITARY MANHOLE RIM GRADES ARE AS FOLLOWS:
  - A) IN RIGHT OF WAY 0.00 FEET TO +0.25 FEET
  - B) NOT IN RIGHT OF WAY +0.25 FEET
- 34. MANHOLE STEPS SHALL BE FACTORY INSTALLED AT 16 INCHES CENTER TO CENTER SPACING. STEPS SHALL BE M.A. INDUSTRIES P.S.I. POLYPROPYLENE MSU #360 ALU POLY ( OR APPROVED EQUAL ).
- 35. THE CONTRACTOR IS REQUIRED TO CONTACT THE OFFICE OF THE WAYNE COUNTY PUBLIC WORKS COMMISSIONER AT 469-5325, 48 HRS. BEFORE CONSTRUCTION.



REQUIREMENT FOR FIELD TAP

CORE—DRILLING PORT IN SEWER WALL.
INSTALL PREMOLDED FLEXIBLE WATERTIGHT
BOOT TO RECEIVE SERVICE CONNECTION.
ALL JOINTS SHALL BE WATERTIGHT. NO PART
OF CONNECTION SHALL PROTRUDE INTO
MAINLINE I.D..

FIELD TAP DETAIL

# CITY OF GROSSE POINTE WOODS SANITARY SEWER (2 of 2)

# DEPARTMENT OF PUBLIC WORKS

APPROVED BY: JOSEPH J. AMEE JR.: DPW DIRECTOR

ANDERSON, ECKSTEIN AND WESTRICK, INC.
Civil Engineers • Surveyors • Architects
51301 Schoenherr Road, Shelby Township, Michigan 48315

Phone 586.726.1234 Fax 586.726.8780

PROJECT NO.

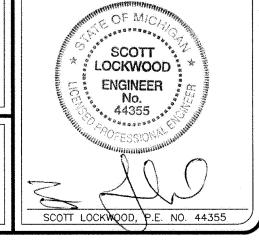
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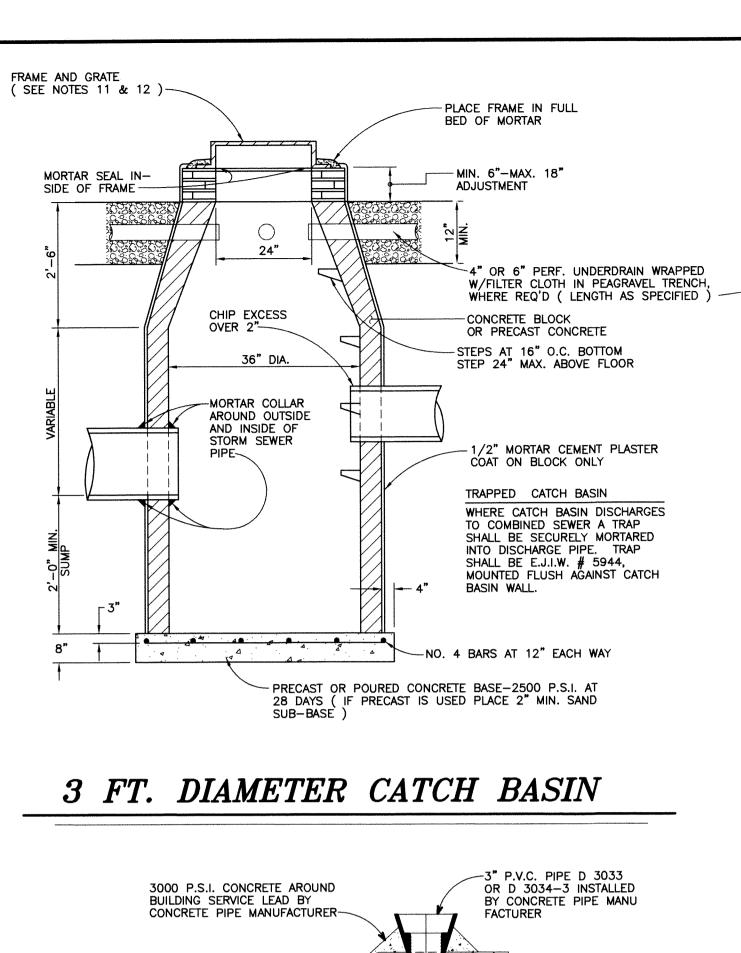
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FEBRUARY 2007

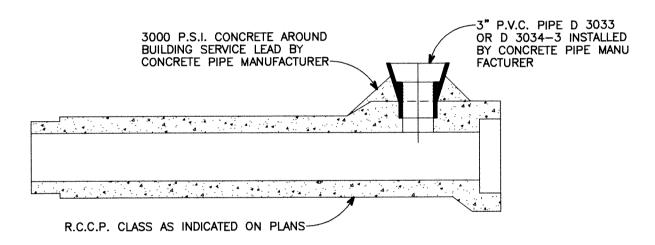
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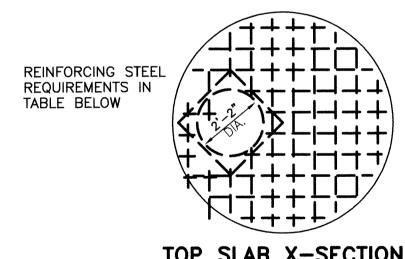
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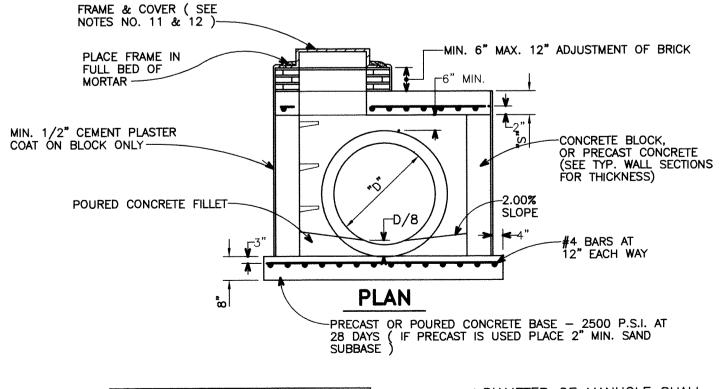
#### STANDARD WYE DETAIL IN CONCRETE PIPE FOR SUMP PUMP CONNECTION



*KENISIONS* 

*KENIZIONZ* 

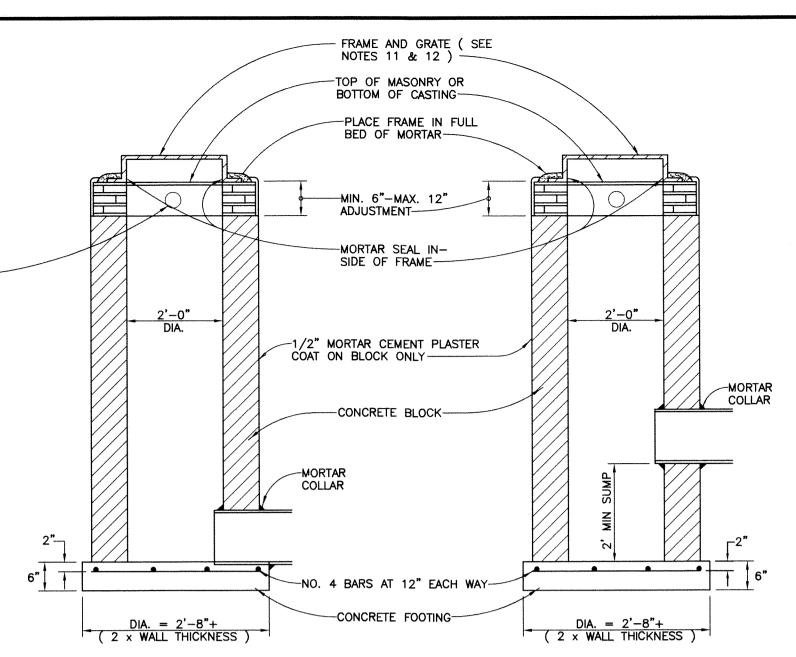
TOP SLAB X-SECTION



\* DIAMETER OF MANHOLE SHALL BE INCREASED AS SHOWN ON 7" OR LESS 4 9" 3/4" © 9" EA. WAY
42" 5 10" 3/4" © 9" EA. WAY
48"-54" 6 11" 7/8" © 9" EA. WAY
7 12" 1" © 9" EA. WAY THE PLANS DEPENDING ON THE ANGLE OF SEWERS 8 12" 1" @ 9" EA. WAY

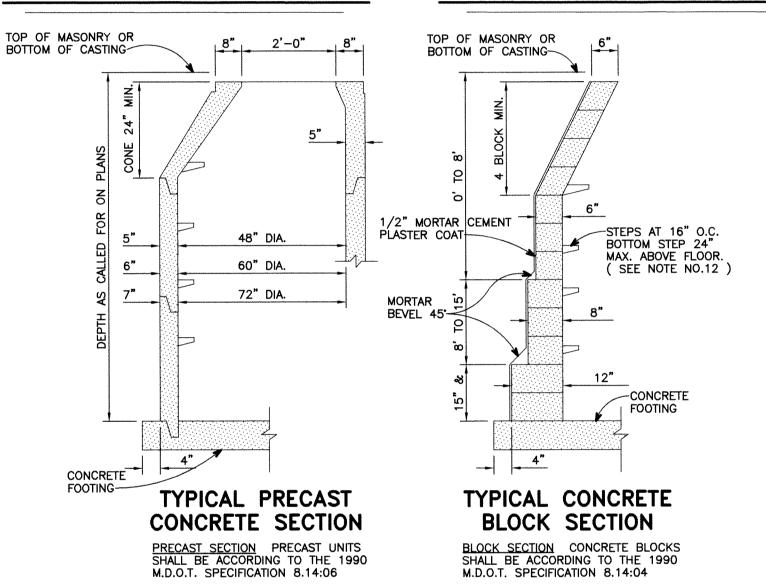
STORM SEWER MANHOLE

WITH FLAT SLAB TOP

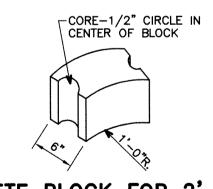


# 2 FT. DIAMETER INLET

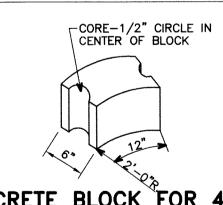
## 2 FT. DIAMETER CATCH BASIN



## TYPICAL WALL SECTIONS FOR ALL DRAINAGE STRUCTURES



CONCRETE BLOCK FOR 2'-0" DIAMETER DRAINAGE STRUCTURE



CONCRETE BLOCK FOR 4'-0" DIAMETER DRAINAGE STRUCTURE

# CONCRETE BLOCKS

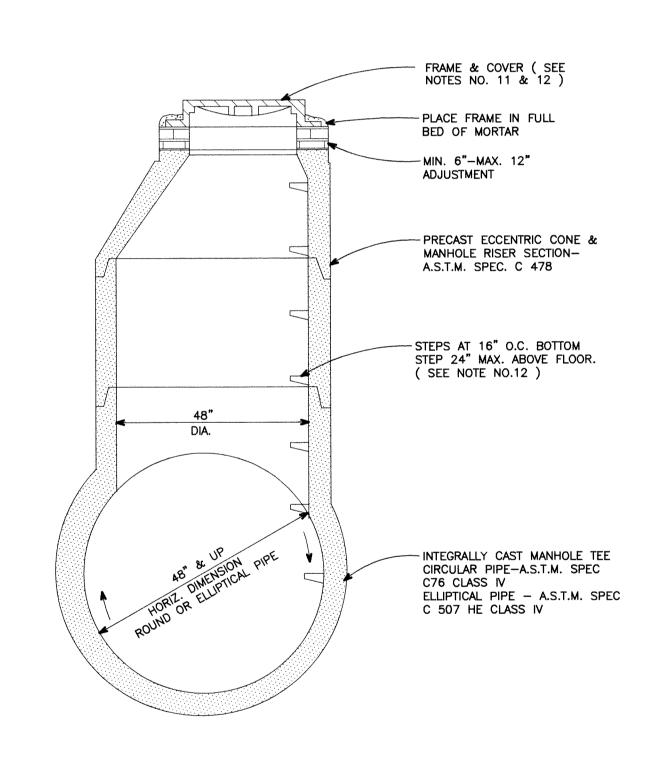
STORM SEWER TEE MANHOLE "B"

#### FRAME AND GRATE ( SEE NOTES 11 & 12 ) - PLACE FRAME IN FULL BED OF MORTAR -MIN. 6"-MAX. 12" MORTAR SEAL IN-**ADJUSTMENT** SIDE OF FRAME-1/2" MORTAR CEMENT PLASTER COAT ON BLOCK ONLY CONCRETE BLOCK OR PRECAST CONCRETE - STEPS AT 16" O.C. BOTTOM STEP 24" MAX. ABOVE FLOOR BOTTOM DIA. IF NOT ON SIZE ( I.D. PLANS ) 27" OR LESS 48" 30" TO 42" 48" TO 54" M.H. MAY BE INCREASED ON PLANS DEPENDING ON ANGLE OF SEWERS. BOTTOM DIAMETER -NO. 4 BARS AT 12" EACH WAY

# STORM SEWER MANHOLE "A"

PRECAST OR POURED CONCRETE BASE-2500 P.S.I. AT

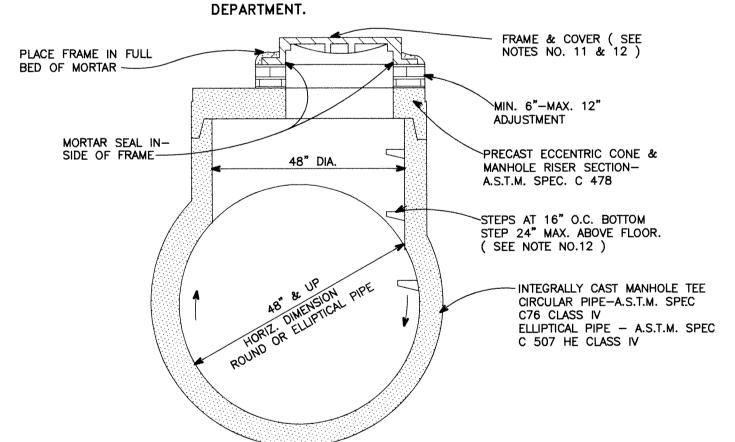
28 DAYS ( IF PRECAST IS USED PLACE 2" MIN. SAND



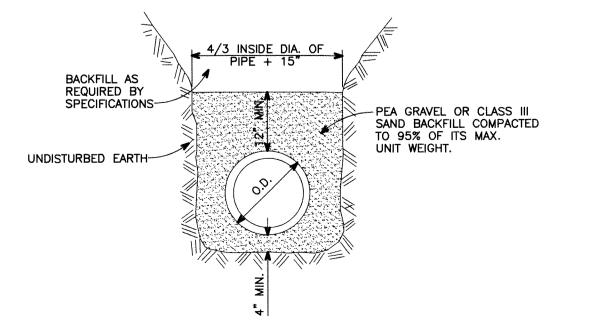
1. AT LEAST SEVENTY-TWO ( 72 ) HOURS PRIOR TO CONSTRUCTION, THE CONTRACTOR SHALL GIVE NOTIFICATION OF HIS INTENTION TO BEGIN CONSTRUCTION TO THE CITY OF GROSSE POINTE WOODS ENGINEERING DEPARTMENT, THE WAYNE COUNTY PUBLIC WORKS COMMISSION OR THE ROAD COMMISSION OF WAYNE COUNTY WHEN INSPECTIONS ARE NEEDED BY THAT AGENCY.

STORM SEWER NOTES

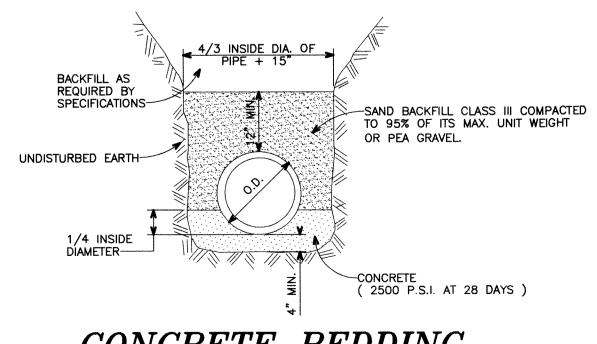
- PRIOR TO CONSTRUCTION, THE CONTRACTOR MUST HAVE IN HIS POSSESSION A COPY OF A VALID PERMIT TO CONSTRUCT A CONNECTION TO, OR AN EXTENSION OF, THE STORM WATER DRAINAGE SYSTEM, FROM REQUIRED AGENCY ON THE JOB AT ALL TIMES OF CONSTRUCTION.
- THE CONTRACTOR SHALL SECURE PERMITS FROM THE WAYNE COUNTY PUBLIC WORKS COMMISSION FOR ALL TAPS AND CROSSINGS OF COUNTY DRAINS AND SHALL PAY THE COSTS OF SAID PERMITS AND THE COST OF ANY INSPECTION CHARGES BY THAT AGENCY FOR WORK DONE UNDER THE
- PRIOR TO ANY CONSTRUCTION, THE CONTRACTOR SHALL TELEPHONE MISS DIG (1-800-482-7171) FOR LOCATION OF UNDERGROUND FACILITIES, AND SHALL ALSO NOTIFY REPRESENTATIVES OF ANY OTHER FACILITIES, LOCATED IN THE VICINITY OF THE WORK, WHICH MAY NOT BE HANDLED BY MISS DIG.
- ALL STORM WATER DRAINAGE SYSTEM CONSTRUCTION SHALL CONFORM TO THE CURRENT STANDARDS AND SPECIFICATIONS OF THE MUNICIPALITY, COUNTY ROAD COMMISSION AND/OR COUNTY PUBLIC WORKS COMMISSION AS APPLICABLE.
- ALL REINFORCED CONCRETE SEWER PIPE SHALL CONFORM TO ASTM SPECIFICATION C76 WITH CLASS DESIGNATION ON PLANS.
- UNLESS OTHERWISE INDICATED ON THE PLANS, ALL STORM SEWER JOINTS SHALL BE TONGUE AND GROOVE WITH RUBBER "O" RING GASKETS.
- UNLESS OTHERWISE INDICATED ON THE PLANS, ALL STORM SEWER BEDDING SHALL BE STANDARD BEDDING.
- ALL WYES AND BUILDING SERVICE CONNECTIONS SHALL BE 3" POLY VINYL CHLORIDE (PVC) SEWER PIPE SCH.40 OR SDR 23.5.
- 10. ALL STORM SEWER WYE OPENINGS SHALL BE FACTORY INSTALLED EXCEPT WHEN USING ABS TRUSS PIPE FOR SUMP PUMP DISCHARGE OUTLET. WHEREVER POSSIBLE SERVICE CONNECTIONS SHOULD DISCHARGE DIRECTLY INTO A CATCH BASIN.
- 11. UNLESS OTHERWISE NOTED ON THE PLANS, STRUCTURE FRAME AND COVERS SHALL BE AS FOLLOWS:
  - MANHOLE E.J.I.W. 1040 FRAME, TYPE A, SOLID COVER OR APPROVED EQUAL.
  - CATCH BASIN OR INLET ( PAVEMENT TYPE E.J.I.W. 5080 FRAME, TYPE M-3 ( 2, 4 OR 6 HOLE ) RESTRICTED COVER OR APPROVED EQUAL.
  - CATCH BASIN ( YARD TYPE ) E.J.I.W. 1045 FRAME, TYPE C ( 2 OR 4 SLOT ) VENTED COVER OR APPROVED EQUAL.
- 12. ALL CATCH BASIN COVERS SHALL BE RESTRICTED PER THE CITY OF GROSSE
- POINTE WOODS ENGINEER'S REQUIREMENTS. 13. STEPS TO BE INSTALLED DURING MANUFACTURING OF MANHOLE SECTION. STEPS MUST BE E.J.I.W. NO. 8503 M.A. INDUSTRIES P.S.I.
- POLYPROPYLENE OR APPROVED EQUAL. UNLESS OTHERWISE AUTHORIZED BY THE CITY ENGINEER, EACH STRUCTURE
- SHALL BE CONSTRUCTED TOTALLY OF EITHER PRE-CAST CONCRETE SEGMENTS OR BUILT-UP MORTAR & BLOCK.
- PRIVATE DEVELOPMENTS. BEFORE FINAL ACCEPTANCE, A FINAL INSPECTION MUST BE MADE BY THE OWNER AND ( 1 ) SET OF AS-BUILT SEPIA MYLARS AND ( 2 ) SETS OF BLUELINE PRINTS MUST BE SUBMITTED TO THE CITY OF GROSSE POINTE WOODS BUILDING



STORM SEWER TEE MANHOLE "B" WITH FLAT SLAB

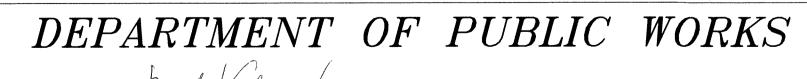


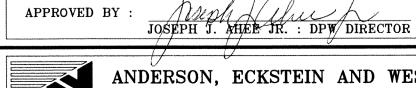
STANDARD BEDDING



CONCRETE BEDDING

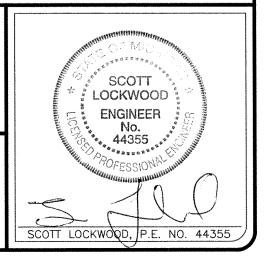


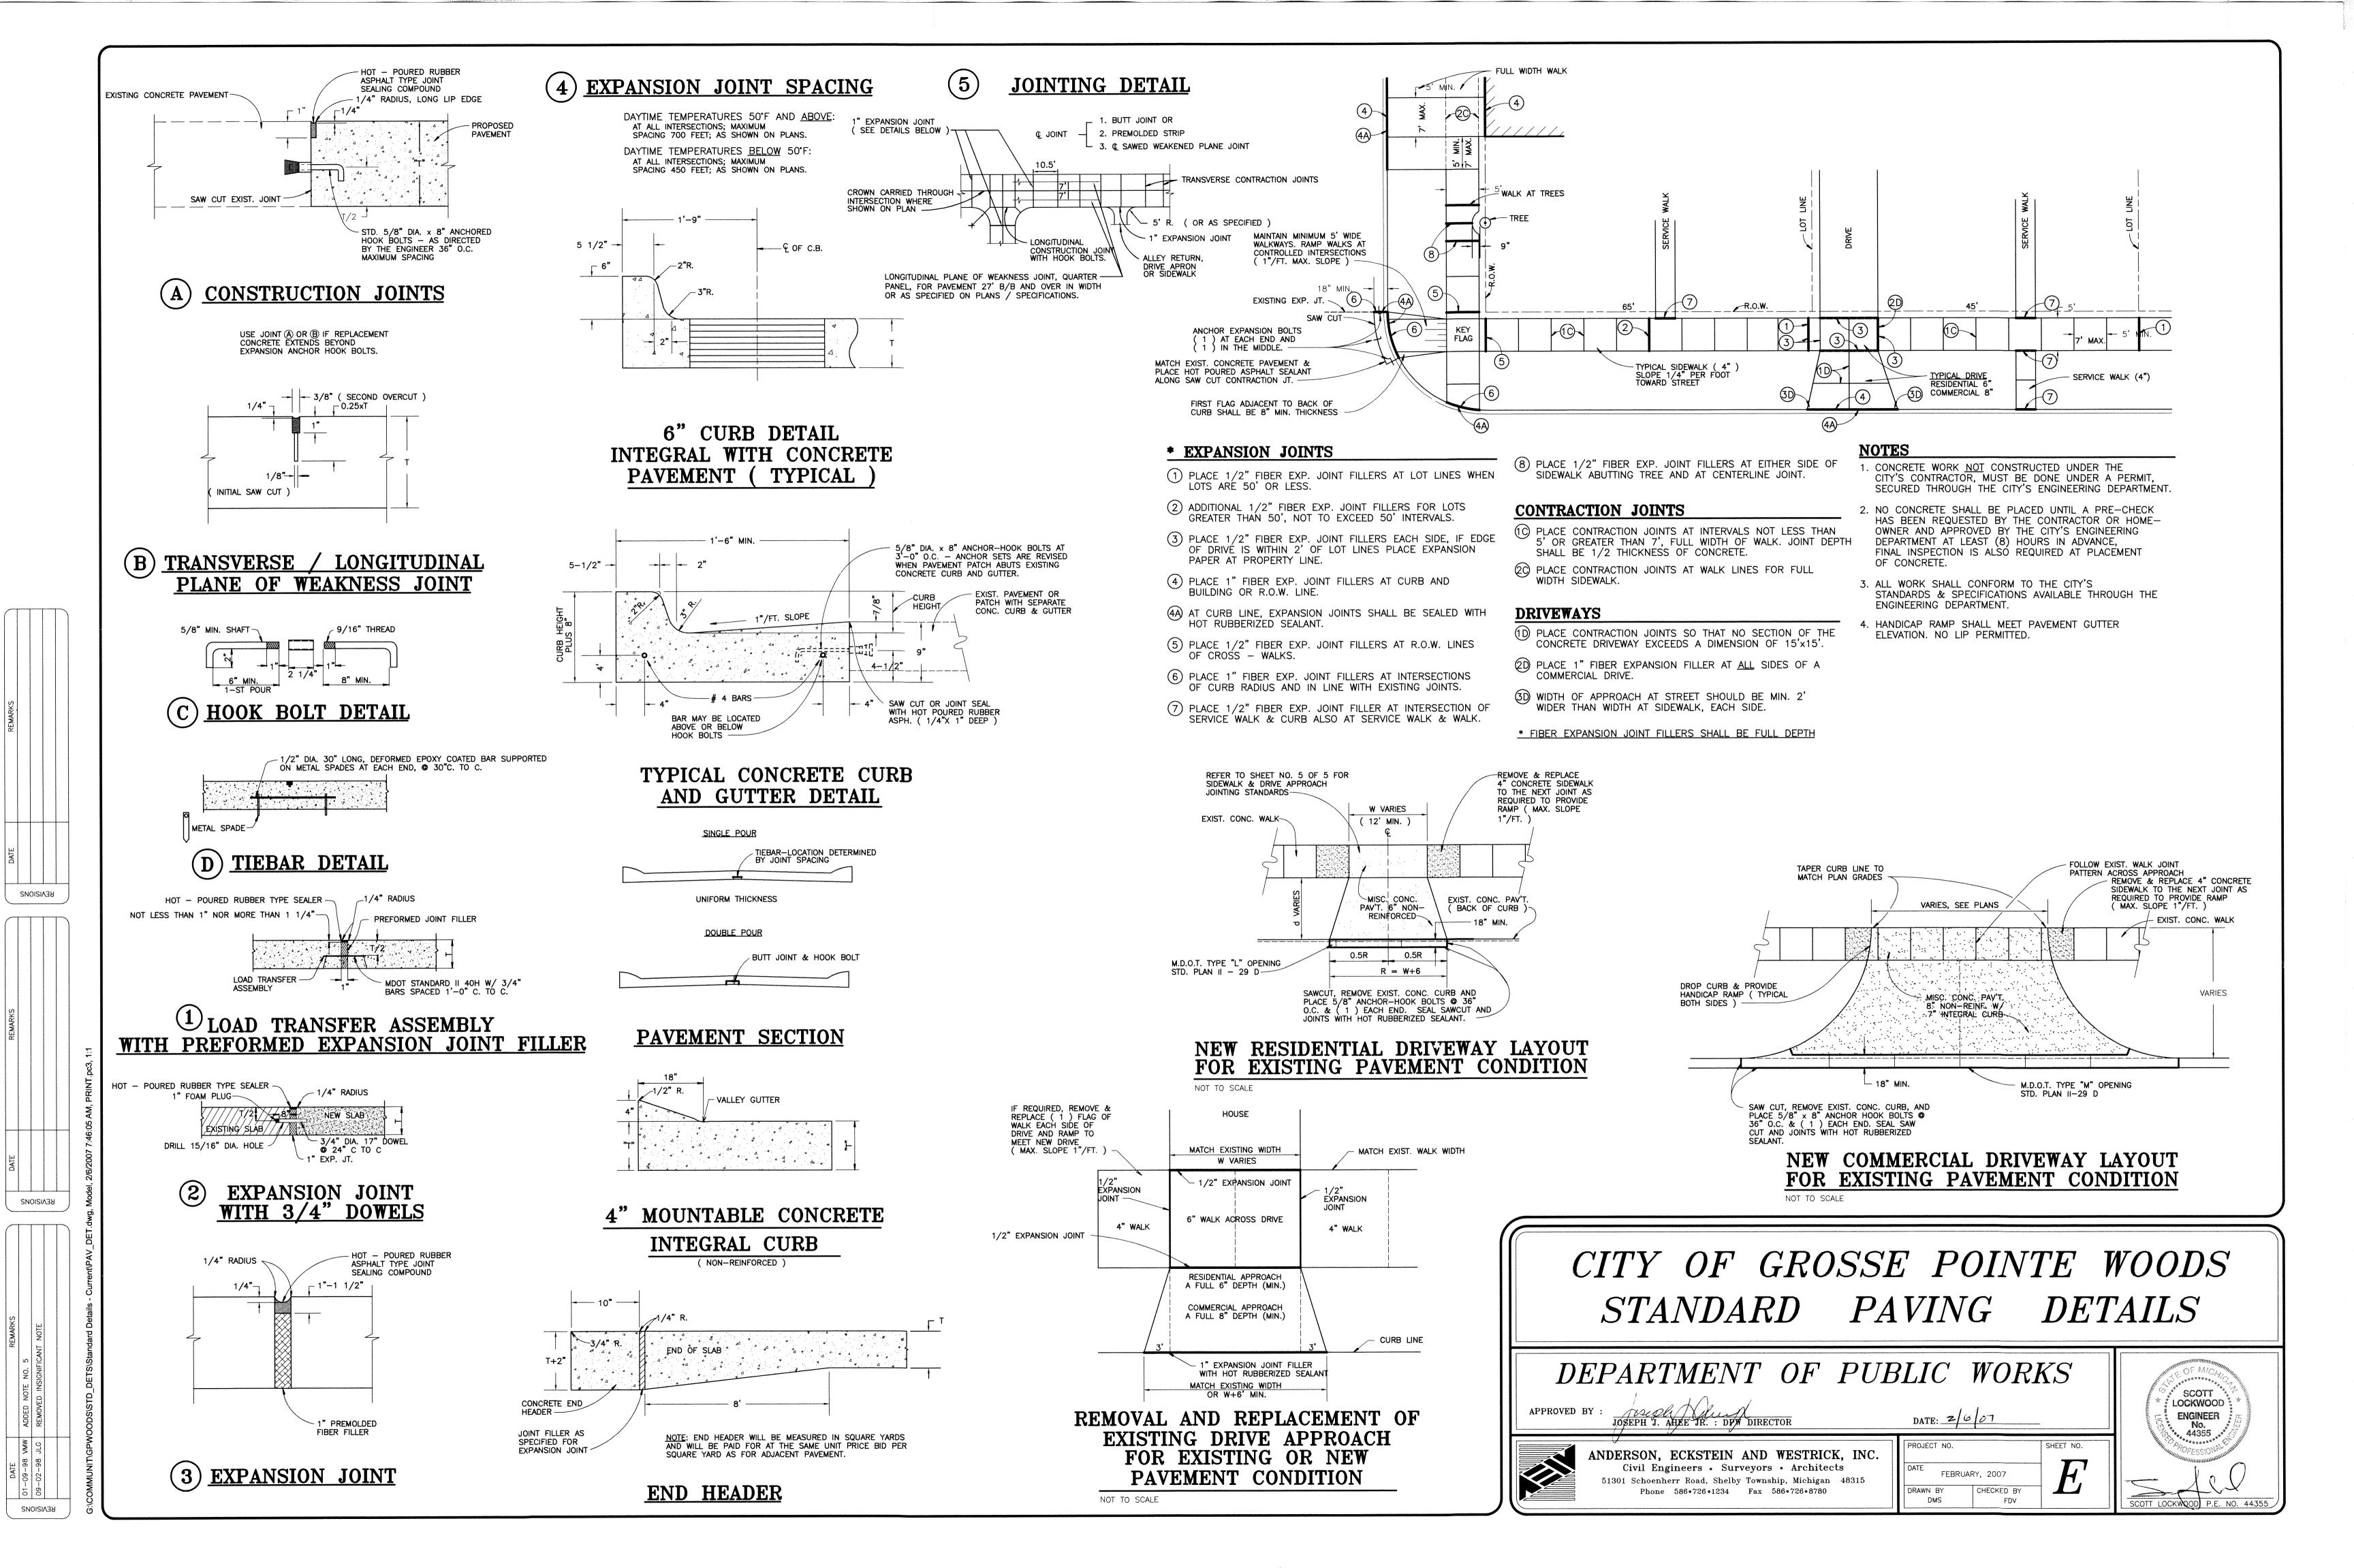




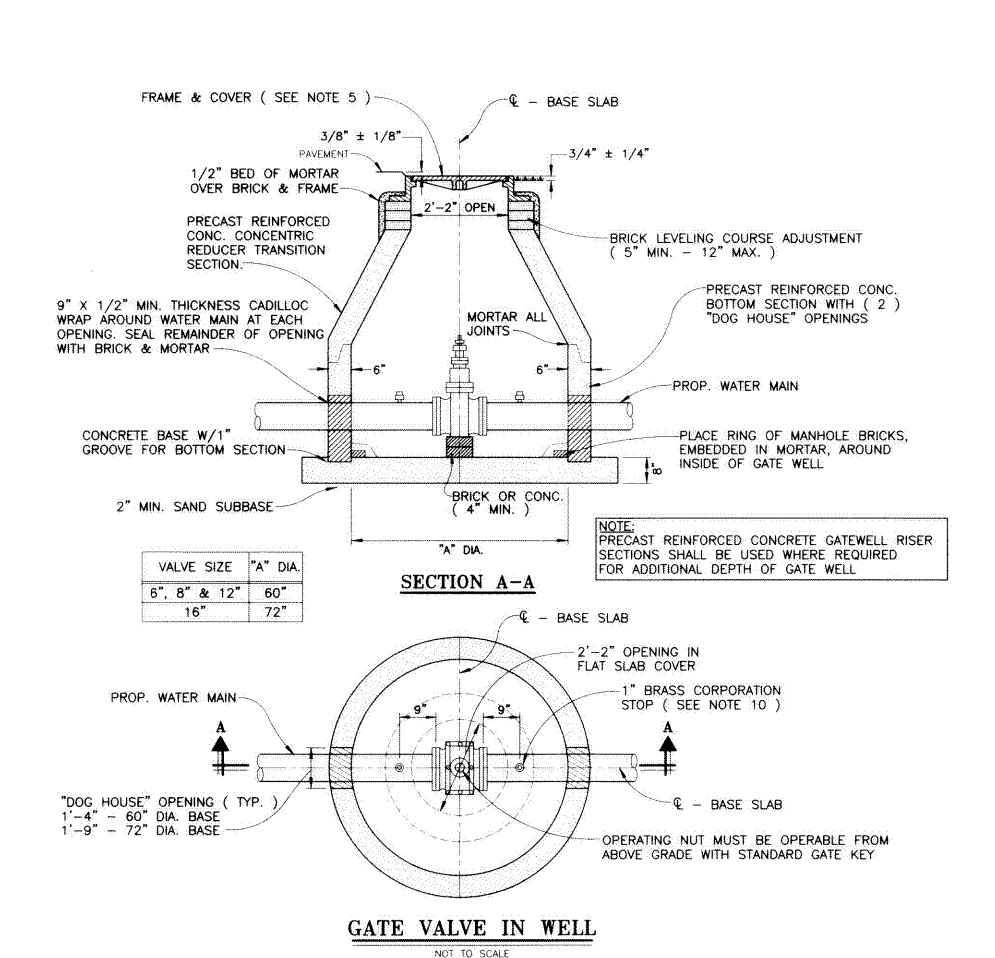
ANDERSON, ECKSTEIN AND WESTRICK, INC. Civil Engineers • Surveyors • Architects 51301 Schoenherr Road, Shelby Township, Michigan 48315 Phone 586 • 726 • 1234 Fax 586 • 726 • 8780

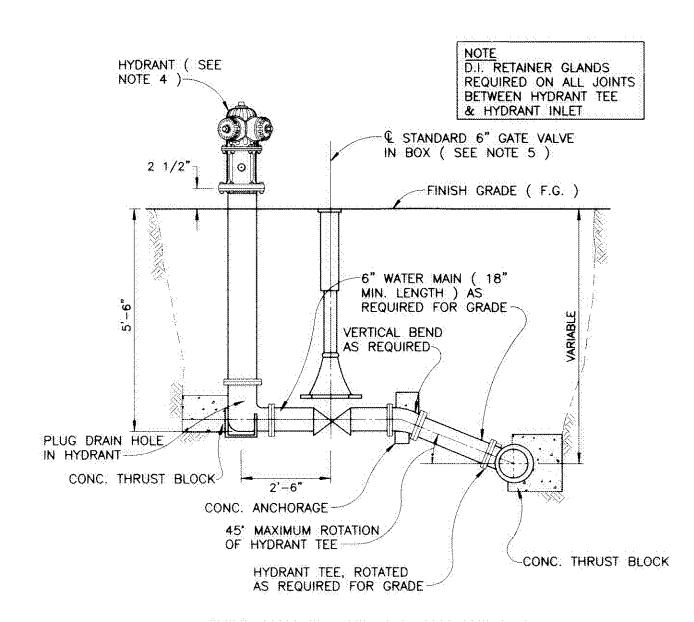
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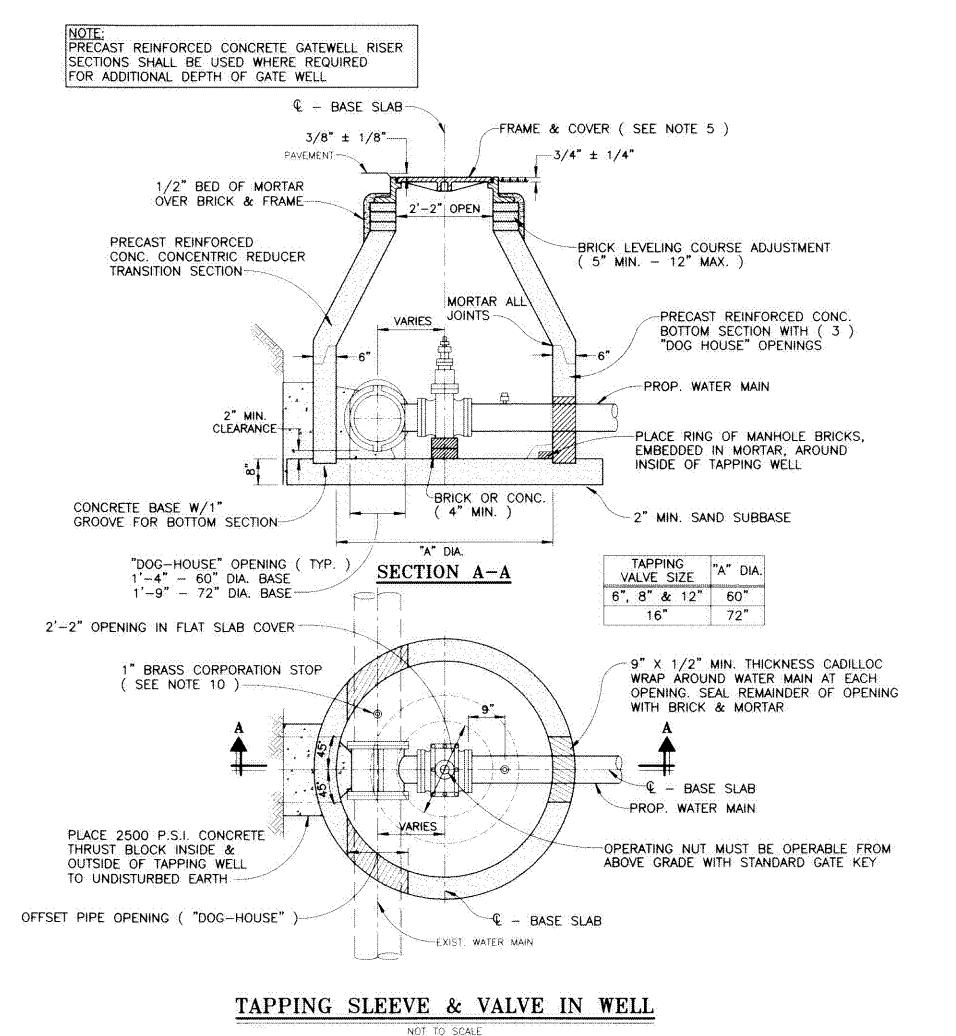


# "L" HYDRANT CONNECTION NOT TO SCALE





# "T" HYDRANT CONNECTION NOT TO SCALE



#### GENERAL NOTES

#### 1. STANDARDS AND SPECIFICATIONS

- A. ALL WATER MAIN AND WATER SYSTEM CONSTRUCTION SHALL CONFORM TO THE CURRENT STANDARDS AND SPECIFICATIONS OF THE CITY OF GROSSE POINTE WOODS DEPARTMENT OF PUBLIC WORKS AND THE DETROIT WATER AND SEWERAGE DEPARTMENT ( DWSD ). DETAILED WRITTEN SPECIFICATIONS ARE AVAILABLE UPON REQUEST.
- B. ANY MATERIALS OTHER THAN THOSE LISTED ON THE STANDARD DETAIL SHEETS MUST BE APPROVED IN WRITING BY THE CITY OF GROSSE POINTE WOODS DEPARTMENT OF PUBLIC WORKS. CONTRACTOR MUST SUBMIT THREE (3) COPIES OF SHOP DRAWINGS AND SPECIFICATIONS FOR PROPOSED ALTERNATE MATERIAL TO THE CITY OF GROSSE POINTE WOODS DEPARTMENT OF PUBLIC WORKS FOR REVIEW AS AN APPROVED EQUAL. DETERMINATION OF ACCEPTANCE BY THE CITY OF GROSSE POINTE WOODS DEPARTMENT OF PUBLIC WORKS SHALL BE CONSIDERED FINAL. THE CONTRACTOR SHALL BE RESPONSIBLE FOR ALL COSTS ASSOCIATED WITH REVIEW OF THE PROPOSED ALTERNATE MATERIAL AS AN APPROVED EQUAL.

#### 2. PRECONSTRUCTION REQUIREMENTS

- A. PRIOR TO CONSTRUCTION, THE CONTRACTOR SHALL ATTEND A PRECONSTRUCTION MEETING AT A TIME AND PLACE AS ARRANGED BY THE CITY OF GROSSE POINTE WOODS DEPARTMENT OF PUBLIC WORKS. THE CITY OF GROSSE POINTE WOODS DEPARTMENT OF PUBLIC WORKS SHALL NOTIFY AFFECTED UTILITY COMPANIES AND GOVERNMENTAL AGENCIES A MINIMUM OF THREE ( 3 ) WORKING DAYS PRIOR TO THE PRECONSTRUCTION MEETING. THE OWNER'S ENGINEER SHALL SUBMIT APPROVED PLANS TO ALL UTILITY COMPANIES AND GOVERNMENTAL AGENCIES A MINIMUM OF TEN ( 10 ) DAYS PRIOR TO PRECONSTRUCTION MEETING. CONSTRUCTION SHALL START WITHIN TWO ( 2 ) WEEKS OF MEETING UNLESS WAIVED BY THE CITY OF GROSSE POINTE WOODS DEPARTMENT OF PUBLIC WORKS.
- B. THE CONTRACTOR SHALL NOTIFY MISS DIG AT ( 800 ) 482-7171, THE CITY OF GROSSE POINTE WOODS DEPARTMENT OF PUBLIC WORKS AT ( 313 ) 343-2460, THE DETROIT WATER AND SEWERAGE DEPARTMENT ( INSPECTION DIVISION ) AT ( 313 ) 833-8649 AND ANDERSON, ECKSTEIN AND WESTRICK, INC. AT ( 586 ) 726-1234 THREE ( 3 ) WORKING DAYS PRIOR TO CONSTRUCTION. THE CONTRACTOR SHALL ALSO NOTIFY REPRESENTATIVES OF ANY OTHER FACILITIES, LOCATED IN THE VICINITY OF THE WORK, WHICH ARE NOT PARTICIPANTS OF THE MISS DIG SYSTEM.

#### 3. PIPE MATERIAL

- A. DUCTILE IRON PIPE WITH EXTERIOR ASPHALTIC MATERIAL COATING SHALL MEET THE REQUIREMENTS OF ANSI/AWWA C151/A21.51 CURRENT SPECIFICATIONS FOR DUCTILE—IRON PIPE, CENTRIFUGALLY CAST, FOR WATER. DUCTILE IRON PIPE SHALL BE SPECIAL THICKNESS CLASS 54 FOR PUSH—ON—JOINT DUCTILE—IRON PIPE. DUCTILE IRON PIPE SHALL BE DOUBLE CEMENT LINED WITH ASPHALTIC MATERIAL SEAL COATING MEETING THE REQUIREMENTS OF ANSI/AWWA C104/A21.4 CURRENT SPECIFICATIONS FOR CEMENT—MORTAR LINING FOR DUCTILE—IRON PIPE AND FITTINGS FOR WATER. PUSH—ON JOINTS SHALL MEET THE REQUIREMENTS OF ANSI/AWWA C111/A21.11 CURRENT SPECIFICATIONS FOR RUBBER—GASKET JOINTS FOR DUCTILE—IRON PRESSURE PIPE AND FITTINGS. PUSH ON JOINTS SHALL BE TYTON OR SUPER BELLTITE WITH SERRATED BRASS WEDGES. 6" THROUGH 12" PIPE REQUIRES TWO (2) WEDGES PER JOINT, 16" AND LARGER REQUIRES FOUR (4) WEDGES PER JOINT.
- B. HIGH-DENSITY POLYETHYLENE ( HDPE ) PIPE SHALL MEET THE REQUIREMENTS OF ANSI/AWWA C906 CURRENT SPECIFICATIONS FOR POLYETHYLENE PIPE AND FITTINGS, 4 INCH THROUGH 63 INCH, FOR WATER DISTRIBUTION AND TRANSMISSION, AND NSF 61. HDPE PIPE SHALL BE DIPS, DR 11 ( MINIMUM ), BLUE STRIPE AND MEET THE REQUIREMENTS OF STANDARD PE CODE DESIGNATION PE 3408. HDPE PIPE SHALL BE JOINED BY AN APPROVED BUTT FUSION OR ELECTROFUSION TECHNIQUE ACCORDING TO THE MANUFACTURERS SPECIFICATIONS. THE CONTRACTOR SHALL INSTALL TWO ( 2 ) NUMBER 6 TRACER WIRES HAVING "UF" OR "USE" COVER INSULATION AT THE SAME TIME NEW WATER MAIN IS INSTALLED.
- NOTE: HDPE WATER MAIN SHALL ONLY BE USED WITH WRITTEN AUTHORIZATION OF THE CITY OF GROSSE POINTE WOODS DEPARTMENT OF PUBLIC WORKS. IN NO CASE SHALL THE INSIDE DIAMETER OF THE EQUIVALENT HDPE PIPE BE LESS THAN THE INSIDE DIAMETER OF THE STANDARD DUCTILE IRON PIPE.

#### 4. <u>HYDRANTS</u>

- A. HYDRANTS SHALL MEET THE REQUIREMENTS OF ANSI/AWWA C502 CURRENT SPECIFICATIONS FOR DRY-BARREL FIRE HYDRANTS. HYDRANTS SHALL BE EAST JORDAN IRON WORKS 5BR-250 WATERMASTER WITH PENTAGON OPERATING NUT MEASURING 1-1/8" POINT TO FLAT AND BREAKAWAY FLANGE. THE CONTRACTOR SHALL PLUG ANY HYDRANT DRAIN HOLES.
- B. HYDRANTS SHALL OPEN COUNTER CLOCKWISE. HYDRANTS SHALL BE SUPPLIED WITH TWO ( 2 ) THREE AND THREE—QUARTER INCH ( 3-3/4" ) PUMPER NOZZLES HAVING DETROIT STANDARD THREAD.
- C. HYDRANTS SHALL HAVE A MINIMUM BURY OF FIVE AND ONE—HALF FEET (5-1/2') FROM FINISH GRADE TO BOTTOM INLET INVERT WITH A MINIMUM GROUND CLEARANCE FROM CENTER OF PUMPER NOZZLE TO FINISH GRADE OF TWENTY—ONE INCHES (21") AND FROM CENTER OF BASE FLANGE TO FINISH GRADE OF AT LEAST TWO AND ONE—HALF INCHES (2-1/2").
- D. PRIOR TO FINAL ACCEPTANCE BY THE MUNICIPALITY, ALL HYDRANTS MUST BE DEWATERED AND PAINTED. PAINT SHALL BE MARINE ENAMEL WITH TWO ( 2 ) APPLICATIONS. HYDRANTS SHALL BE YELLOW IN COLOR.

#### 4. HYDRANTS ( CONTINUED )

E. HYDRANTS SHALL BE OF THE "L" OR "T" TYPE CONNECTION AS SPECIFIED ON THE PLANS OR DIRECTED BY THE CITY OF GROSSE POINTE WOODS DEPARTMENT OF PUBLIC WORKS. HYDRANT PUMPER NOZZLES SHALL FACE THE ROAD CENTERLINE IN PUBLIC RIGHT—OF—WAYS OR FACE THE DIRECTION OF FIRE EQUIPMENT ACCESS ON PRIVATE DEVELOPMENTS. HYDRANTS SHALL BE SET TO THE PROPOSED PLAN GRADE ELEVATION UNLESS OTHERWISE AUTHORIZED BY THE CITY OF GROSSE POINTE WOODS DEPARTMENT OF PUBLIC WORKS. ALL VERTICAL EXTENSIONS REQUIRED TO OBTAIN THE DESIRED GRADE SHALL BE INCLUDED IN THE COST OF THE

#### 5. GATE VALVES

- A. ALL VALVES LESS THAN SIXTEEN INCH ( 16" ) IN DIAMETER SHALL MEET THE REQUIREMENTS OF ANSI/AWWA C515 CURRENT SPECIFICATIONS FOR REDUCED—WALL, RESILIENT—SEATED GATE VALVES FOR WATER SUPPLY SERVICE. THE VALVE SHALL BE CAST WITH A DUCTILE IRON BODY AND BRONZE MOUNTED WITH A BRONZE NON—RISING STEM, DOUBLE "O"—RING REPLACEABLE SEALS AND MECHANICAL JOINTS. IT SHALL BE FURNISHED WITH A TWO INCH ( 2" ) SQUARE OPERATING NUT AND SHALL TURN CLOCKWISE TO OPEN. GATE VALVES SHALL BE EAST JORDAN IRON WORKS FLOWMASTER RESILIENT SEATED GATE VALVES.
- B. ALL VALVES SIXTEEN INCH ( 16" ) IN DIAMETER, OR LARGER, SHALL BE BUTTERFLY VALVES THAT MEET THE REQUIREMENTS OF ANSI/AWWA C504 CURRENT SPECIFICATIONS FOR RUBBER—SEATED BUTTERFLY VALVES, CLASS 150B. THE VALVE SHALL BE CAST WITH AN IRON BODY AND A CORROSION RESISTANT STAINLESS STEEL SHAFT AND MECHANICAL JOINTS. IT SHALL BE FURNISHED WITH A MANUAL ACTUATOR WITH A TWO INCH ( 2" ) SQUARE OPERATING NUT AND SHALL TURN CLOCKWISE TO OPEN. BUTTERFLY VALVES SHALL BE MUELLER LINESEAL III ( CLASS 150B ) BUTTERFLY VALVES WITH MANUAL ACTUATOR.
- C. TAPPING VALVES SHALL CONFORM TO THE REQUIREMENTS OF GATE VALVES AS SPECIFIED IN THESE STANDARDS. THE VALVE SHALL BE CONSTRUCTED TO ALLOW A TAPPING MACHINE TO TAP DIRECTLY THROUGH THE OPEN VALVE. THE VALVE SHALL BE SUPPLIED WITH A FLANGED JOINT FOR CONNECTION TO THE TAPPING SLEEVE AND A MECHANICAL JOINT FOR CONNECTION TO THE BRANCH WATER MAIN. THE TAPPING SLEEVES SHALL BE STAINLESS STEEL, SPLIT SLEEVES WITH A DUCTILE IRON FLANGED
- D. GATE VALVES AND TAPPING VALVES SHALL BE HOUSED WITHIN A PRECAST CONCRETE GATEWELL. PRECAST BOTTOM SECTIONS, RISER SECTIONS AND CONCENTRIC TRANSITION SECTIONS SHALL CONFORM TO ASTM SPECIFICATION C478. HYDRANT VALVES SHALL BE HOUSED IN A CAST IRON VALVE BOX. VALVE BOX SHALL BE A THREE (3) PIECE SCREW TYPE BOX (5-1/4" SHAFT) WITH AN ENLARGED BASE.
- E. GATEWELL FRAMES AND COVERS SHALL BE EAST JORDAN IRON WORKS 1040 WITH TYPE A COVER. COVER SHALL READ "GROSSE POINTE WOODS WATER SUPPLY" IN TWO INCH ( 2" ) RECESSED FLUSH LETTERS AND THE CITY LOGO SHALL BE CENTERED.
- F. ALL END-OF-THE-LINE GATEWELLS SHALL HAVE A CAPPED STUB EXTENDING ONE FULL LENGTH OF PIPE BEYOND THE GATEWELL. THE VALVE, PIPE AND CAP SHALL BE INSTALLED WITH RETAINER GLANDS AND A CONCRETE THRUST BLOCK AT THE CAP.
- G. STEPS SHALL BE EAST JORDAN IRON WORKS #8503 OR M.A. INDUSTRIES P.S.I. POLYPROPYLENE WITH FOOT RECESS AND INSTALLED BY THE GATEWELL MANUFACTURER AT SIXTEEN INCHES ( 16" ) CENTER TO CENTER SPACING. BOTTOM STEP SHALL BE TWENTY—FOUR INCHES ( 24" ) MAXIMUM ABOVE FLOOR. TOP STEP SHALL BE EIGHTEEN INCHES ( 18" ) MAXIMUM BELOW RIM. ALL STEPS SHALL BE SUITABLY SCORED TO PROVIDE A NON—SLIP SURFACE.

#### 6. FITTINGS

- A. ALL FITTINGS SHALL BE DUCTILE IRON AND MEET THE REQUIREMENTS OF ANSI/AWWA C153/A21.53 CURRENT SPECIFICATIONS FOR DUCTILE—IRON COMPACT FITTINGS FOR WATER SERVICE. FITTINGS SHALL BE CEMENT LINED WITH ASPHALTIC MATERIAL SEAL COATING MEETING THE REQUIREMENTS OF ANSI/AWWA C104/A21.4 CURRENT SPECIFICATIONS FOR CEMENT—MORTAR LINING FOR DUCTILE—IRON PIPE AND FITTINGS FOR WATER OR EPOXY COATED MEETING THE REQUIREMENTS OF ANSI/AWWA C116/A21.16 FOR PROTECTIVE FUSION—BONDED EPOXY COATINGS FOR THE INTERIOR AND EXTERIOR SURFACES OF DUCTILE—IRON AND GRAY—IRON FITTINGS FOR WATER SUPPLY SERVICE. FITTINGS SHALL BE 350 PSI PRESSURE RATED WITH MECHANICAL JOINTS AND RETAINING GLANDS. SPLIT RETAINERS ARE NOT ALLOWED.
- B. CONCRETE THRUST BLOCKS ARE REQUIRED AT ALL BENDS, TEES, CAPS OR PLUGS. CONCRETE SHALL HAVE A COMPRESSIVE STRENGTH OF 2500 PSI ( MINIMUM ) AT 28 DAYS.
- C. MECHANICAL JOINTS AND BOLTS FOR ALL FITTINGS SHALL MEET THE REQUIREMENTS OF ANSI/AWWA C111/A21.11 CURRENT SPECIFICATIONS FOR RUBBER-GASKET JOINTS FOR DUCTILE-IRON PRESSURE PIPE AND FITTINGS. ALL BOLTS SHALL BE COR-TEN BLUE WITH T-HEADS AND HEX NITS.
- D. ALL MECHANICAL JOINTS, FITTINGS, GLANDS AND BOLTS SHALL BE COATED WITH BITUMASTIC.

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# CITY OF GROSSE POINTE WOODS STANDARD WATER MAIN DETAILS ( 1 OF 2

# DEPARTMENT OF PUBLIC WORKS

APPROVED BY : JOSEPH J. AHEE

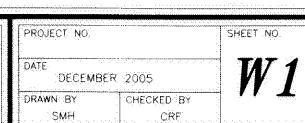
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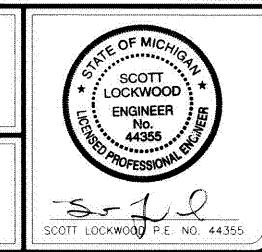
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DATE : 12-13-05

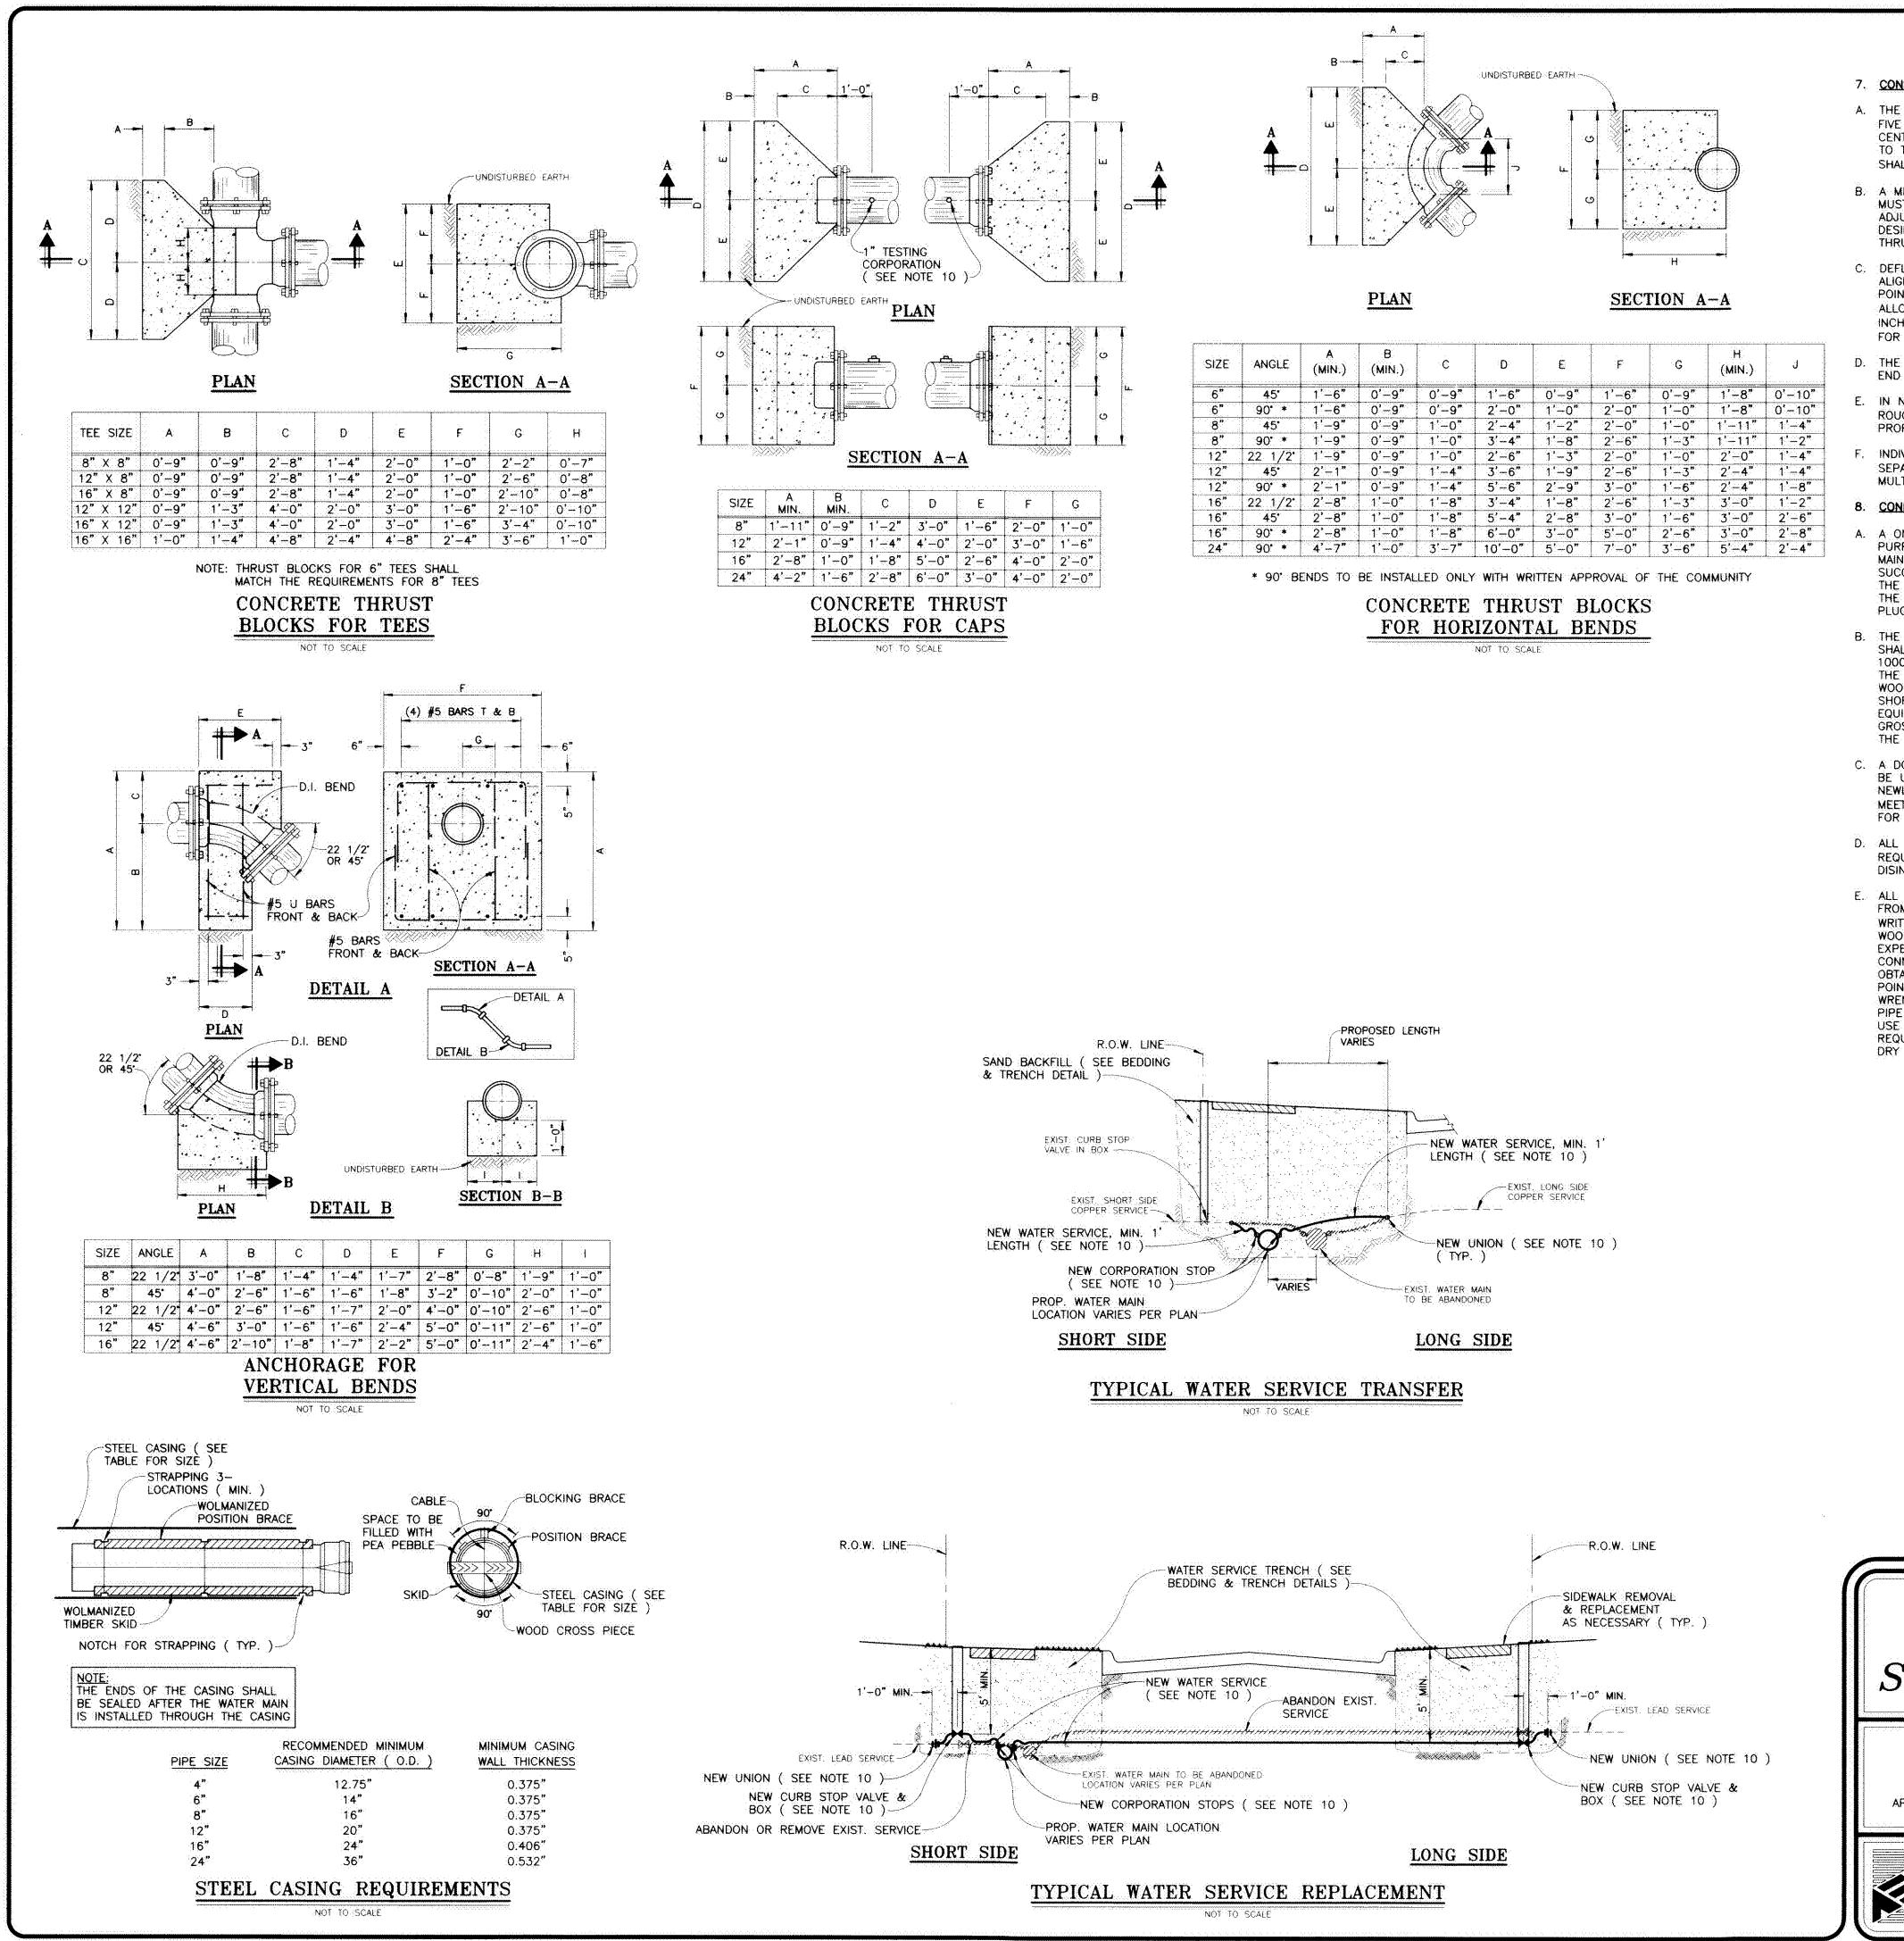




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#### GENERAL NOTES

#### 7. CONSTRUCTION

- A. THE WATER MAIN SHALL BE CONSTRUCTED WITH A MINIMUM COVER OF FIVE AND ONE—HALF FEET ( 5—½'), MEASURED FROM THE PAVEMENT CENTERLINE ELEVATION OR THE EXISTING GROUND, WHICHEVER IS LOWER, TO THE TOP OF PIPE. GENERALLY, THE MAXIMUM DEPTH OF COVER SHALL NOT EXCEED SEVEN FEET ( 7') FROM FINAL FINISH GRADE.
- B. A MINIMUM VERTICAL CLEARANCE OF ONE AND ONE—HALF FEET ( 1—½') MUST BE MAINTAINED BETWEEN THE WATER MAIN AND ANY UTILITIES. ADJUSTMENTS TO THE WATER MAIN DEPTH IN ORDER TO OBTAIN THE DESIRED CLEARANCES MUST BE ACCOMPLISHED WITH VERTICAL BENDS, THRUST BLOCKS AND ANCHORAGES.
- C. DEFLECTION OF PIPE JOINTS TO OBTAIN THE DESIRED CLEARANCES OR ALIGNMENT SHALL ONLY BE ACCOMPLISHED WITH THE CITY OF GROSSE POINTE WOODS DEPARTMENT OF PUBLIC WORKS APPROVAL. THE MAXIMUM ALLOWABLE DEFLECTION ( FOR 1 FULL LENGTH OF PIPE ) IS FOURTEEN INCHES ( 14" ) FOR 4" THROUGH 12" PIPE AND EIGHT INCHES ( 8" ) FOR 16" AND 24" PIPE.
- D. THE CONTRACTOR SHALL SUPPLY AND PLACE A PLUG OR CAP OVER THE END OF THE PIPE AT THE END OF EACH WORK DAY.
- IN NEW DEVELOPMENTS, WATER MAIN SHALL NOT BE INSTALLED UNTIL ROUGH GRADING IS COMPLETED TO WITHIN TWELVE INCHES ( 12" ) OF
- F. INDIVIDUAL WATER SERVICES AND METERS SHALL BE REQUIRED FOR EACH SEPARATE UNIT WITHIN PROPOSED COMMERCIAL, INDUSTRIAL AND/OR MULTIPLE FAMILY RESIDENTIAL BUILDINGS.

#### 8. CONNECTION TO EXISTING SYSTEM

- A. A ONE INCH ( 1" ) CORPORATION SHALL BE INSTALLED, FOR TESTING PURPOSES, IN ALL STUBS AND POINTS OF CONNECTION TO EXISTING MAINS. SEE NOTE 10 FOR CORPORATION STOP SPECIFICATION. UPON SUCCESSFUL COMPLETION OF THE TESTS AND WITH THE APPROVAL OF THE CITY OF GROSSE POINTE WOODS DEPARTMENT OF PUBLIC WORKS, THE CONTRACTOR SHALL REMOVE THE TESTING CORPORATION AND INSTALL PLUGS.
- B. THE MAXIMUM PERMISSIBLE LEAKAGE, DURING HYDROSTATIC TESTING, SHALL NOT EXCEED 0.18 GALLONS PER INCH DIAMETER OF MAIN PER 1000 FEET OF PIPE IN 2 HOURS AT A TEST PRESSURE OF 150 PSI. THE MAXIMUM TEST LENGTH IS 3000 FEET. THE CITY OF GROSSE POINTE WOODS DEPARTMENT OF PUBLIC WORKS RESERVES THE RIGHT TO TEST SHORTER LENGTHS. THE CONTRACTOR IS TO SUPPLY ALL TESTING EQUIPMENT AND PERFORM THE TEST. THE DWSD AND THE CITY OF GROSSE POINTE WOODS DEPARTMENT OF PUBLIC WORKS WILL WITNESS THE TEST.
- C. A DOUBLE CHECK VALVE ASSEMBLY, FOR BACKFLOW PREVENTION, SHALL BE UTILIZED ON ALL TEMPORARY LINES USED TO FILL AND FLUSH THE NEWLY INSTALLED MAIN. THE DOUBLE CHECK VALVE ASSEMBLY SHALL MEET THE REQUIREMENTS OF ANSI/AWWA C510 CURRENT SPECIFICATIONS FOR DOUBLE CHECK VALVE BACKFLOW PREVENTION ASSEMBLY.
- D. ALL WATER MAINS SHALL BE DISINFECTED ACCORDING TO THE REQUIREMENTS OF ANSI/AWWA C651 CURRENT SPECIFICATIONS FOR DISINFECTING WATER MAINS.
- E. ALL WATER USED FOR FLUSHING NEW WATER MAINS MAY BE OBTAINED FROM THE LOCAL WATER SUPPLY. THE CONTRACTOR SHALL SECURE WRITTEN PERMISSION AND/OR PERMIT FROM THE CITY OF GROSSE POINTE WOODS DEPARTMENT OF PUBLIC WORKS FOR WATER USED AND BEAR ALL EXPENSES OF SUCH PERMIT AND FOR THE WATER USED. WHERE CONNECTIONS ARE MADE TO HYDRANTS, THE CONTRACTOR SHALL ALSO OBTAIN PERMISSION FOR SUCH CONNECTIONS FROM THE CITY OF GROSSE POINTE WOODS DEPARTMENT OF PUBLIC WORKS. STANDARD HYDRANT WRENCHES SHALL BE USED FOR OPENING AND CLOSING THE HYDRANT. PIPE WRENCHES SHALL NOT BE USED TO OPEN OR CLOSE HYDRANTS. USE OF ANY HYDRANT AFTER OCTOBER 15 SHALL INCLUDE THE REQUIREMENT THAT EACH HYDRANT SO USED BE COMPLETELY PUMPED DRY AFTER EACH USE.

#### 8. CONNECTION TO EXISTING SYSTEM ( CONTINUED )

- F. CONNECTIONS TO THE EXISTING WATER SYSTEM SHALL NOT BE MADE UNTIL THE NEW MAIN HAS BEEN SUCCESSFULLY PRESSURE TESTED AND HAS PASSED BACTERIOLOGICAL TESTING IN ACCORDANCE WITH CITY OF GROSSE POINTE WOODS DEPARTMENT OF PUBLIC WORKS AND DWSD STANDARDS AND A COPY OF BOTH RESULTS ARE SUBMITTED TO THE CITY OF GROSSE POINTE WOODS DEPARTMENT OF PUBLIC WORKS. FINAL CONNECTIONS SHALL BE COORDINATED WITH THE CITY OF GROSSE POINTE WOODS DEPARTMENT OF PUBLIC WORKS.
- G. BEFORE ACCEPTANCE A FINAL REVIEW MUST BE MADE BY THE CITY OF GROSSE POINTE WOODS DEPARTMENT OF PUBLIC WORKS. FOR PRIVATE DEVELOPMENTS, A SET OF AS—BUILT SEPIA MYLARS, AN AUTOCAD DIGITAL FILE AND THREE ( 3 ) SETS OF BLUE LINE PRINTS SHALL BE SUBMITTED TO THE CITY OF GROSSE POINTE WOODS ENGINEER.

#### 9. MAINTENANCE AND GUARANTEE BOND

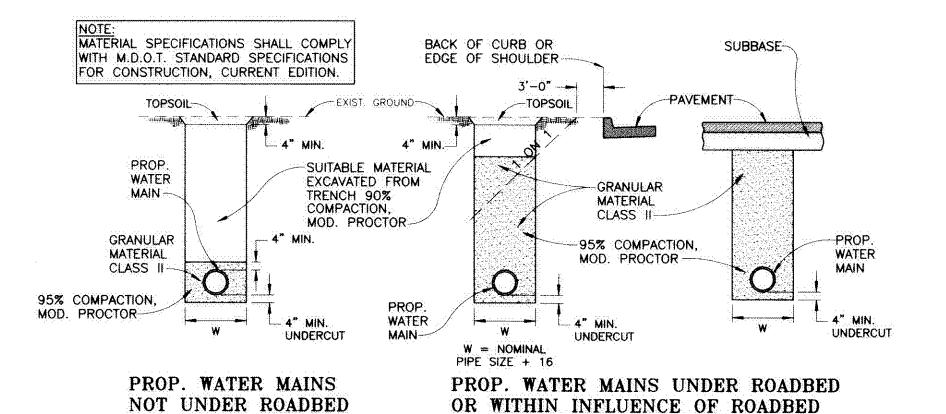
A. THE CONTRACTOR SHALL PROVIDE A TWO ( 2 ) YEAR MAINTENANCE AND GUARANTEE BOND TO THE CITY OF GROSSE POINTE WOODS FROM A SURETY, LICENSED IN THE STATE OF MICHIGAN, WITH A RATING OF B+ OR BETTER, DATED FROM THE TIME OF FINAL ACCEPTANCE BY THE CITY OF GROSSE POINTE WOODS DEPARTMENT OF PUBLIC WORKS, FOR 100% OF THE CONSTRUCTION COSTS.

#### 10. WATER SERVICES

- A. ALL WATER SERVICE TRANSFERS SHALL INCLUDE NEW COPPER TUBING, CORPORATION STOPS AND UNIONS AS REQUIRED. SEE TYPICAL WATER SERVICE TRANSFER DETAIL.
- B. ALL WATER SERVICE REPLACEMENTS SHALL INCLUDE NEW COPPER TUBING, CORPORATION STOPS, CURB STOP VALVES, SERVICE BOXES AND UNIONS AS REQUIRED. SERVICE REPLACEMENTS SHALL BE FROM THE WATER MAIN TO A CONNECTION POINT ONE FOOT (1') BEYOND THE EXISTING CURB STOP VALVE. SEE TYPICAL WATER SERVICE REPLACEMENT DETAIL.
- C. UNIONS FOR WATER SERVICE TRANSFERS SHALL BE MUELLER H-15400 STRAIGHT THREE PART UNION WITH COPPER FLARE NUT ( BOTH ENDS ). UNIONS FOR WATER SERVICE REPLACEMENT SHALL BE MUELLER H-15506 STRAIGHT UNION EXTRA STRONG ( XS ) WITH LEAD FLANGE COUPLING AND COPPER FLARE NUT.
- D. WATER SERVICES SHALL BE NEW TYPE "K" SEAMLESS COPPER TUBING. CONTRACTOR SHALL MATCH EXISTING WATER SERVICE SIZE UNLESS OTHERWISE SPECIFIED ON THE PLANS.

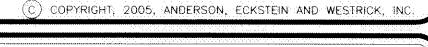
E. CORPORATION STOPS SHALL BE MUELLER H-15000 GROUND KEY

- CORPORATION VALVE WITH AWWA TAPER ( MUELLER "CC" ) THREAD AND COPPER FLARE STRAIGHT CONNECTION OUTLET. A BRONZE DOUBLE STRAP SADDLE IS REQUIRED FOR ONE AND ONE-HALF INCH ( 1-½" ) AND TWO INCH ( 2" ) WATER SERVICES. BRONZE DOUBLE STRAP SADDLES SHALL BE MUELLER BR 2 B SERIES WITH AWWA TAPER ( MUELLER "CC" ) THREAD.
- F. CURB STOP VALVES SHALL BE MUELLER H-15204 MARK IF ORISEAL CURB VALVE WITH COPPER FLARE NUT ( BOTH ENDS ) AND QUARTER TURN CHECK. CURB BOXES SHALL BE TYLER CAST IRON ADJUSTABLE SERVICE BOXES, 6500 SERIES, SCREW TYPE 95-E.
- G. CURB STOPS SHALL ONLY BE INSTALLED IN SIDEWALKS, DRIVES, OR PAVEMENT WITH THE WRITTEN AUTHORIZATION OF THE CITY OF GROSSE POINTE WOODS DEPARTMENT OF PUBLIC WORKS. ADDITIONAL COPPER TUBING AND FITTINGS SHALL BE USED AS REQUIRED TO INSTALL CURB STOPS IN GREEN BELT AREA.
- H. ALL ABANDONED SERVICES MUST BE CAPPED AT THE MAIN.

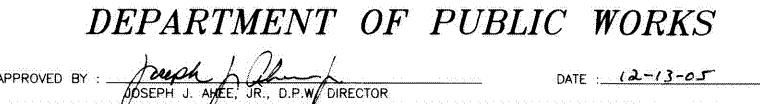


BEDDING & TRENCH DETAILS

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