


# City of Grosse Pointe Woods



## Wayne County, Michigan

## Allard Avenue Reconstruction

Harper Ave. to Chester Ave.

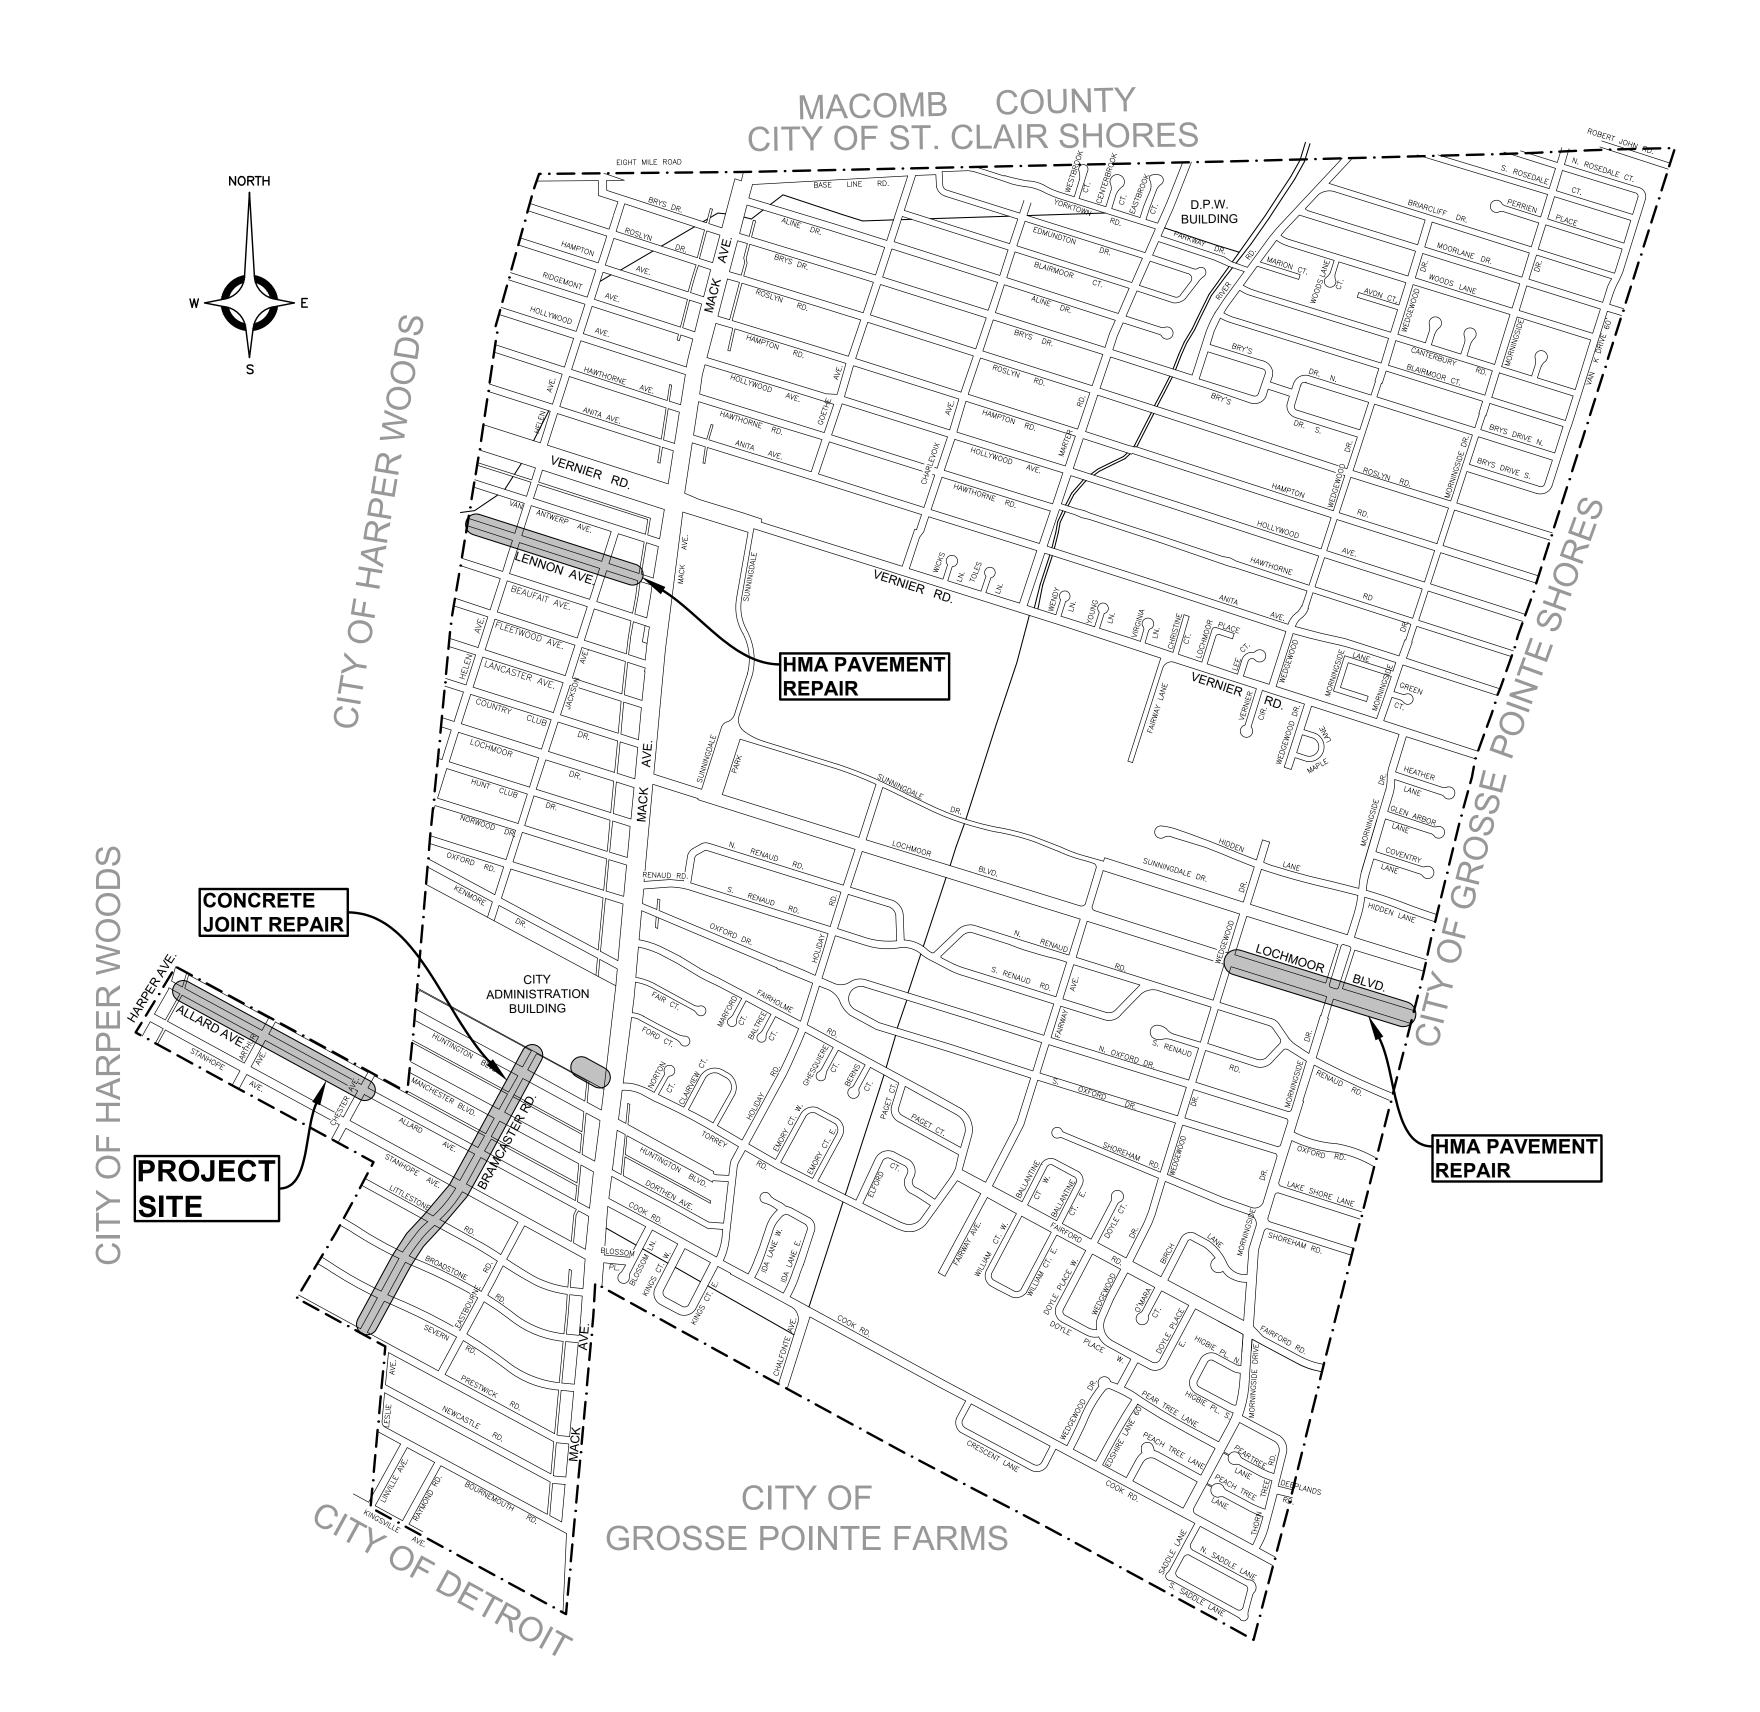

### **INDEX TO SHEETS**

TITLE SHEET	
NOTE SHEET	
MISCELLANEOUS PROJECT DETAILS	
ALIGNMENT SHEET	
TYPICAL CROSS SECTIONS	
REMOVAL, CONSTRUCTION PLANS & PROFILES	
INTERSECTION GEOMETRICS & SIDEWALK RAMP SCHEMATICS	
MAINTAINING TRAFFIC PLAN	17
SOIL EROSION PLAN	18
SOIL BORING LOGS	19-20
GROSSE POINTE WOODS STD. STORM DETAILS	E
GROSSE POINTE WOODS STD. PAVING DETAILS	E

LOCAL AUTHORITY APPROVAL GROSSE POINTE WOODS

FRANK SCHULTE, DIRECTOR OF PUBLIC SERVICES DATE

"I HEREBY CERTIFY THESE PLANS HAVE BEEN PREPARED UNDER MY DIRECT SUPERVISION IN ACCORDANCE WITH ACT 240, PUBLIC ACTS OF 1937 AS AMENDED- STATE OF MICHIGAN."

ROSS T. WILBERDING, P.E. No. 6201068836

DATE

## **GENERAL NOTES**

#### UTILITIES

#### MISS DIG/UNDERGROUND UTILITY NOTIFICATION

For the protection of underground utilities and in conformance with Public Act 174 of 2013, the Contractor shall contact MISS DIG System, Inc. by phone at 811 or 800-482-7171 or via the web at either elocate.missdig.org for single address or rte.missdig.org, a minimum of 3 work days prior to excavating, excluding weekends and holidays.

#### **ROW / REAL ESTATE**

#### LAWN SPRINKLER SYSTEMS AND LANDSCAPING

Owners of existing lawn sprinkler systems and/or landscaping shall be notified in advance of any work to be done that will affect those systems and/or landscaping. If the property owner fails to relocate the lawn sprinkler system prior to the Contractor beginning work, the Contractor shall carefully salvage the landscaping items and stockpile them on the property owner's property for the property owner. If the Contractor cuts the system during the construction, the Contractor shall cap the system pipe and witness the location of the cap with a wooden stake.

#### **SURVEY**

#### **ADJUSTING MONUMENT BOXES**

All government corners on this project shall be preserved, whether shown or not. It may be necessary to place or adjust monument boxes, as required.

#### **DRAINAGE**

#### ILLICIT CONNECTIONS TO STORM WATER SYSTEM

Connections to existing storm conveyance systems not shown on the plans must be reconnected with minimal interruption in service. Size, type and location by station and offset of any suspect illicit discharge observed shall be reported to the Engineer prior to reconnecting. Contractor shall proceed as directed by the Engineer.

#### TEMPORARY BULKHEADS

Temporary bulkheads may be required for the part width construction of the sewers. All costs associated with constructing temporary bulkheads are included in the unit prices bid for the storm sewer items of work.

#### **EARTHWORK**

## **SOIL EROSION MEASURES**

Appropriate soil erosion and sedimentation control measures shall be in place prior to earth-disturbing activities. Place turf establishment items as soon as possible on potential erodable slopes as directed by the Engineer.

#### **BASES**

#### **AGGREGATE BASE**

Aggregate bases shall be 21AA in accordance with the MDOT 2012 Standard Specifications for Construction.

#### **PAVEMENT**

#### SOIL BORINGS AND/OR PAVEMENT CORES

The soil boring logs and/or pavement cores represent point information. No inference should be made that subsurface or pavement conditions are the same at other locations.

#### CONCRETE

The type of concrete to be used on this project is Type P1.

#### **LANDSCAPING**

All equipment to be used must be approved by the Engineer prior to beginning work.

Storage of equipment and materials will be restricted to areas designated by the Owner.

Branches of all trees to be saved shall not be removed, or damaged by construction equipment. If removal of lower branches is necessary, contact DPW for proper methods.

Contractor shall promptly restore any property damage at no expense to the

All excavated material will become the property of the Contractor. Any excavated material not used on the project shall be removed from the site and disposed of in accordance with Section 205.03.P. of the 2012 Standard Specification for Construction and any applicable state and/or local ordinances.

No cereal rye seeding shall be used on this project.

#### **SIGNS**

#### **GENERAL**

All signs shall be installed, removed and/or salvaged according to the current edition of "Michigan Manual on Uniform Traffic Control Devices" and the current edition of Michigan Department of Transportation (MDOT) "Standard Specifications for Construction."

All signs on the plans or in the log that do not have a recommendation are to be retained.

#### **EXISTING SIGN RELOCATION**

\* Denotes Special Detail

Any permanent signs requiring relocation due to Contractor operations shall be salvaged and reset by the Contractor at locations designated by the Engineer. Signs and posts damaged during the removal and storage operations shall be replaced with new signs and posts. The cost of this work shall be borne by the Contractor.

#### NOTES APPLYING TO STANDARD PLANS

Where the following items are called for on plans, they are to be constructed according to the standard plan series given below opposite each item unless otherwise indicated.

Title	Plan Series						
ROAD							
DRAINAGE STRUCTURES	R-1*						
SIDEWALK RAMP AND DETECTABLE WARNING DETAILS	R-28*						
DRIVEWAY OPENINGS & APPROACHES AND CONCRETE	R-29						
SIDEWALK	K-29						
CONCRETE CURB AND CONCRETE CURB & GUTTER	R-30						
GRANULAR BLANKET, UNDERDRAINS, OUTLET ENDINGS FOR	R-80						
UNDERDRAINS, AND SEWER BULKHEADS	K-00						
UTILITY TRENCHES	R-83						
SOIL EROSION & SEDIMENTATION CONTROL MEASURES	R-96						
	_						

## **PUBLIC UTILITIES**

The existing utilities listed below and locations of utilities as shown on the plans represent the best information available at the time these plans were prepared. This information does not relieve the contractor of the responsibility to satisfy himself as to their accuracy or of his responsibility to verify all existing utilities within the C.I.A. In case utilities have been constructed or removed since the topographic survey was prepared.

NAME OF OWNER

**DETROIT EDISON CO.** TOM KOCH ONE ENERGY PLAZA

2045 WEB DETROIT, MI 48226 (313)235-4432

D.T.E. COMMUNITY LIGHTING

DEBRA CAIN (313)618-6996

D.T.E. GAS COMPANY

LAURIE FORRESTER 17150 ALLEN ROAD

A.T.&T. ENGINEERING DEPARTMENT 100 S. MAIN ST., SUITE 314 MT. CLEMENS, MICHIGAN 48043

(586) 466-1024

**COMCAST CABLE** 

WARREN SETTY 6095 WALL STREET

STERLING HEIGHTS, MICHIGAN 48312 (586) 883-7253

WAYNE COUNTY DEPARTMENT

OF SERVICES PETE MILENKOVICH 29900 GODDARD ROAD **DETROIT, MICHIGAN 48241** (734) 955-2154

CITY OF GROSSE POINTE WOODS

DEPARTMENT OF PUBLIC WORKS JIM KOWALSKI 1200 PARKWAY GROSSE POINTE WOODS, MICHIGAN UTILITY

**POWER & ELECTRIC** 

STREET LIGHTS

**GAS** 

MELVINDALE, MICHIGAN 48122 (313)389-7261

> **TELEPHONE & OTHER** COMMUNICATION **SYSTEMS**

**CABLE TV** 

TRAFFIC SIGNALS

WATER / SEWER

PROJECT NAME:

**GROSSE POINTE WOODS** 

RTW AUGUST 2021 NO SCALE

SUBMITTALS/REVISIONS

**ALLARD AVENUE** 

**RECONSTRUCTION** 

HARPER TO CHESTER

**NOTE SHEET** 

ANDERSON, ECKSTEIN AND

WESTRICK, INC.

CIVIL ENGINEERS SURVEYORS ARCHITECTS

www.aewinc.com


**ENGINEERING STRONG COMMUNITIES** 

Phone 586 726 1234

51301 Schoenherr Road

Shelby Township

Michigan 48315

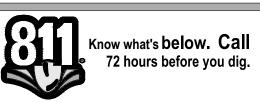


JTILITY INFORMATION. AS SHOWN. INDICATES APPROXIMATE LOCATIONS AND TYPES OF EXISTING FACILITIES ONLY. AS DISCLOSED BY RECORDS PROVIDED TO THIS FIRM FROM THE VARIOUS UTILITY COMPANIES. NO GUARANTEE IS GIVEN OR IMPLIED AS TO THE COMPLETENESS OR ACCURACY THEREOF.


PRIOR TO CONSTRUCTION, ALL LOCATIONS AND DEPTHS OF EXISTING OVERHEAD AND UNDERGROUND UTILITIES (IN CONFLICT WITH THE CONSTRUCTION OF THESE PROPOSED IMPROVEMENTS) SHALL BE VERIFIED IN THE FIELD. DURING THE CONSTRUCTION, THE CONTRACTOR SHALL PROTECT AND SUPPORT ALL UTILITIES THAT ARE ENCOUNTERED. (ALL COSTS FOR UTILITY LOCATION VERIFICATION, SUPPORT AND PROTECTION SHALL BE INCLUDED IN THE PROPOSED PAY ITEM CONFLICTING WITH

DURING CONSTRUCTION, THE CONTRACTOR SHALL USE XTREME CAUTION WHEN OPERATING NEAR ANY AND ALL OVERHEAD AND / OR BURIED UTILITIES.

> PROJECT NO. 0160-0433

M:\0160\0160-0433\DWG\CIVIL\02\_NOTE.DWG 02\_Note--12/10/2021 3:35:25 PM SHEET NO

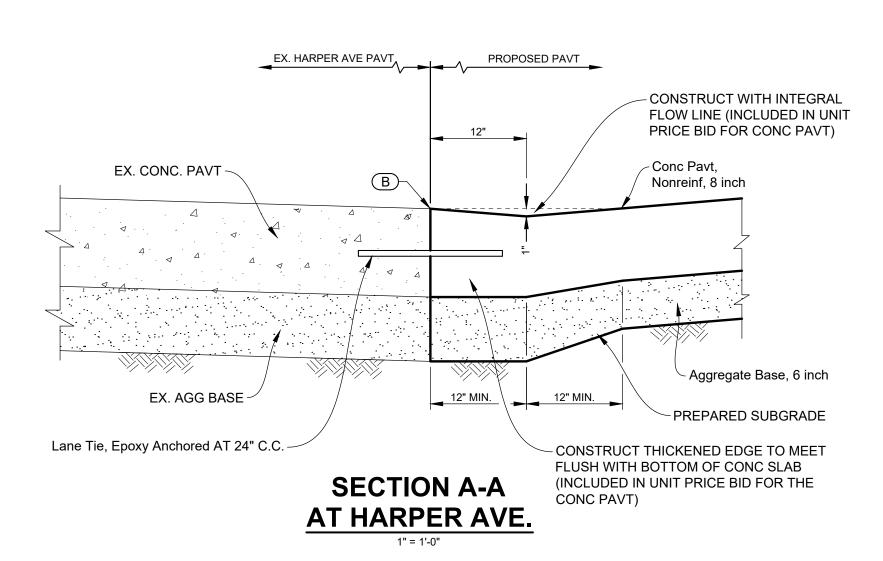


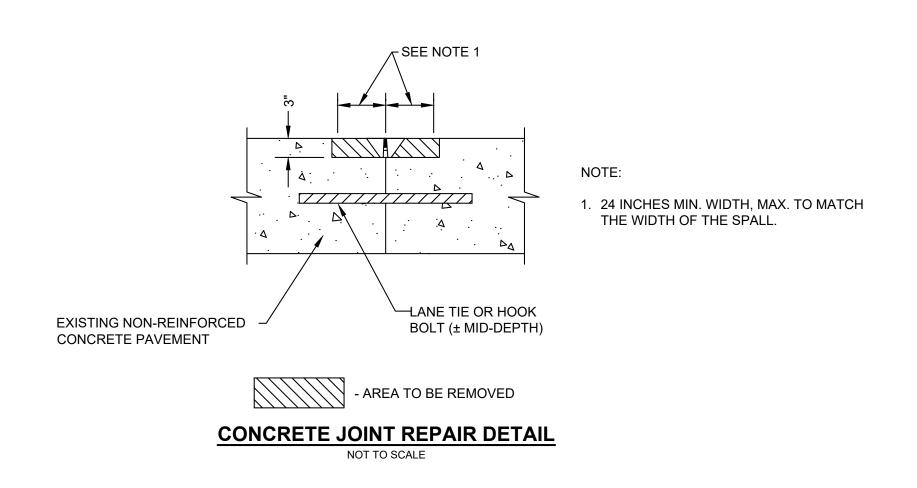


### HMA APPLICATION ESTIMATE FOR JOINT REPAIR

IDENT.	PAY ITEM	RATE PER SQ. YD.	PERFORMANCE GRADE	COMMENTS
HP	Hand Patching, Modified	330 LBS.	64-22	HMA, 5E1
*	*HMA BOND COAT	0.10 GAL.		REDUCE APPLICATION RATE AS DIRECTED BY THE ENGINEER


\*FOR INFORMATION ONLY (PAYMENT FOR BOND COATS SHALL BE INCLUDED IN HMA MIXTURES)

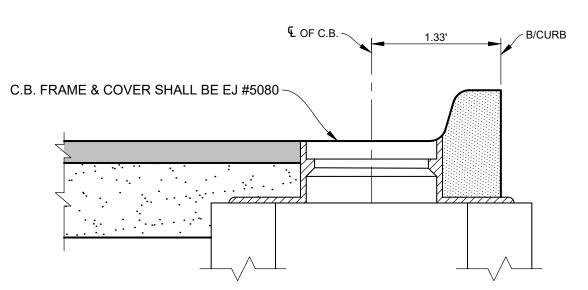

TYPICAL CATCH BASIN STAKING DIAGRAM

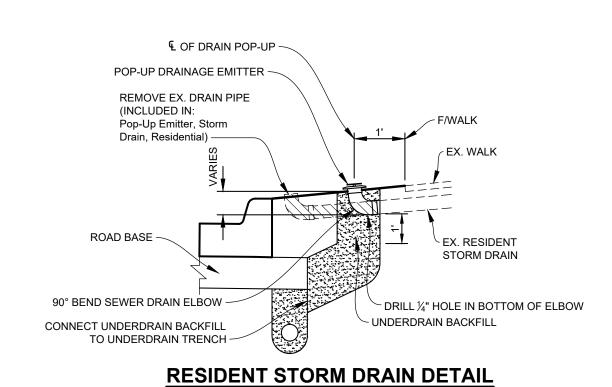

NOT TO SCALE

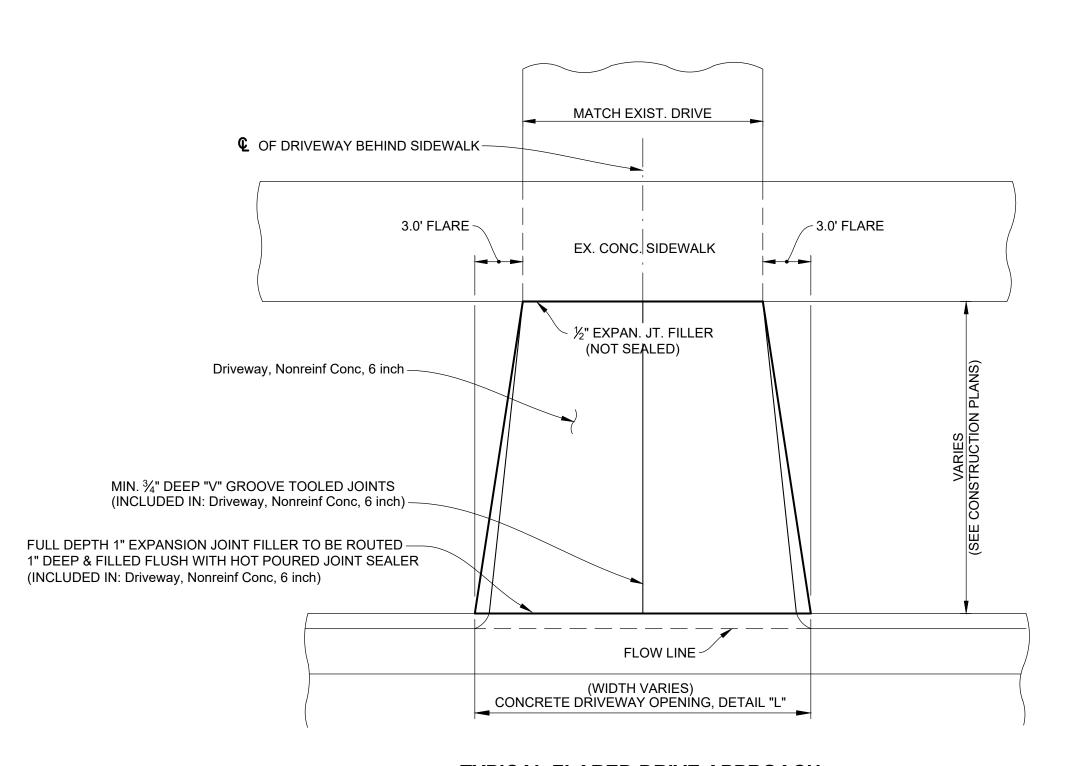

TYPICAL FLARED DRIVE APPROACH

ANDERSON, ECKSTEIN AND WESTRICK, INC.

CIVIL ENGINEERS SURVEYORS ARCHITECTS


Fax 586 726 8780

51301 Schoenherr Road

Shelby Township Michigan 48315

www.aewinc.com

ENGINEERING STRONG COMMUNITIES

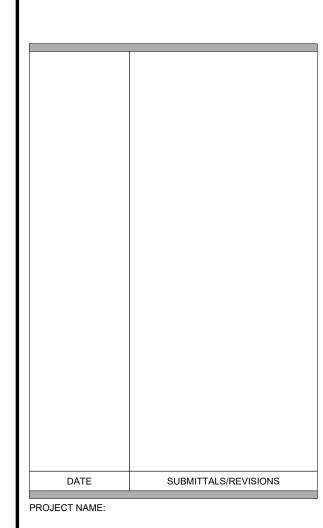


## **ALLARD AVENUE** RECONSTRUCTION HARPER TO CHESTER

SHEET TITLE:

## **MISCELLANEOUS PROJECT DETAILS**

**GROSSE POINTE WOODS** 

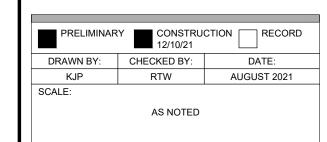



JTILITY INFORMATION, AS SHOWN, INDICATES APPROXIMATE LOCATIONS AND TYPES OF EXISTING FACILITIES ONLY, AS DISCLOSED BY RECORDS PROVIDED TO THIS FIRM FROM THE VARIOUS UTILITY COMPANIES. NO GUARANTEE IS GIVEN OR IMPLIED AS TO THE COMPLETENESS OR ACCURACY THEREOF.


PRIOR TO CONSTRUCTION, ALL LOCATIONS AND DEPTHS OF EXISTING OVERHEAD AND UNDERGROUND UTILITIES (IN CONFLICT WITH THE CONSTRUCTION OF THESE PROPOSED IMPROVEMENTS) SHALL BE VERIFIED IN THE FIELD. DURING THE CONSTRUCTION, THE CONTRACTOR SHALL PROTECT AND SUPPORT ALL UTILITIES THAT ARE ENCOUNTERED. (ALL COSTS FOR UTILITY LOCATION VERIFICATION, SUPPORT AND PROTECTION SHALL BE INCLUDED IN THE PROPOSED PAY ITEM CONFLICTING WITH

DURING CONSTRUCTION, THE CONTRACTOR SHALL USE EXTREME CAUTION WHEN OPERATING NEAR ANY AND ALL OVERHEAD AND / OR BURIED UTILITIES.

0160-0433

M:\0160\0160-0433\DWG\CIVIL\03\_MISCDTL.DWG 03\_MiscDtl--12/10/2021 3:35:44 PM SHEET NO.

PROJECT NO.

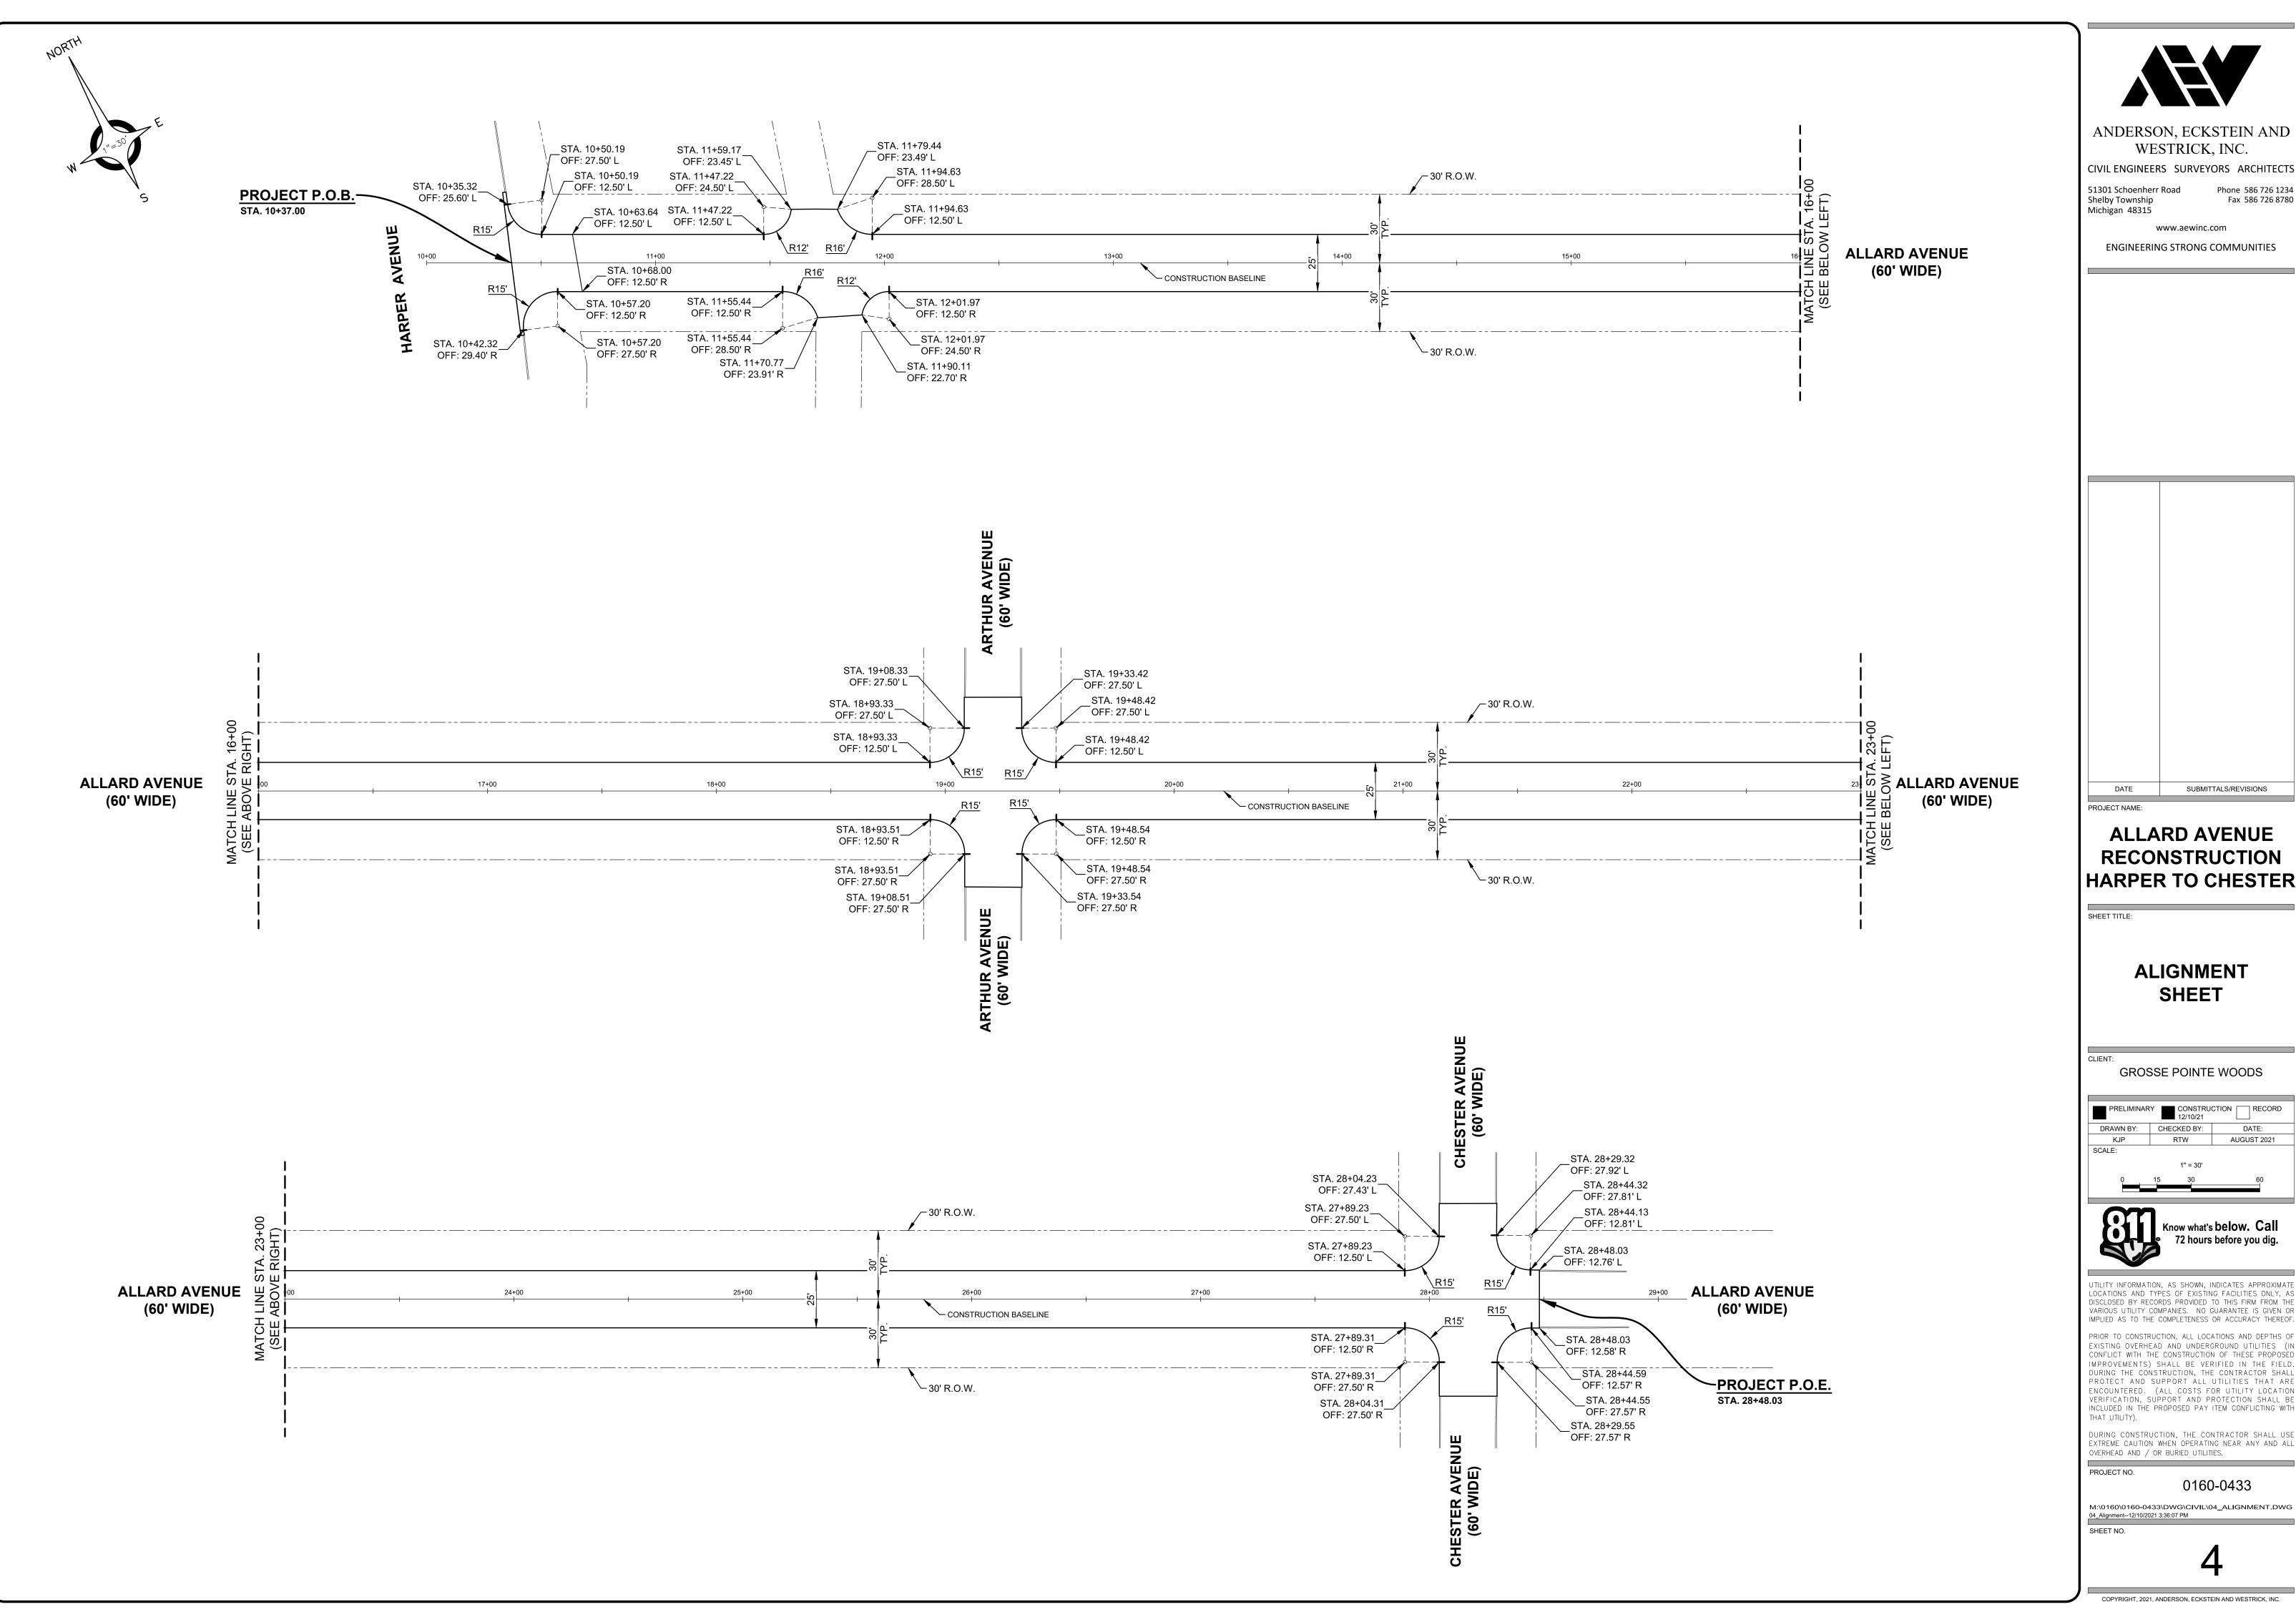



51301 Schoenherr Road Phone 586 726 1234 Fax 586 726 8780

www.aewinc.com


ENGINEERING STRONG COMMUNITIES


SUBMITTALS/REVISIONS DATE PROJECT NAME:

## **ALLARD AVENUE** RECONSTRUCTION HARPER TO CHESTER

## **ALIGNMENT** SHEET

GROSSE POINTE WOODS

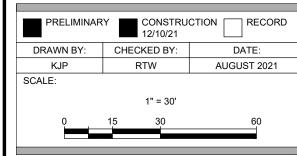

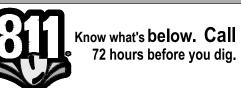


UTILITY INFORMATION, AS SHOWN, INDICATES APPROXIMATE LOCATIONS AND TYPES OF EXISTING FACILITIES ONLY, AS DISCLOSED BY RECORDS PROVIDED TO THIS FIRM FROM THE VARIOUS UTILITY COMPANIES. NO GUARANTEE IS GIVEN OR IMPLIED AS TO THE COMPLETENESS OR ACCURACY THEREOF.

PRIOR TO CONSTRUCTION, ALL LOCATIONS AND DEPTHS OF EXISTING OVERHEAD AND UNDERGROUND UTILITIES (IN CONFLICT WITH THE CONSTRUCTION OF THESE PROPOSED IMPROVEMENTS) SHALL BE VERIFIED IN THE FIELD. DURING THE CONSTRUCTION, THE CONTRACTOR SHALL PROTECT AND SUPPORT ALL UTILITIES THAT ARE ENCOUNTERED. (ALL COSTS FOR UTILITY LOCATION VERIFICATION, SUPPORT AND PROTECTION SHALL BE INCLUDED IN THE PROPOSED PAY ITEM CONFLICTING WITH

DURING CONSTRUCTION, THE CONTRACTOR SHALL USE EXTREME CAUTION WHEN OPERATING NEAR ANY AND ALL OVERHEAD AND / OR BURIED UTILITIES.

0160-0433


M:\0160\0160-0433\DWG\CIVIL\04\_ALIGNMENT.DWG 04\_Alignment--12/10/2021 3:36:07 PM

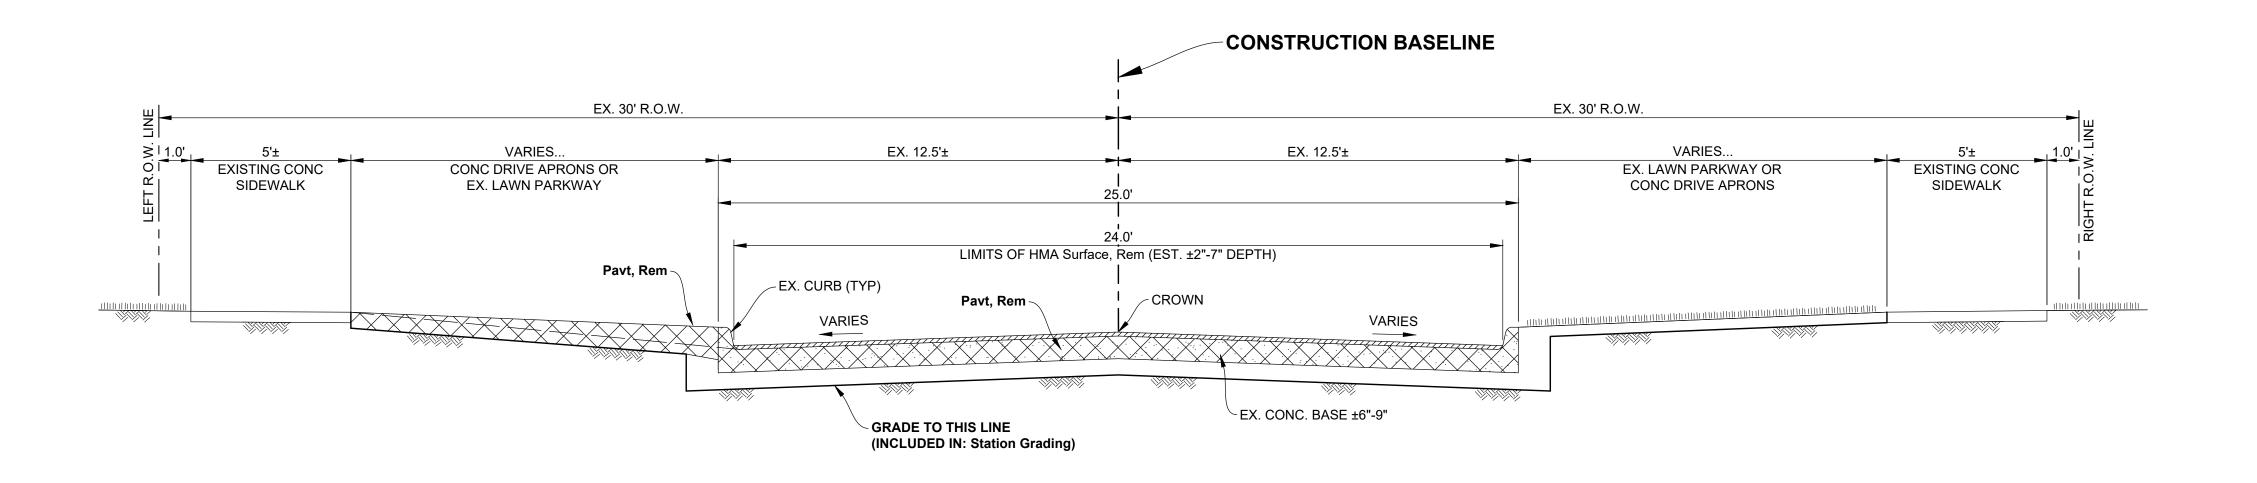

#### **EXISTING PAVEMENT SECTION**

STA. 10+65.82 TO STA. 28+48.03 (P.O.E.)

SCALE: 1" = 3'

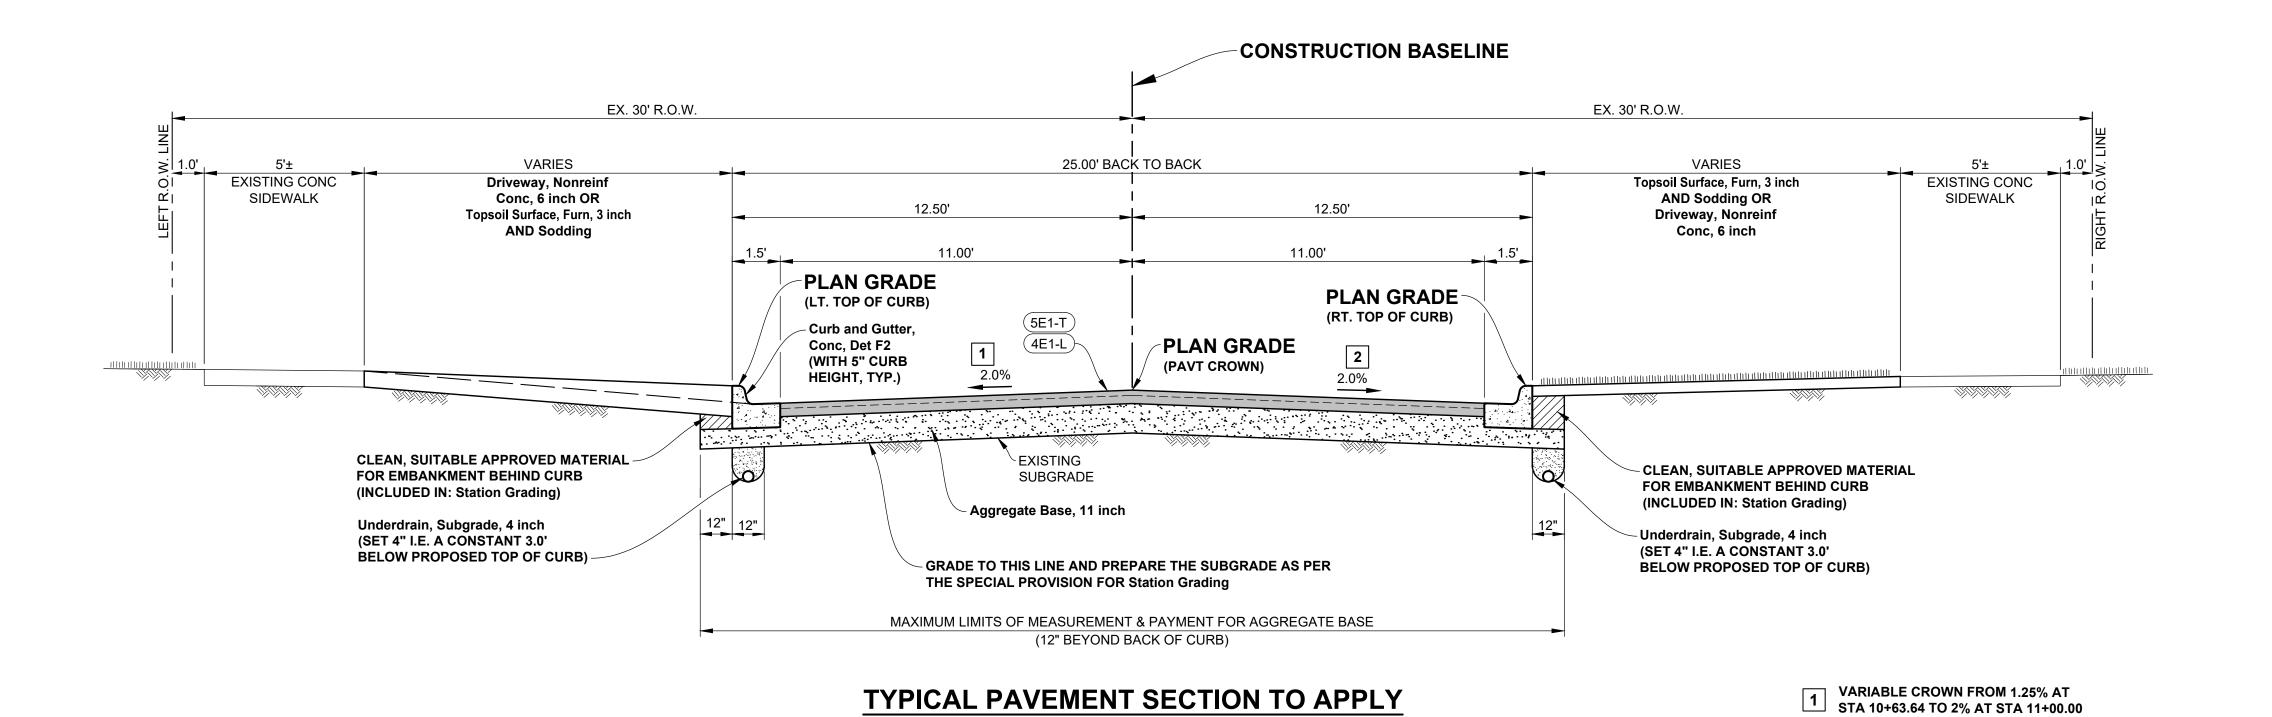

TYPICAL PAVEMENT SECTION TO APPLY STA. 10+65.82 TO STA. 28+48.03 (P.O.E.)

SCALE: 1" = 3'

#### HMA APPLICATION ESTIMATE

IDENT. NO.	PAY ITEM	RATE PER SQ. YD.	ESTIMATED THICKNESS	PERFORMANCE GRADE	COMMENTS
5E1-T	HMA, 5E1	220 LBS	2"	58-22	TOP COURSE (AWI = 220 MIN.)
4E1-L	HMA, 4E1	330 LBS	3"	58-22	LEVELING COURSE
	* HMA BOND COAT	0.05-0.10 GAL.	N/A	N/A	REDUCE APPLICATION RATE AS DIRECTED BY THE ENGINEER

VARIABLE CROWN FROM 1.00% AT STA 10+68.00 TO 2% AT STA 11+00.00

\*FOR INFORMATION ONLY. PAYMENT FOR HMA BOND COAT IS INCLUDED IN UNIT PRICE BID FOR HMA MIXTURES.

NOTE: HMA MIXTURES SHALL BE PLACED IN LIFTS WHICH DO NOT EXCEED THE MAXIMUM HMA APPLICATION RATES IN THE CURRENT MDOT HMA SELECTION GUIDELINES

ANDERSON, ECKSTEIN AND WESTRICK, INC.


Fax 586 726 8780

CIVIL ENGINEERS SURVEYORS ARCHITECTS

51301 Schoenherr Road Shelby Township Michigan 48315

www.aewinc.com

ENGINEERING STRONG COMMUNITIES

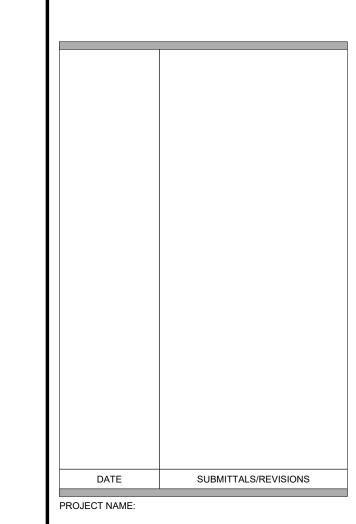


## **ALLARD AVENUE RECONSTRUCTION** HARPER TO CHESTER

SHEET TITLE:

### **TYPICAL CROSS SECTIONS**

**GROSSE POINTE WOODS** 

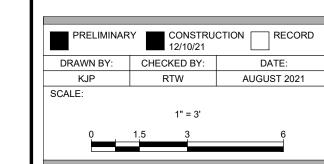



JTILITY INFORMATION, AS SHOWN, INDICATES APPROXIMATE LOCATIONS AND TYPES OF EXISTING FACILITIES ONLY, AS DISCLOSED BY RECORDS PROVIDED TO THIS FIRM FROM THE VARIOUS UTILITY COMPANIES. NO GUARANTEE IS GIVEN OR IMPLIED AS TO THE COMPLETENESS OR ACCURACY THEREOF.

PRIOR TO CONSTRUCTION, ALL LOCATIONS AND DEPTHS OF EXISTING OVERHEAD AND UNDERGROUND UTILITIES (IN CONFLICT WITH THE CONSTRUCTION OF THESE PROPOSED IMPROVEMENTS) SHALL BE VERIFIED IN THE FIELD. DURING THE CONSTRUCTION, THE CONTRACTOR SHALL PROTECT AND SUPPORT ALL UTILITIES THAT ARE ENCOUNTERED. (ALL COSTS FOR UTILITY LOCATION VERIFICATION, SUPPORT AND PROTECTION SHALL BE INCLUDED IN THE PROPOSED PAY ITEM CONFLICTING WITH


DURING CONSTRUCTION, THE CONTRACTOR SHALL USE EXTREME CAUTION WHEN OPERATING NEAR ANY AND ALL OVERHEAD AND / OR BURIED UTILITIES.


PROJECT NO.

SHEET NO.

0160-0433

M:\0160\0160-0433\DWG\CIVIL\05\_X-SECT.DWG .....0 100/0160-0433\DW 05\_Xsect--12/10/2021 3:36:18 PM

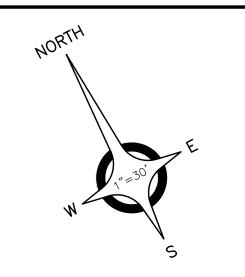

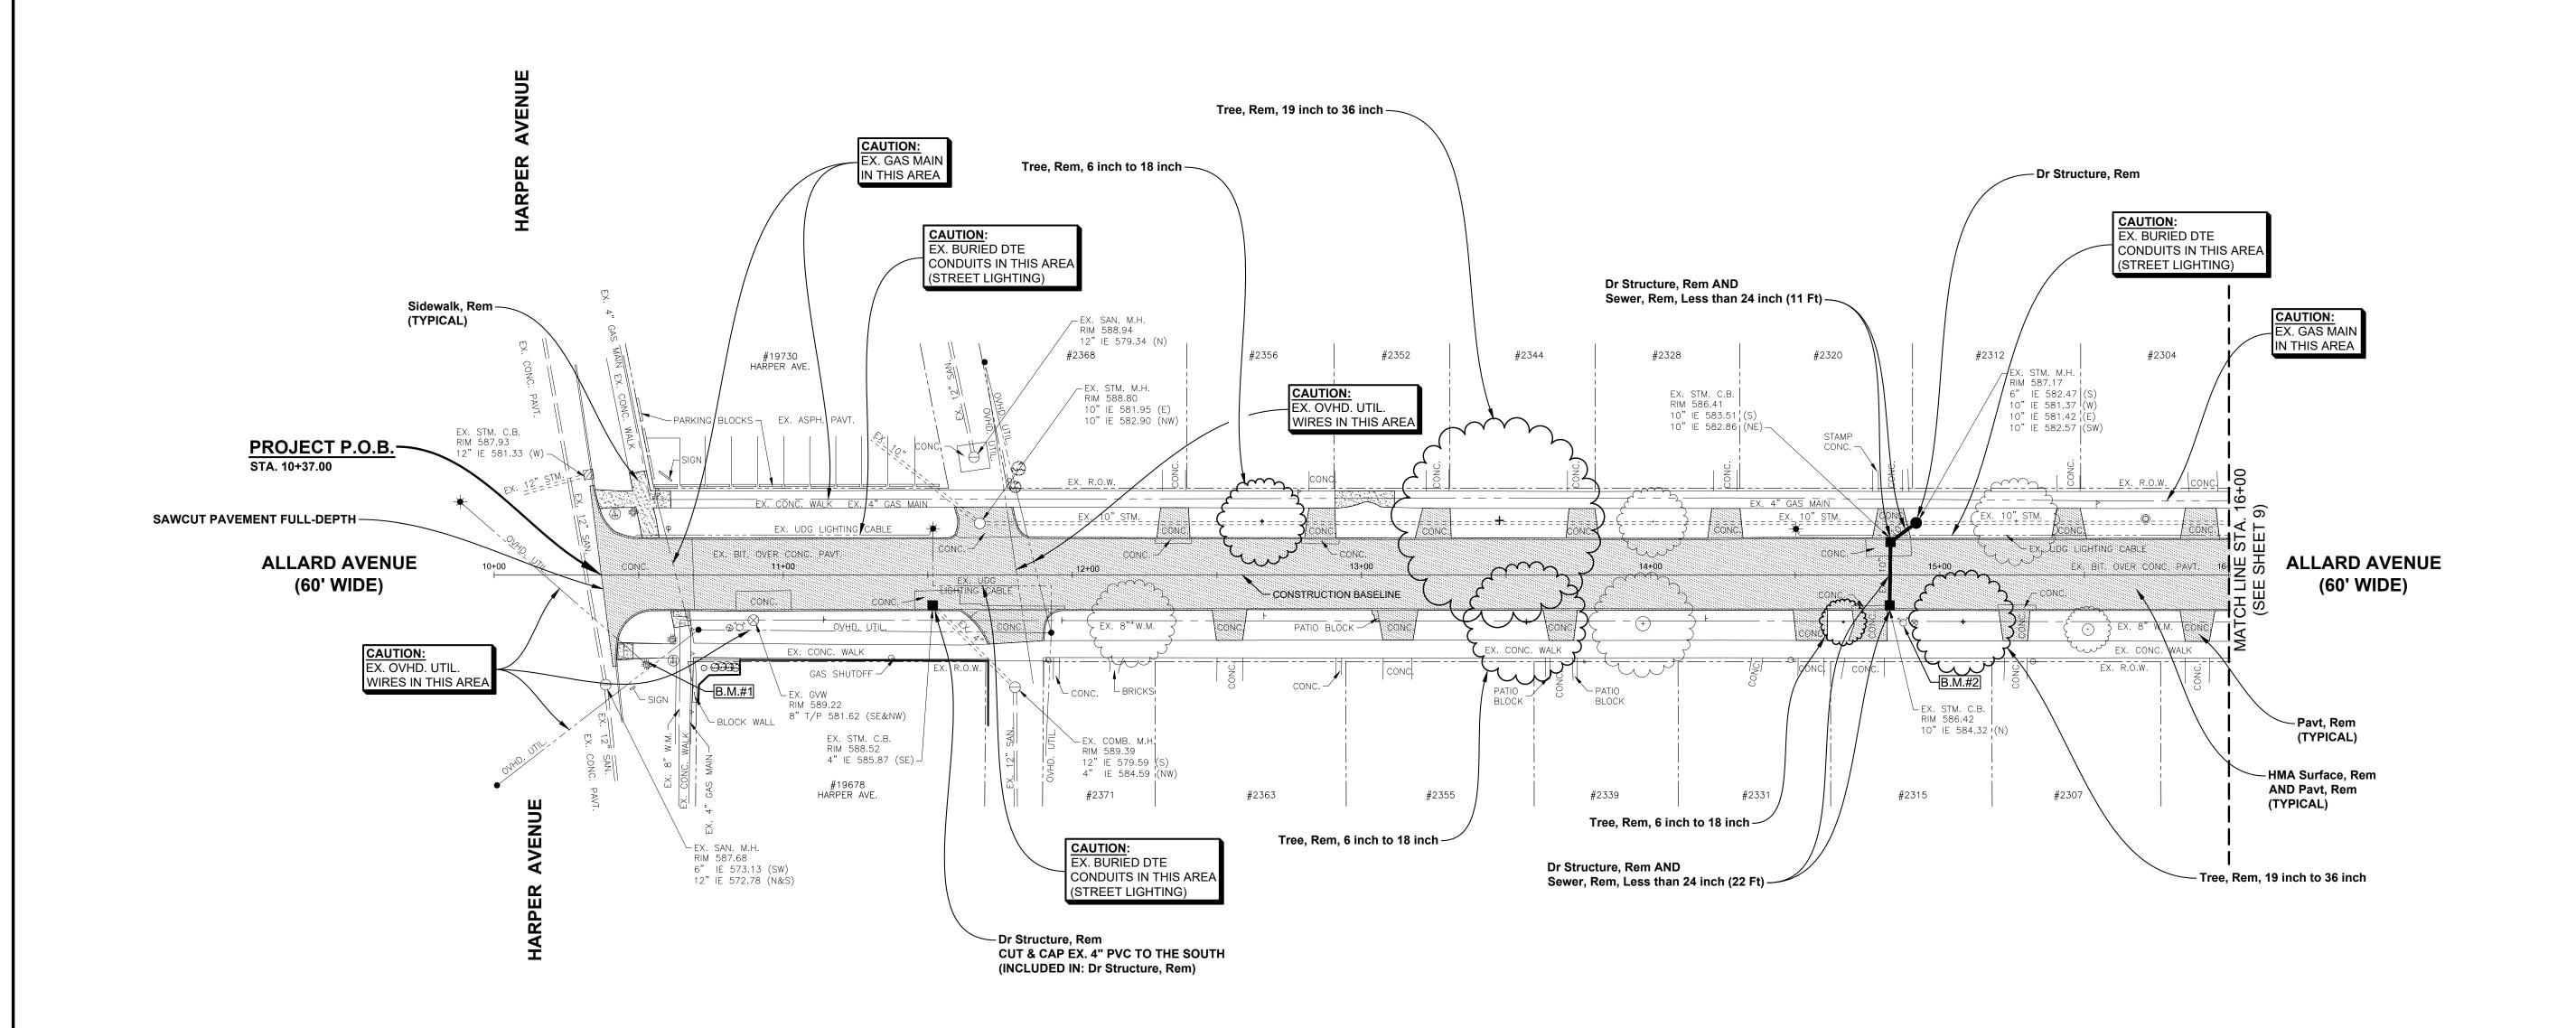

111+90.8 111+91.8 11+92.7 11+96.3

#### **ESTIMATED QUANTITIES** (THIS SHEET)

	•	•	
1.	Tree, Rem, 19 inch to 36 inch	2	Ea
2.	Tree, Rem, 6 inch to 18 inch	3	Ea
3.	Dr Structure, Rem	4	Ea
4.	Sewer, Rem, Less than 24 inch	33	Ft
5.	HMA Surface, Rem	1,421	Syd
6.	Pavt, Rem	1,827	Syd
7.	Sidewalk, Rem	47	Syd

BENCH MARK NO.1 CHIS "X" NORTH BOLT TRAFFIC OF UTILITY POLE AT SOUTHEAST CORNER OF ALLARD AVE. AND HARPER AVE. ELEVATION: 589.99 (NAVD 88)

BENCH MARK NO.2 TOP OF HYDRANT OF SOUTH SIDE OF ALLARD AT HSE. #2315. ELEVATION: 589.34 (NAVD 88)



ANDERSON, ECKSTEIN AND WESTRICK, INC.


CIVIL ENGINEERS SURVEYORS ARCHITECTS

Fax 586 726 8780

51301 Schoenherr Road Phone 586 726 1234 Shelby Township

Michigan 48315 www.aewinc.com

ENGINEERING STRONG COMMUNITIES

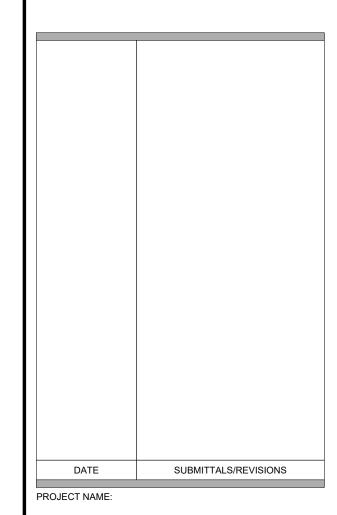



## **ALLARD AVENUE** RECONSTRUCTION HARPER TO CHESTER

SHEET TITLE:

**REMOVAL PLAN** HARPER AVE. TO STA. 16+00

**GROSSE POINTE WOODS** 

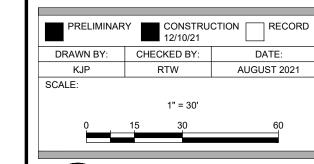

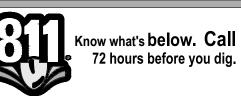

UTILITY INFORMATION, AS SHOWN, INDICATES APPROXIMATE LOCATIONS AND TYPES OF EXISTING FACILITIES ONLY, AS

DISCLOSED BY RECORDS PROVIDED TO THIS FIRM FROM THE VARIOUS UTILITY COMPANIES. NO GUARANTEE IS GIVEN OR IMPLIED AS TO THE COMPLETENESS OR ACCURACY THEREOF. PRIOR TO CONSTRUCTION, ALL LOCATIONS AND DEPTHS OF EXISTING OVERHEAD AND UNDERGROUND UTILITIES (IN

CONFLICT WITH THE CONSTRUCTION OF THESE PROPOSED IMPROVEMENTS) SHALL BE VERIFIED IN THE FIELD. DURING THE CONSTRUCTION, THE CONTRACTOR SHALL PROTECT AND SUPPORT ALL UTILITIES THAT ARE ENCOUNTERED. (ALL COSTS FOR UTILITY LOCATION VERIFICATION, SUPPORT AND PROTECTION SHALL BE INCLUDED IN THE PROPOSED PAY ITEM CONFLICTING WITH


DURING CONSTRUCTION, THE CONTRACTOR SHALL USE EXTREME CAUTION WHEN OPERATING NEAR ANY AND ALL OVERHEAD AND / OR BURIED UTILITIES.

PROJECT NO.

0160-0433

M:\0160\0160-0433\DWG\CIVIL\00\_ENGPLANS.DWG 06\_Rem 1--12/10/2021 3:36:39 PM SHEET NO.



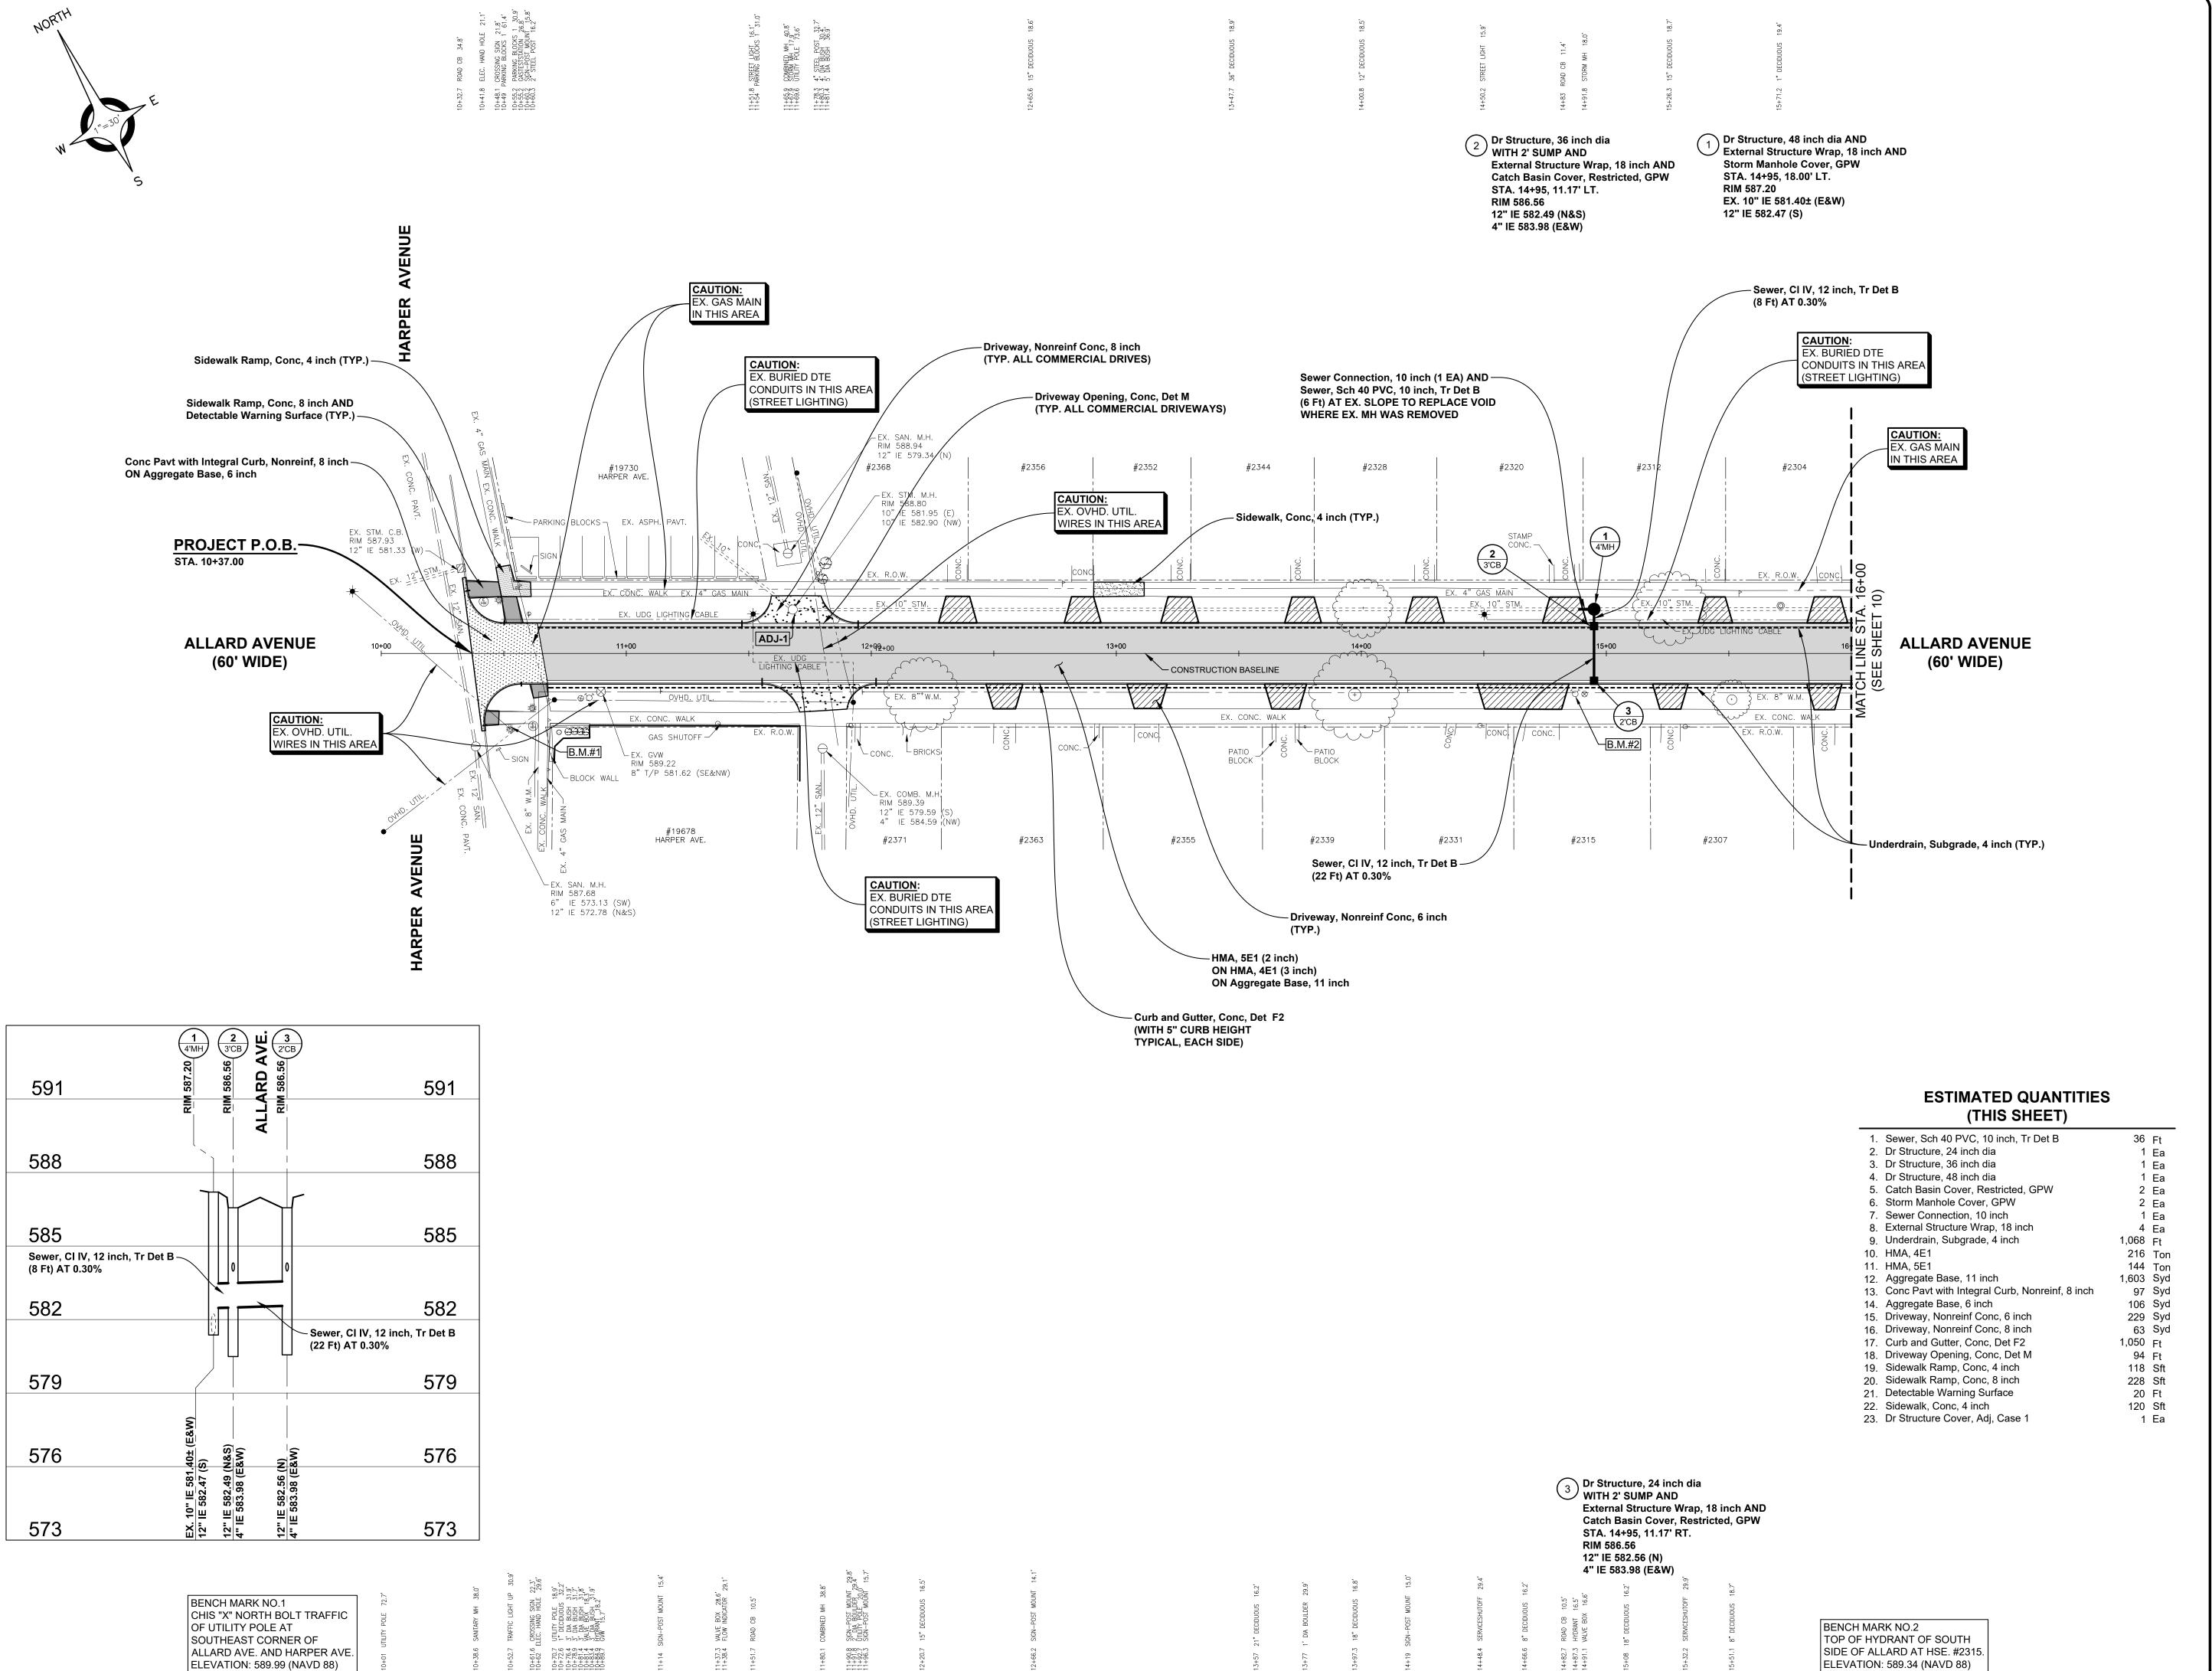

ELEVATION: 589.99 (NAVD 88)



ANDERSON, ECKSTEIN AND WESTRICK, INC.

Phone 586 726 1234

Fax 586 726 8780

CIVIL ENGINEERS SURVEYORS ARCHITECTS

51301 Schoenherr Road Shelby Township Michigan 48315

www.aewinc.com

**ENGINEERING STRONG COMMUNITIES** 

SUBMITTALS/REVISIONS

## **ALLARD AVENUE RECONSTRUCTION** HARPER TO CHESTER

SHEET TITLE:


PROJECT NAME:

## CONSTRUCTION **PLAN**

HARPER AVE. TO STA. 16+00

**GROSSE POINTE WOODS** 

PRELIMINARY CONSTRUCTION RECORD 12/10/21 RTW AUGUST 2021

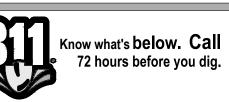

ITILITY INFORMATION, AS SHOWN, INDICATES APPROXIMATE LOCATIONS AND TYPES OF EXISTING FACILITIES ONLY, AS

DISCLOSED BY RECORDS PROVIDED TO THIS FIRM FROM THE VARIOUS UTILITY COMPANIES. NO GUARANTEE IS GIVEN OR IMPLIED AS TO THE COMPLETENESS OR ACCURACY THEREOF. PRIOR TO CONSTRUCTION, ALL LOCATIONS AND DEPTHS OF

EXISTING OVERHEAD AND UNDERGROUND UTILITIES (IN CONFLICT WITH THE CONSTRUCTION OF THESE PROPOSED IMPROVEMENTS) SHALL BE VERIFIED IN THE FIELD. DURING THE CONSTRUCTION, THE CONTRACTOR SHALL PROTECT AND SUPPORT ALL UTILITIES THAT ARE ENCOUNTERED. (ALL COSTS FOR UTILITY LOCATION VERIFICATION, SUPPORT AND PROTECTION SHALL BE INCLUDED IN THE PROPOSED PAY ITEM CONFLICTING WITH


DURING CONSTRUCTION, THE CONTRACTOR SHALL USE EXTREME CAUTION WHEN OPERATING NEAR ANY AND ALL OVERHEAD AND / OR BURIED UTILITIES.


PROJECT NO.

ELEVATION: 589.34 (NAVD 88)

0160-0433

M:\0160\0160-0433\DWG\CIVIL\00\_ENGPLANS.DWG 07\_Const 1--12/10/2021 4:18:40 PM SHEET NO.

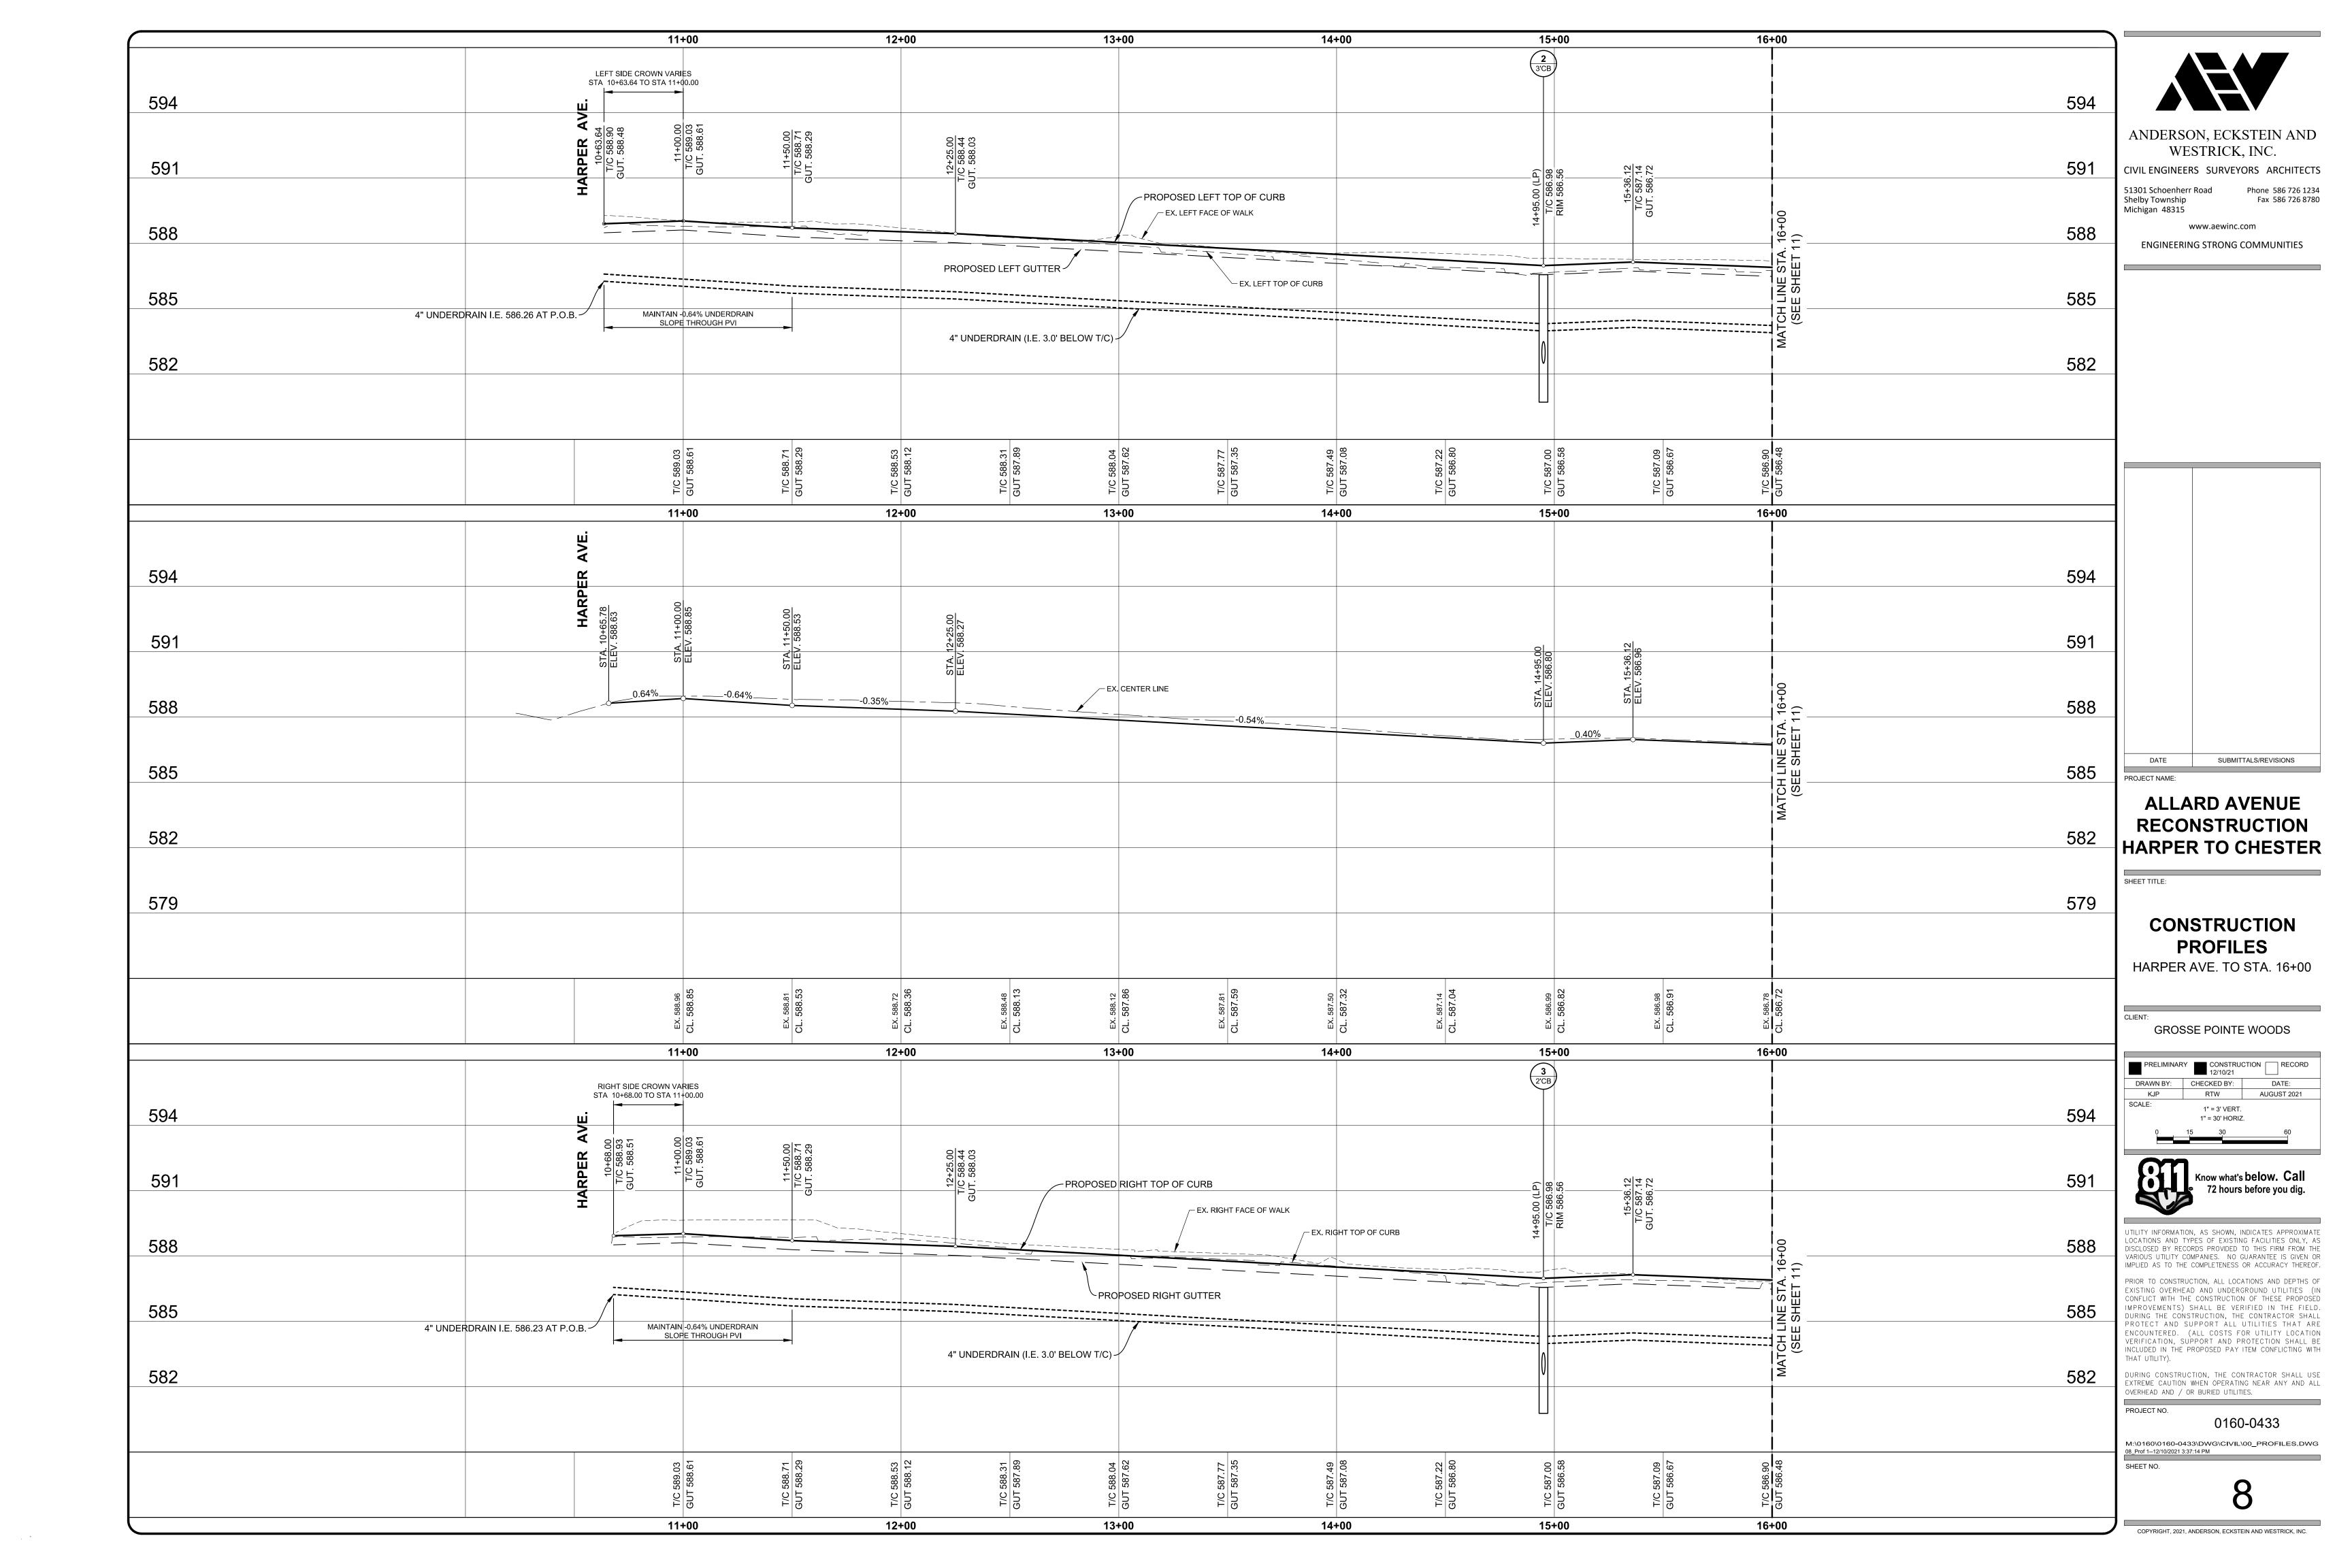

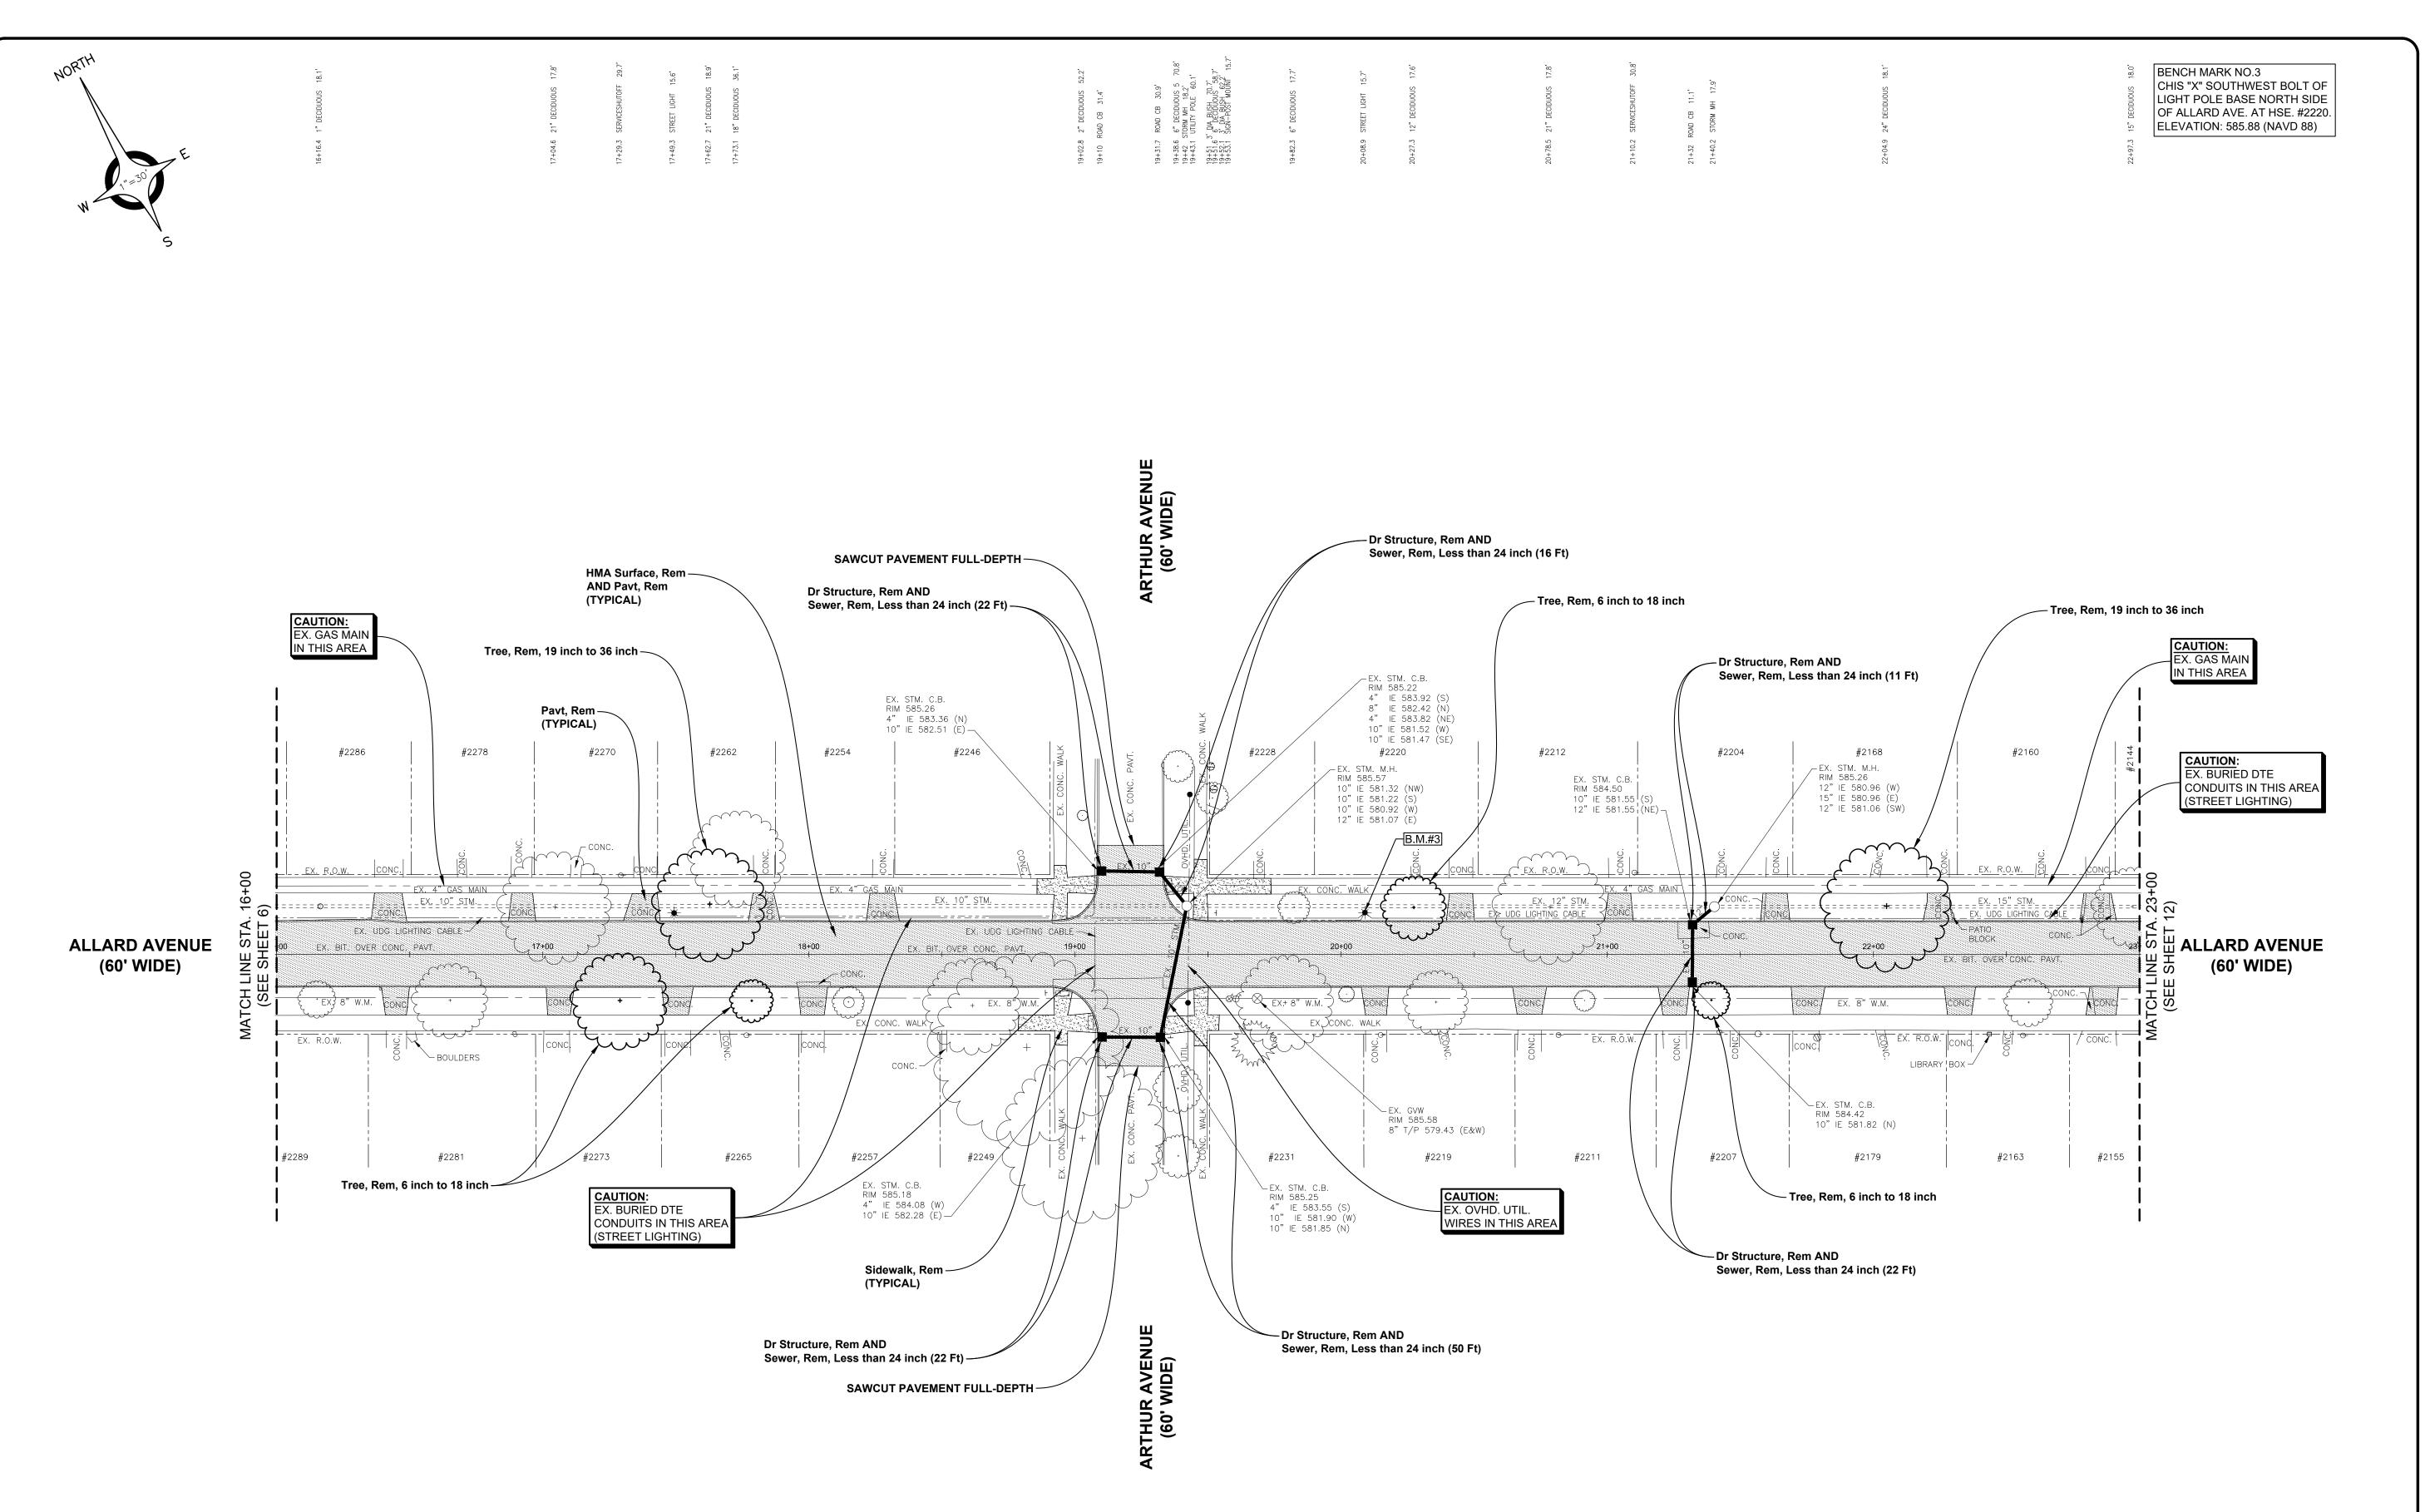

## ESTIMATED QUANTITIES (THIS SHEET)

1. Tree, Rem, 19 inch to 36 inch	2 Ea
2. Tree, Rem, 6 inch to 18 inch	4 Ea
3. Dr Structure, Rem	6 Ea
4. Sewer, Rem, Less than 24 inch	143 Ft
5. HMA Surface, Rem	1,865 Syd
6. Pavt, Rem	2,366 Syd
7. Sidewalk, Rem	112 Syd


ANDERSON, ECKSTEIN AND WESTRICK, INC.

CIVIL ENGINEERS SURVEYORS ARCHITECTS
51301 Schoenherr Road Phone 586 726 1234

Shelby Township Fax 586 726 8780 Michigan 48315

www.aewinc.com

ENGINEERING STRONG COMMUNITIES

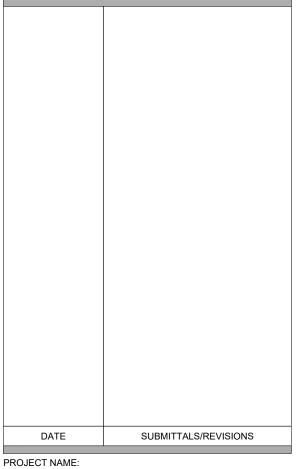


## ALLARD AVENUE RECONSTRUCTION HARPER TO CHESTER


SHEET TITLE:

REMOVAL PLAN STA. 16+00 TO STA. 23+00

ENT:

GROSSE POINTE WOODS

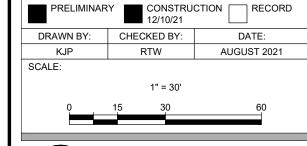

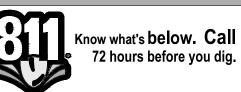

UTILITY INFORMATION, AS SHOWN, INDICATES APPROXIMATE LOCATIONS AND TYPES OF EXISTING FACILITIES ONLY, AS DISCLOSED BY RECORDS PROVIDED TO THIS FIRM FROM THE VARIOUS UTILITY COMPANIES. NO GUARANTEE IS GIVEN OR IMPLIED AS TO THE COMPLETENESS OR ACCURACY THEREOF.

PRIOR TO CONSTRUCTION, ALL LOCATIONS AND DEPTHS OF EXISTING OVERHEAD AND UNDERGROUND UTILITIES (IN CONFLICT WITH THE CONSTRUCTION OF THESE PROPOSED IMPROVEMENTS) SHALL BE VERIFIED IN THE FIELD. DURING THE CONSTRUCTION, THE CONTRACTOR SHALL PROTECT AND SUPPORT ALL UTILITIES THAT ARE ENCOUNTERED. (ALL COSTS FOR UTILITY LOCATION VERIFICATION, SUPPORT AND PROTECTION SHALL BE INCLUDED IN THE PROPOSED PAY ITEM CONFLICTING WITH


THAT UTILITY).

DURING CONSTRUCTION, THE CONTRACTOR SHALL USE EXTREME CAUTION WHEN OPERATING NEAR ANY AND ALL OVERHEAD AND / OR BURIED UTILITIES.

PROJECT NO. 0160-0433

M:\0160\0160-0433\DWG\CIVIL\00\_ENGPLANS.DWG 09\_Rem 2-12/10/2021 3:37:36 PM SHEET NO.

9

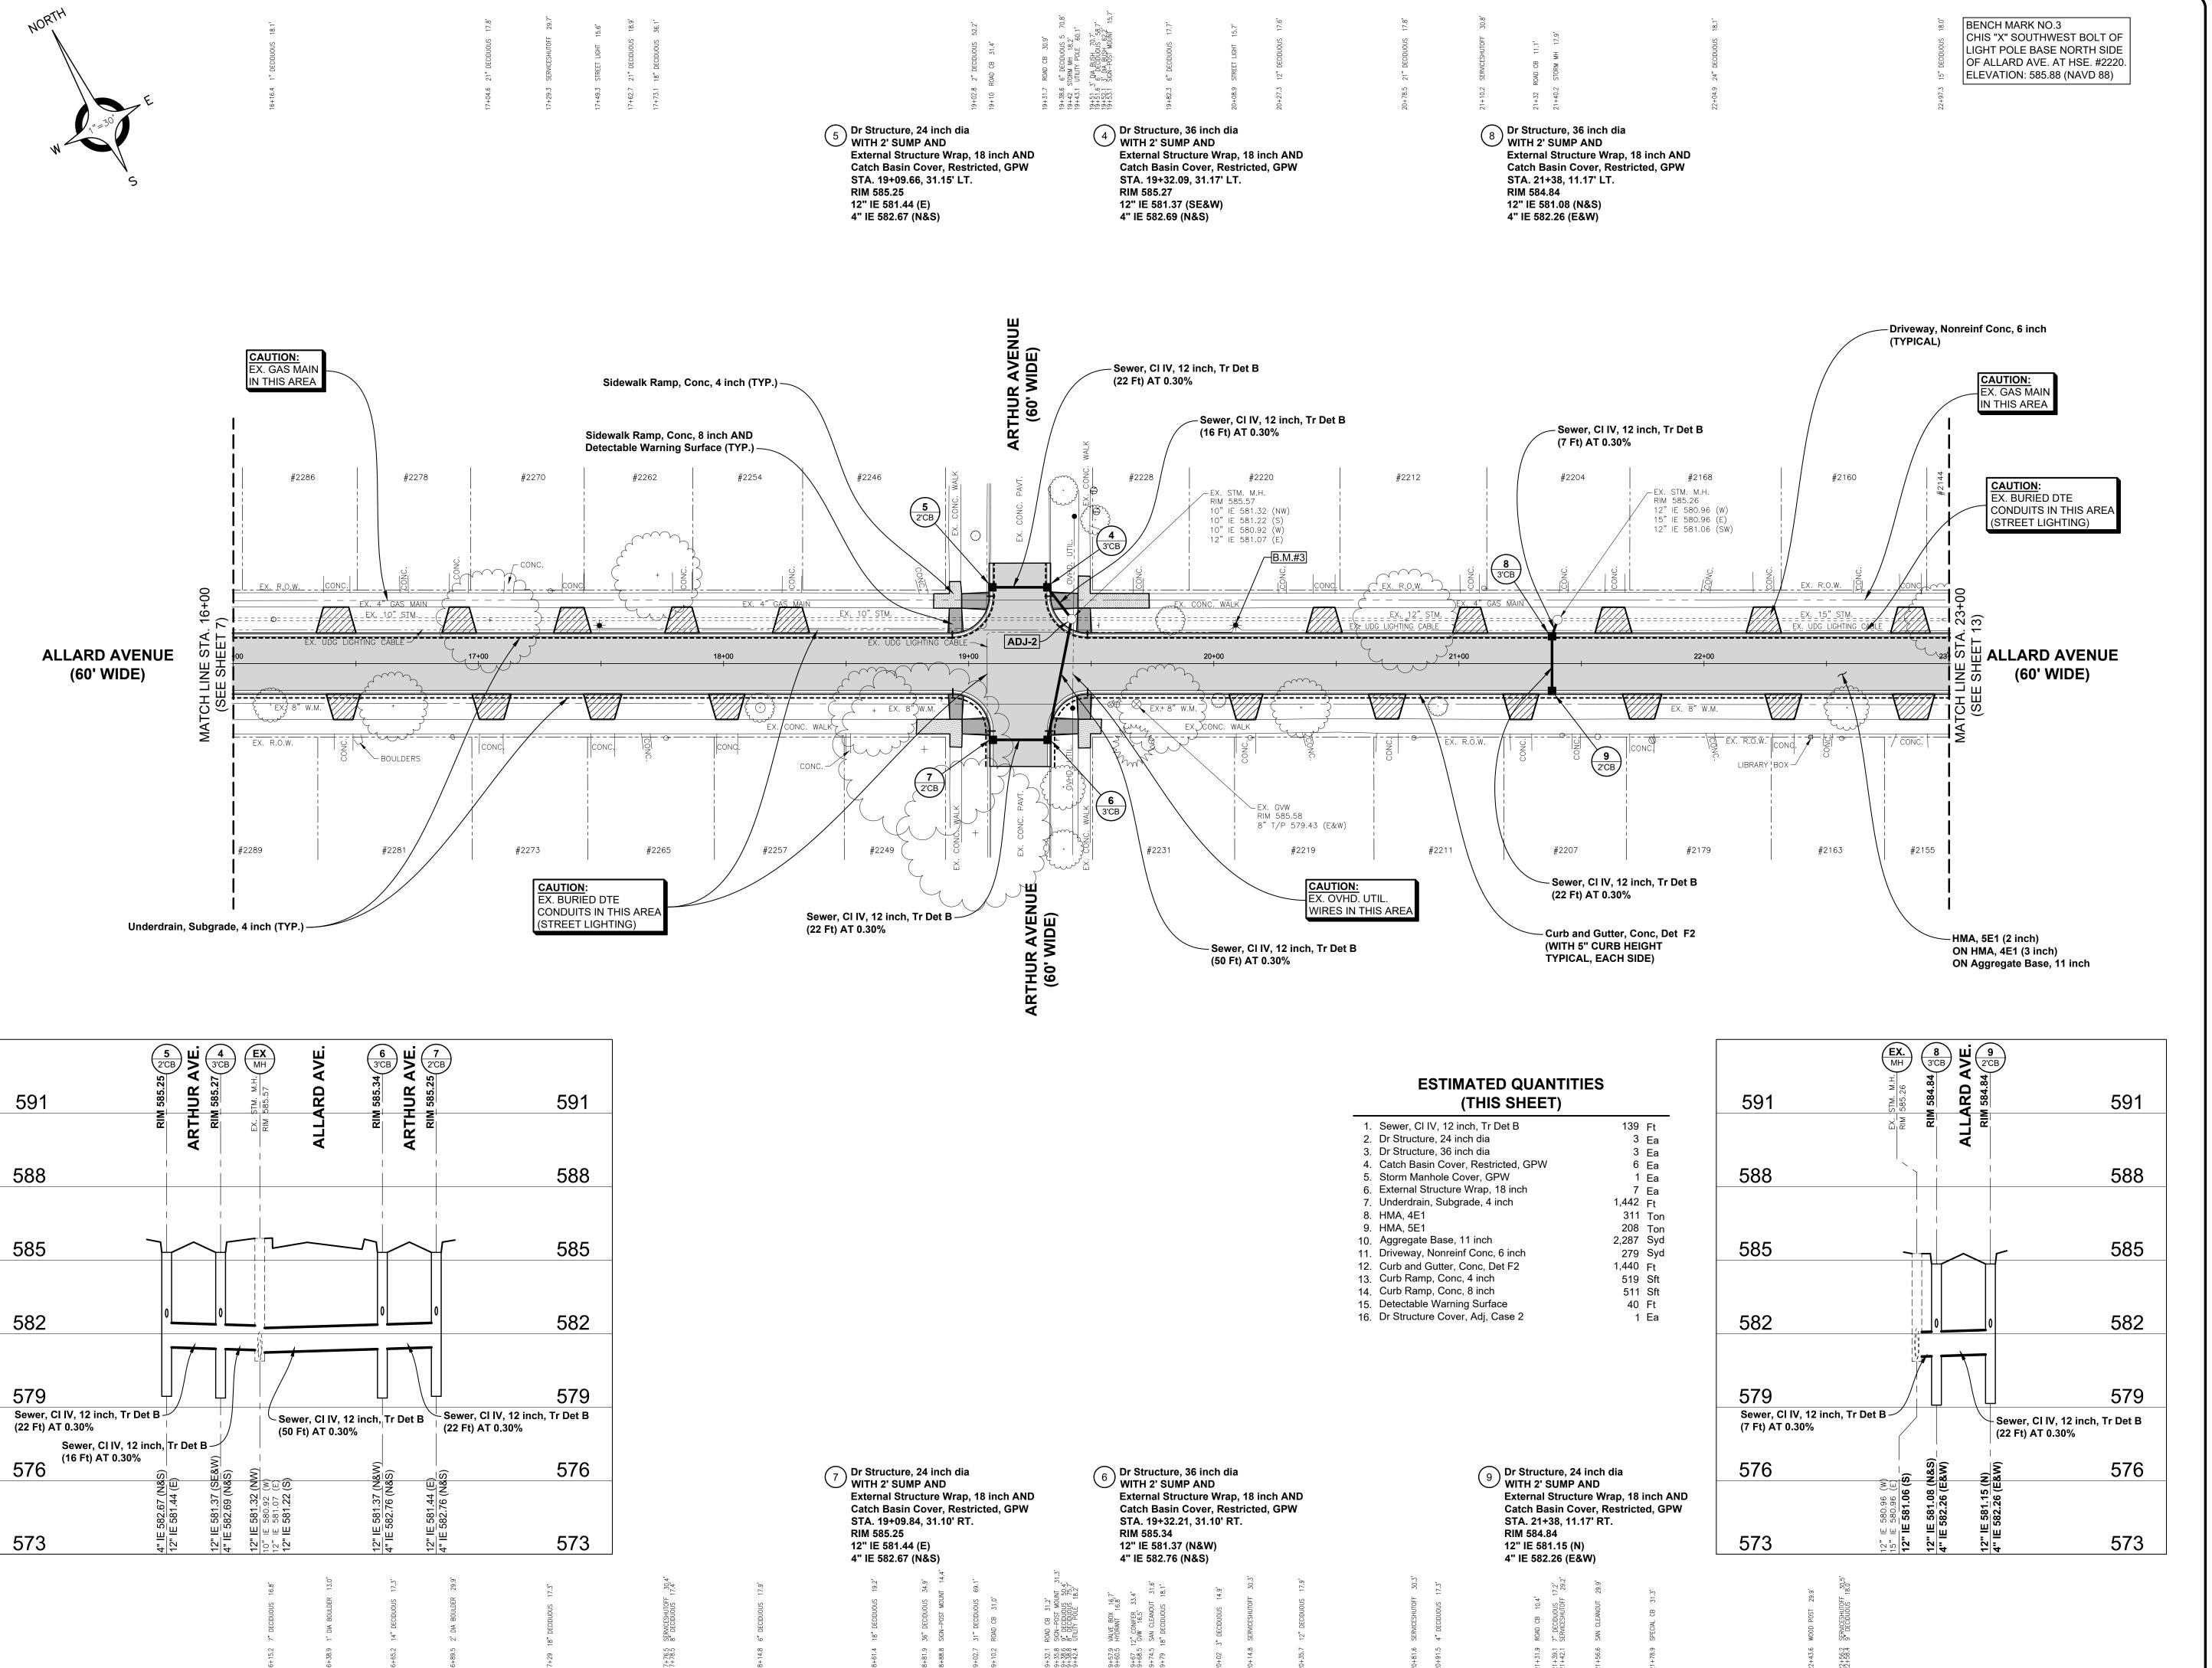




CIVIL ENGINEERS SURVEYORS ARCHITECTS

51301 Schoenherr Road Phone 586 726 1234 Shelby Township Michigan 48315

www.aewinc.com

Fax 586 726 8780

**ENGINEERING STRONG COMMUNITIES** 

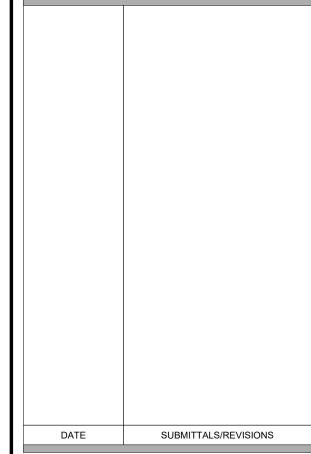

**ALLARD AVENUE RECONSTRUCTION** HARPER TO CHESTER


SHEET TITLE:


PROJECT NAME:

## CONSTRUCTION **PLAN**

STA. 16+00 TO STA. 23+00

**GROSSE POINTE WOODS** 

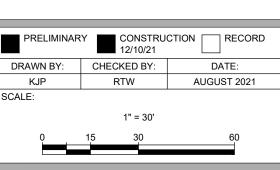

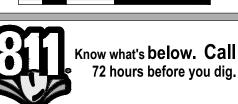

ITILITY INFORMATION, AS SHOWN, INDICATES APPROXIMATE LOCATIONS AND TYPES OF EXISTING FACILITIES ONLY, AS DISCLOSED BY RECORDS PROVIDED TO THIS FIRM FROM THE VARIOUS UTILITY COMPANIES. NO GUARANTEE IS GIVEN OR IMPLIED AS TO THE COMPLETENESS OR ACCURACY THEREOF.

PRIOR TO CONSTRUCTION, ALL LOCATIONS AND DEPTHS OF EXISTING OVERHEAD AND UNDERGROUND UTILITIES (IN CONFLICT WITH THE CONSTRUCTION OF THESE PROPOSED IMPROVEMENTS) SHALL BE VERIFIED IN THE FIELD. DURING THE CONSTRUCTION, THE CONTRACTOR SHALL PROTECT AND SUPPORT ALL UTILITIES THAT ARE ENCOUNTERED. (ALL COSTS FOR UTILITY LOCATION VERIFICATION, SUPPORT AND PROTECTION SHALL BE INCLUDED IN THE PROPOSED PAY ITEM CONFLICTING WITH


DURING CONSTRUCTION, THE CONTRACTOR SHALL USE XTREME CAUTION WHEN OPERATING NEAR ANY AND ALL OVERHEAD AND / OR BURIED UTILITIES.

0160-0433

M:\0160\0160-0433\DWG\CIVIL\00\_ENGPLANS.DWG 10\_Const 2--12/10/2021 3:37:51 PM SHEET NO.

PROJECT NO.



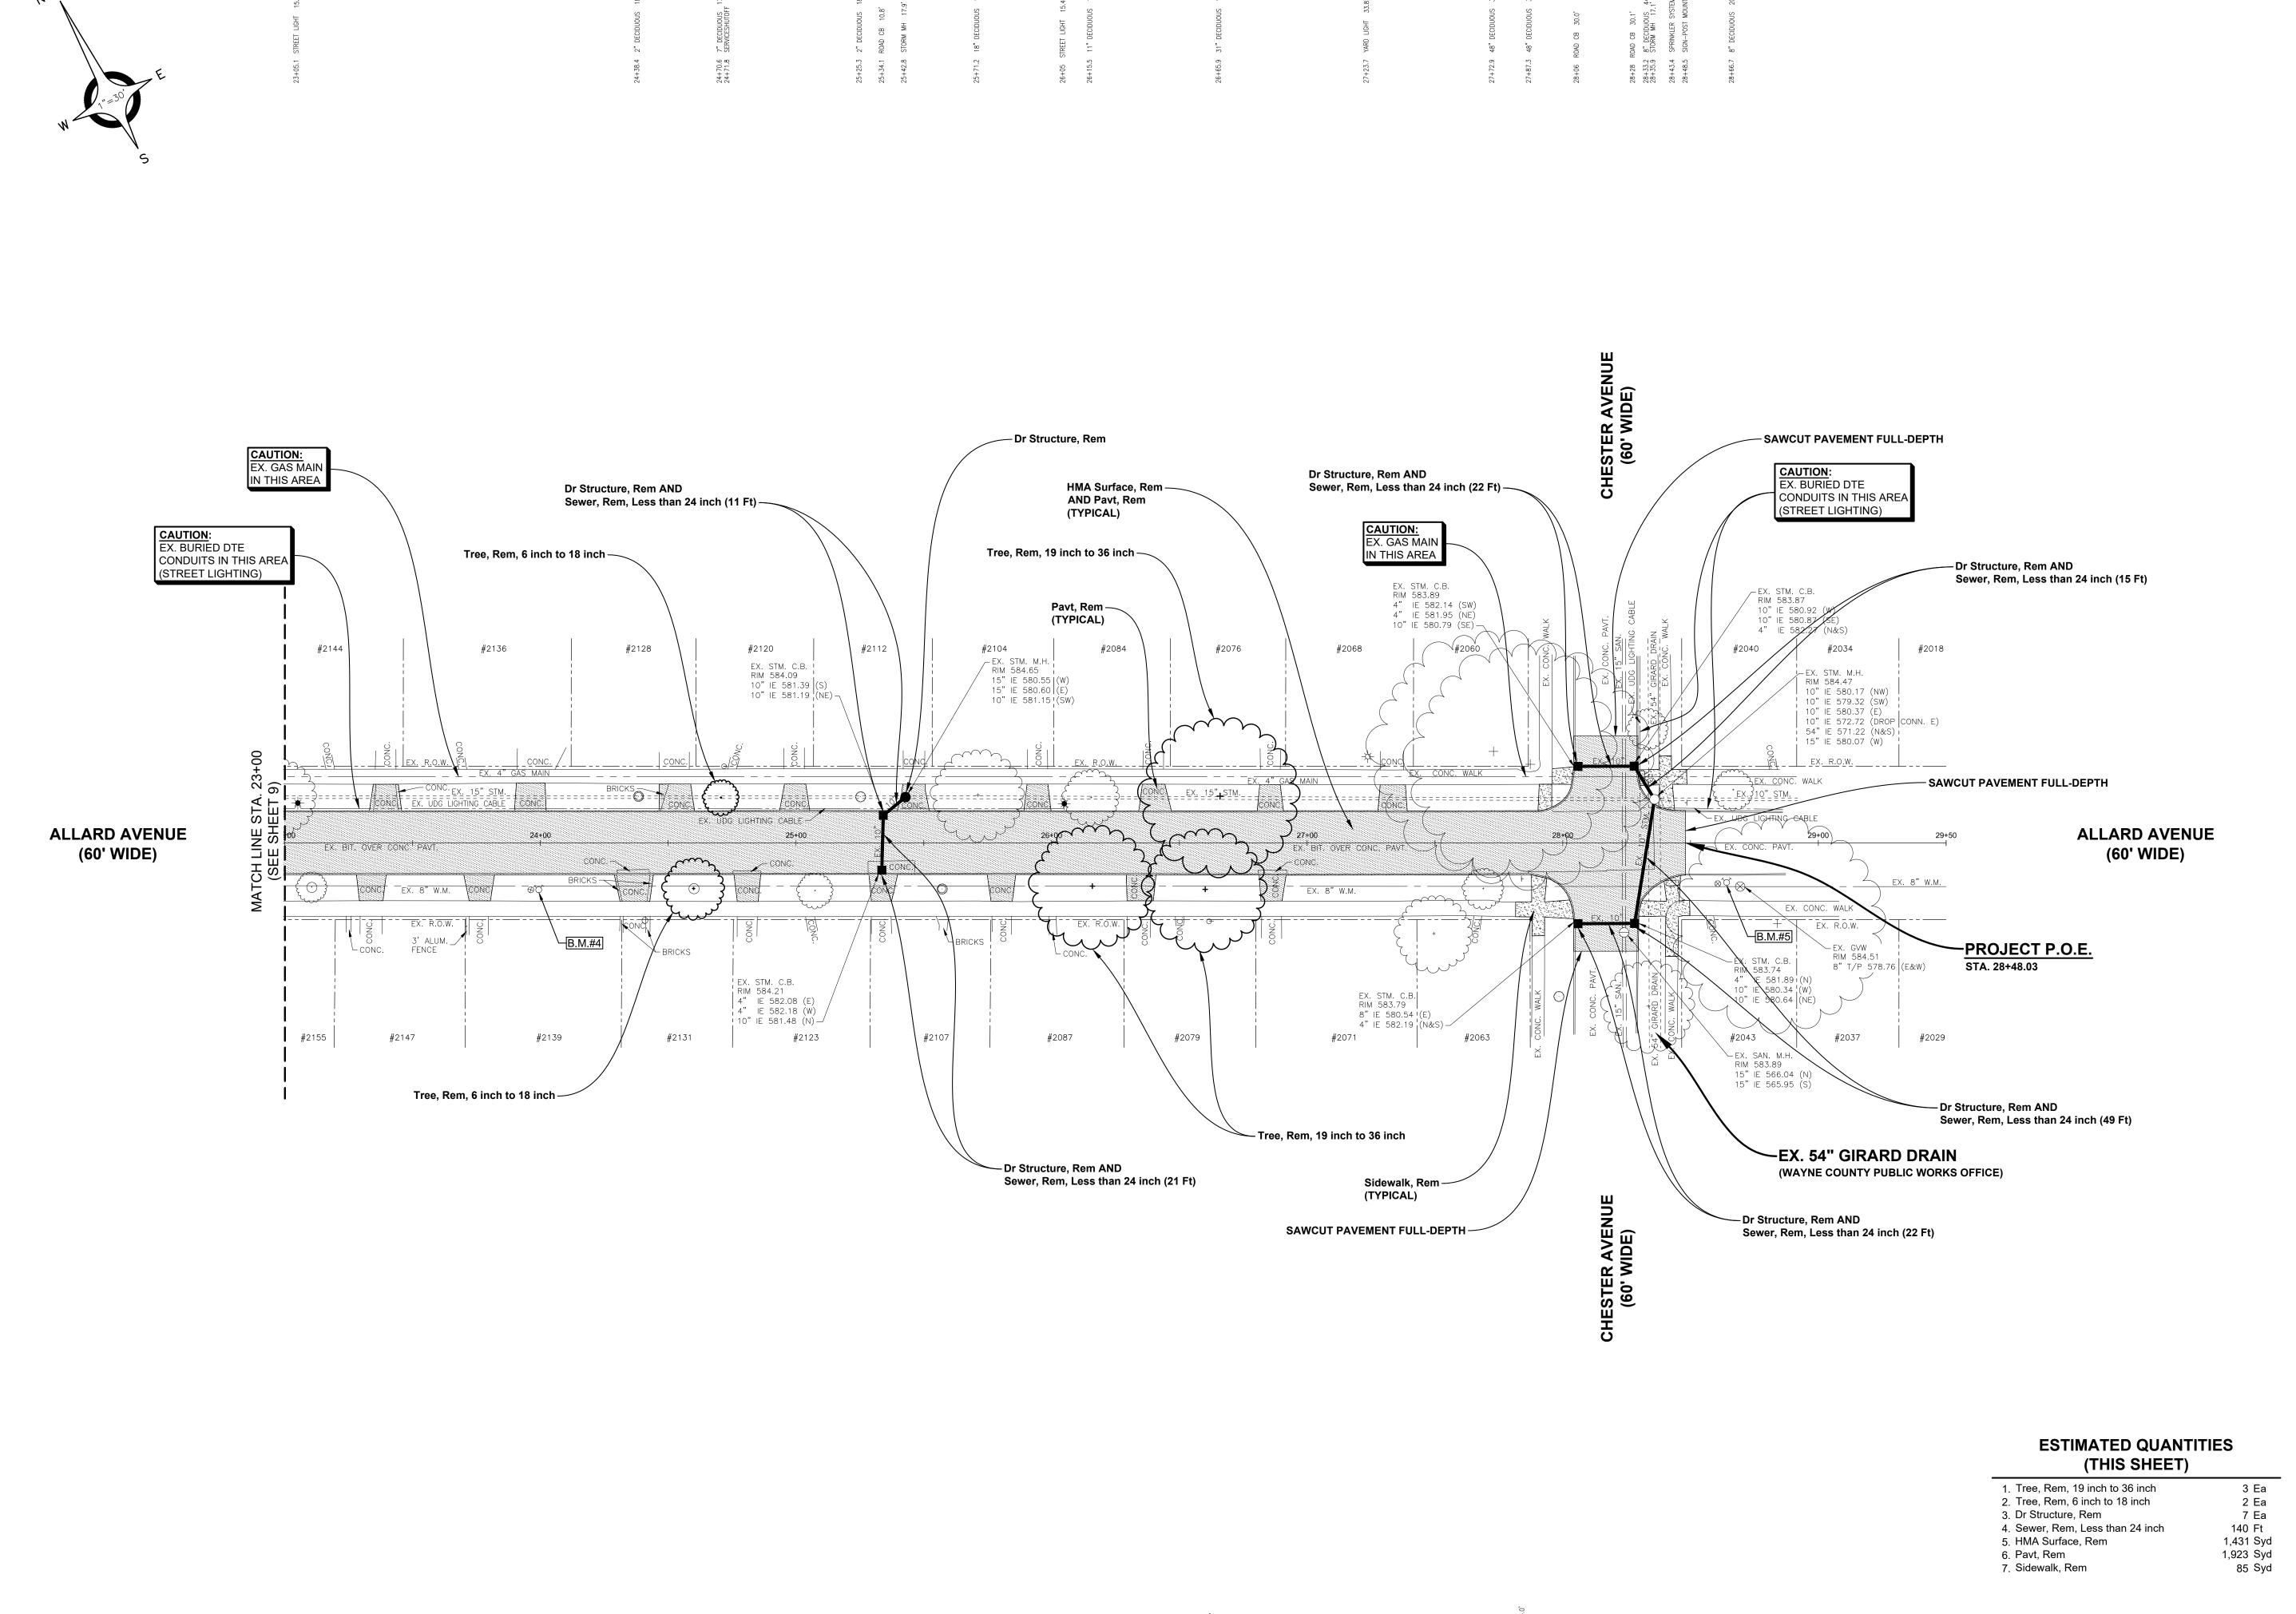

BENCH MARK NO.4

TOP OF HYDRANT OF SOUTH SIDE OF ALLARD AVE. AT HSE. # 2139.

ELEVATION: 587.75 (NAVD 88)

ANDERSON, ECKSTEIN AND WESTRICK, INC.


Fax 586 726 8780

CIVIL ENGINEERS SURVEYORS ARCHITECTS 51301 Schoenherr Road Phone 586 726 1234

Shelby Township

Michigan 48315 www.aewinc.com

ENGINEERING STRONG COMMUNITIES

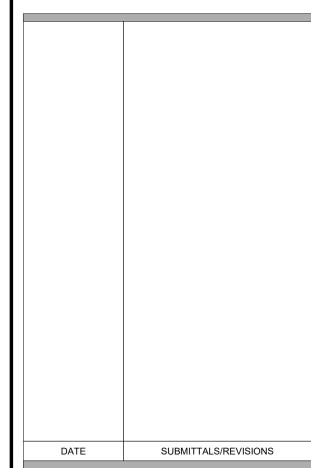


## **ALLARD AVENUE** RECONSTRUCTION HARPER TO CHESTER


SHEET TITLE:

PROJECT NAME:

**REMOVAL PLAN** STA. 23+00 TO CHESTER AVE.

**GROSSE POINTE WOODS** 

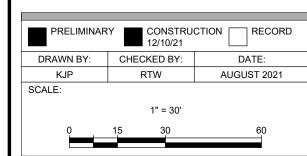

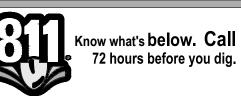

UTILITY INFORMATION, AS SHOWN, INDICATES APPROXIMATE LOCATIONS AND TYPES OF EXISTING FACILITIES ONLY, AS DISCLOSED BY RECORDS PROVIDED TO THIS FIRM FROM THE

VARIOUS UTILITY COMPANIES. NO GUARANTEE IS GIVEN OR IMPLIED AS TO THE COMPLETENESS OR ACCURACY THEREOF.

PRIOR TO CONSTRUCTION, ALL LOCATIONS AND DEPTHS OF EXISTING OVERHEAD AND UNDERGROUND UTILITIES (IN CONFLICT WITH THE CONSTRUCTION OF THESE PROPOSED IMPROVEMENTS) SHALL BE VERIFIED IN THE FIELD. DURING THE CONSTRUCTION, THE CONTRACTOR SHALL PROTECT AND SUPPORT ALL UTILITIES THAT ARE ENCOUNTERED. (ALL COSTS FOR UTILITY LOCATION VERIFICATION, SUPPORT AND PROTECTION SHALL BE INCLUDED IN THE PROPOSED PAY ITEM CONFLICTING WITH

DURING CONSTRUCTION, THE CONTRACTOR SHALL USE XTREME CAUTION WHEN OPERATING NEAR ANY AND ALL OVERHEAD AND / OR BURIED UTILITIES.

PROJECT NO.

BENCH MARK NO.5


CHESTER AVE.

TOP OF HYDRANT AT SOUTHEAST OF CORNER ALLARD AVE. AND


ELEVATION: 586.79 (NAVD 88)

0160-0433

M:\0160\0160-0433\DWG\CIVIL\00\_ENGPLANS.DWG 12\_Rem 3--12/10/2021 3:38:48 PM SHEET NO.

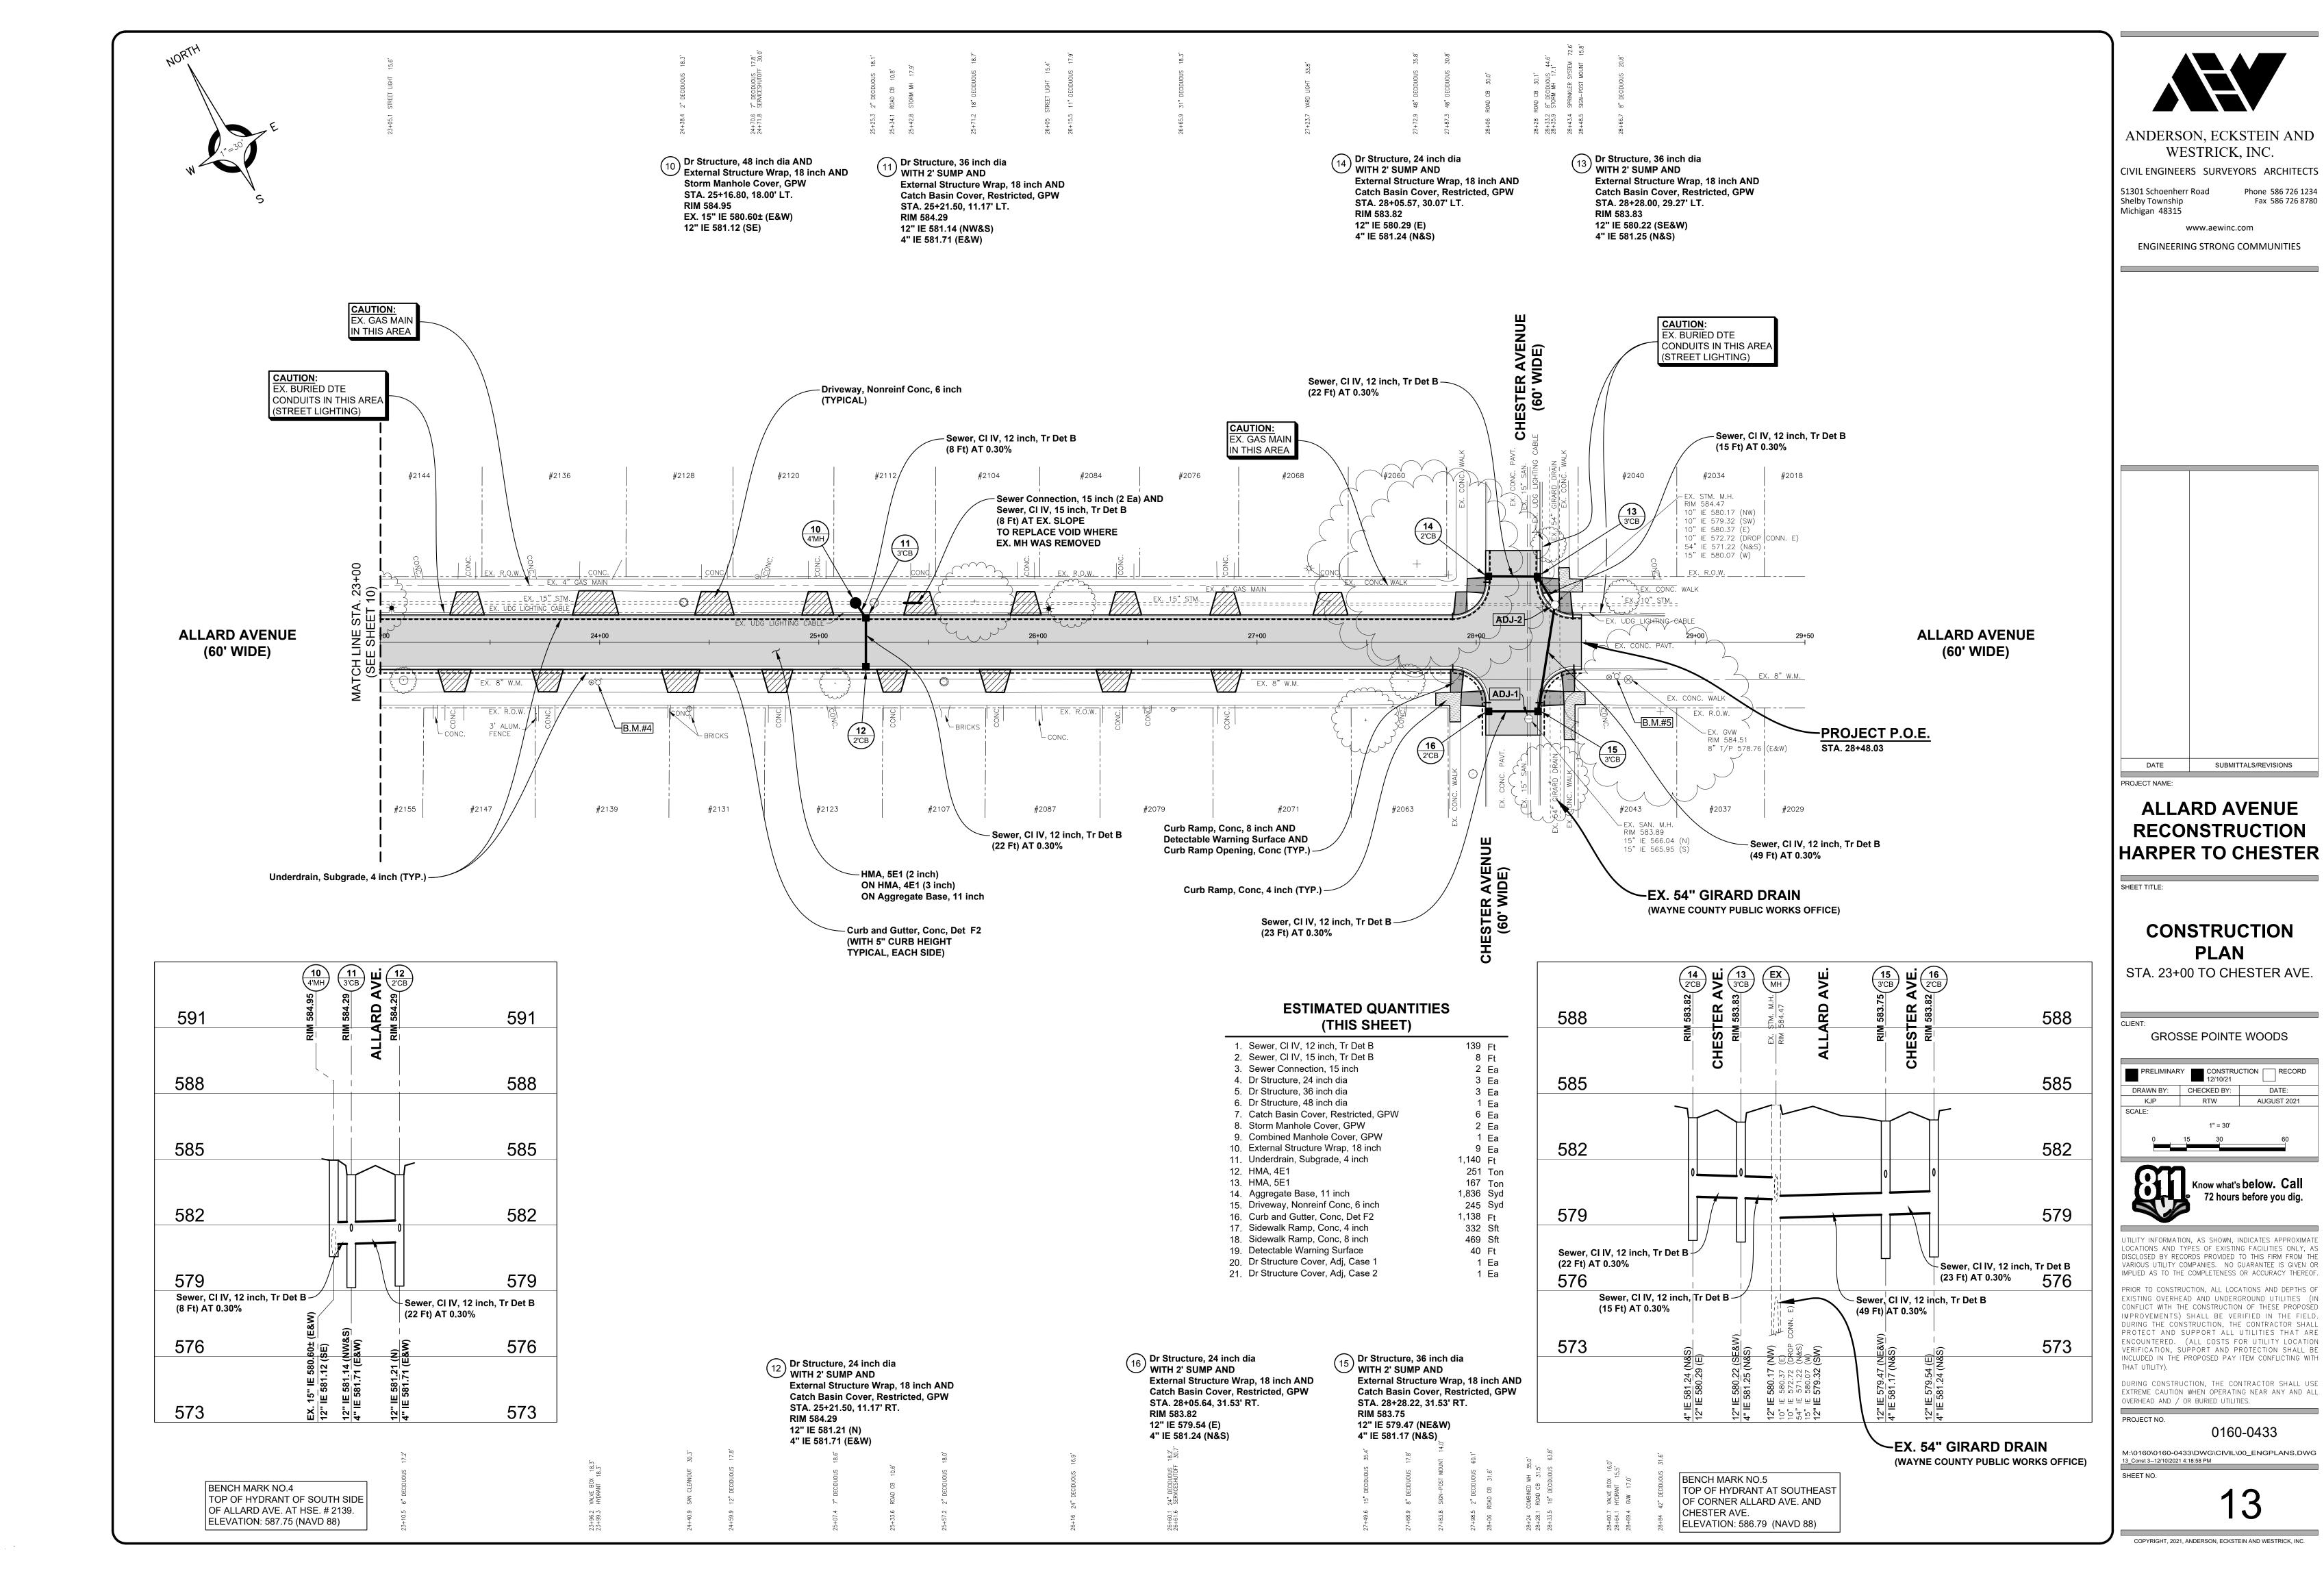



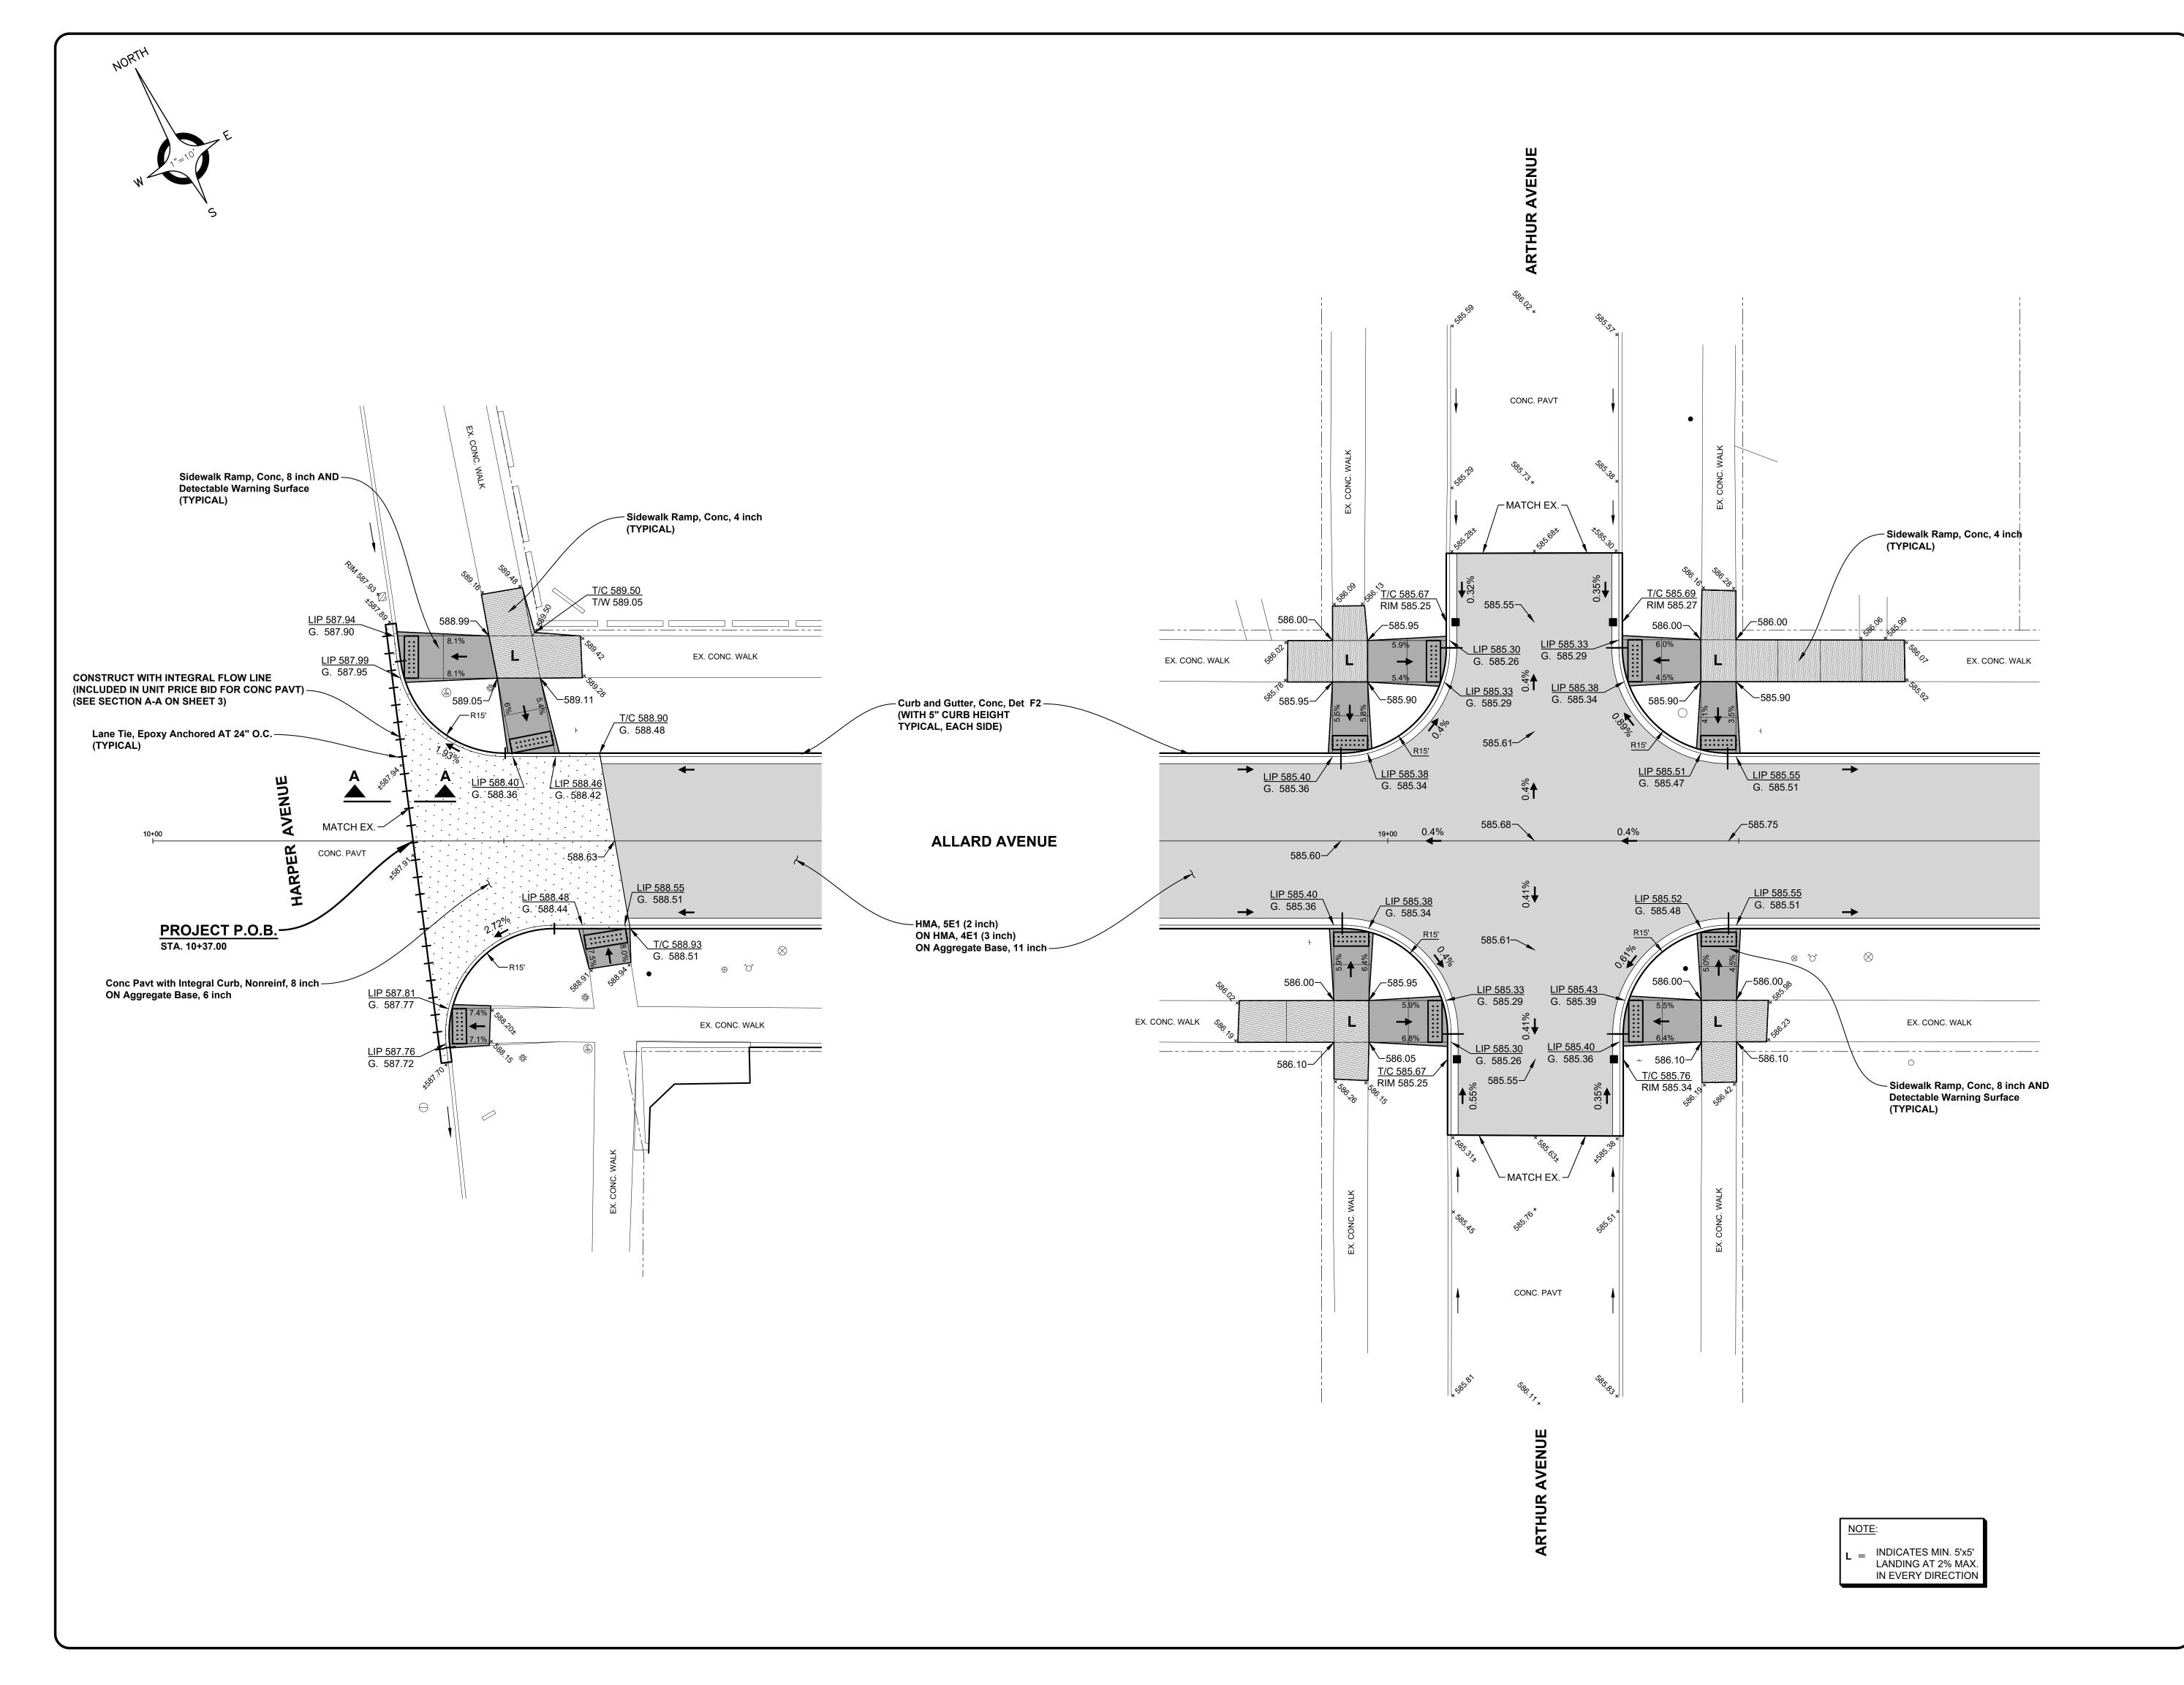




CIVIL ENGINEERS SURVEYORS ARCHITECTS

51301 Schoenherr Road Phone 586 726 1234
Shelby Township Fax 586 726 8780

Michigan 48315 www.aewinc.com

ENGINEERING STRONG COMMUNITIES

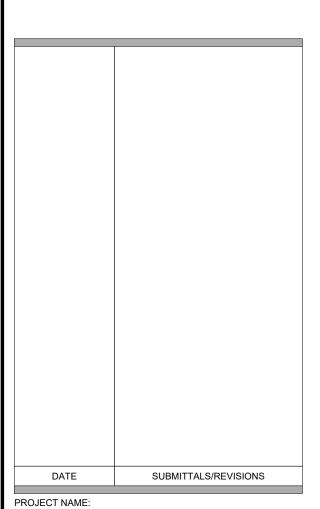



## ALLARD AVENUE RECONSTRUCTION HARPER TO CHESTER

SHEET TITLE:

INTERSECTION
GEOMETRICS &
SIDEWALK RAMP
SCHEMATICS

GROSSE POINTE WOODS

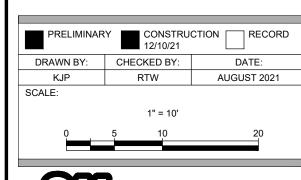

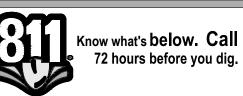

UTILITY INFORMATION, AS SHOWN, INDICATES APPROXIMATE LOCATIONS AND TYPES OF EXISTING FACILITIES ONLY, AS DISCLOSED BY RECORDS PROVIDED TO THIS FIRM FROM THE VARIOUS UTILITY COMPANIES. NO GUARANTEE IS GIVEN OR IMPLIED AS TO THE COMPLETENESS OR ACCURACY THEREOF.

PRIOR TO CONSTRUCTION, ALL LOCATIONS AND DEPTHS OF EXISTING OVERHEAD AND UNDERGROUND UTILITIES (IN CONFLICT WITH THE CONSTRUCTION OF THESE PROPOSED IMPROVEMENTS) SHALL BE VERIFIED IN THE FIELD. DURING THE CONSTRUCTION, THE CONTRACTOR SHALL PROTECT AND SUPPORT ALL UTILITIES THAT ARE ENCOUNTERED. (ALL COSTS FOR UTILITY LOCATION VERIFICATION, SUPPORT AND PROTECTION SHALL BE INCLUDED IN THE PROPOSED PAY ITEM CONFLICTING WITH


DURING CONSTRUCTION, THE CONTRACTOR SHALL USE EXTREME CAUTION WHEN OPERATING NEAR ANY AND ALL OVERHEAD AND / OR BURIED UTILITIES.


PROJECT NO.

0160-0433

M:\0160\0160-0433\DWG\CIVIL\15-16\_INT-DTL.DWG 15\_Int-Dtl 1--12/10/2021 3:40:06 PM SHEET NO.

15

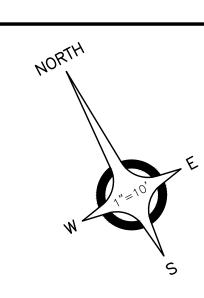

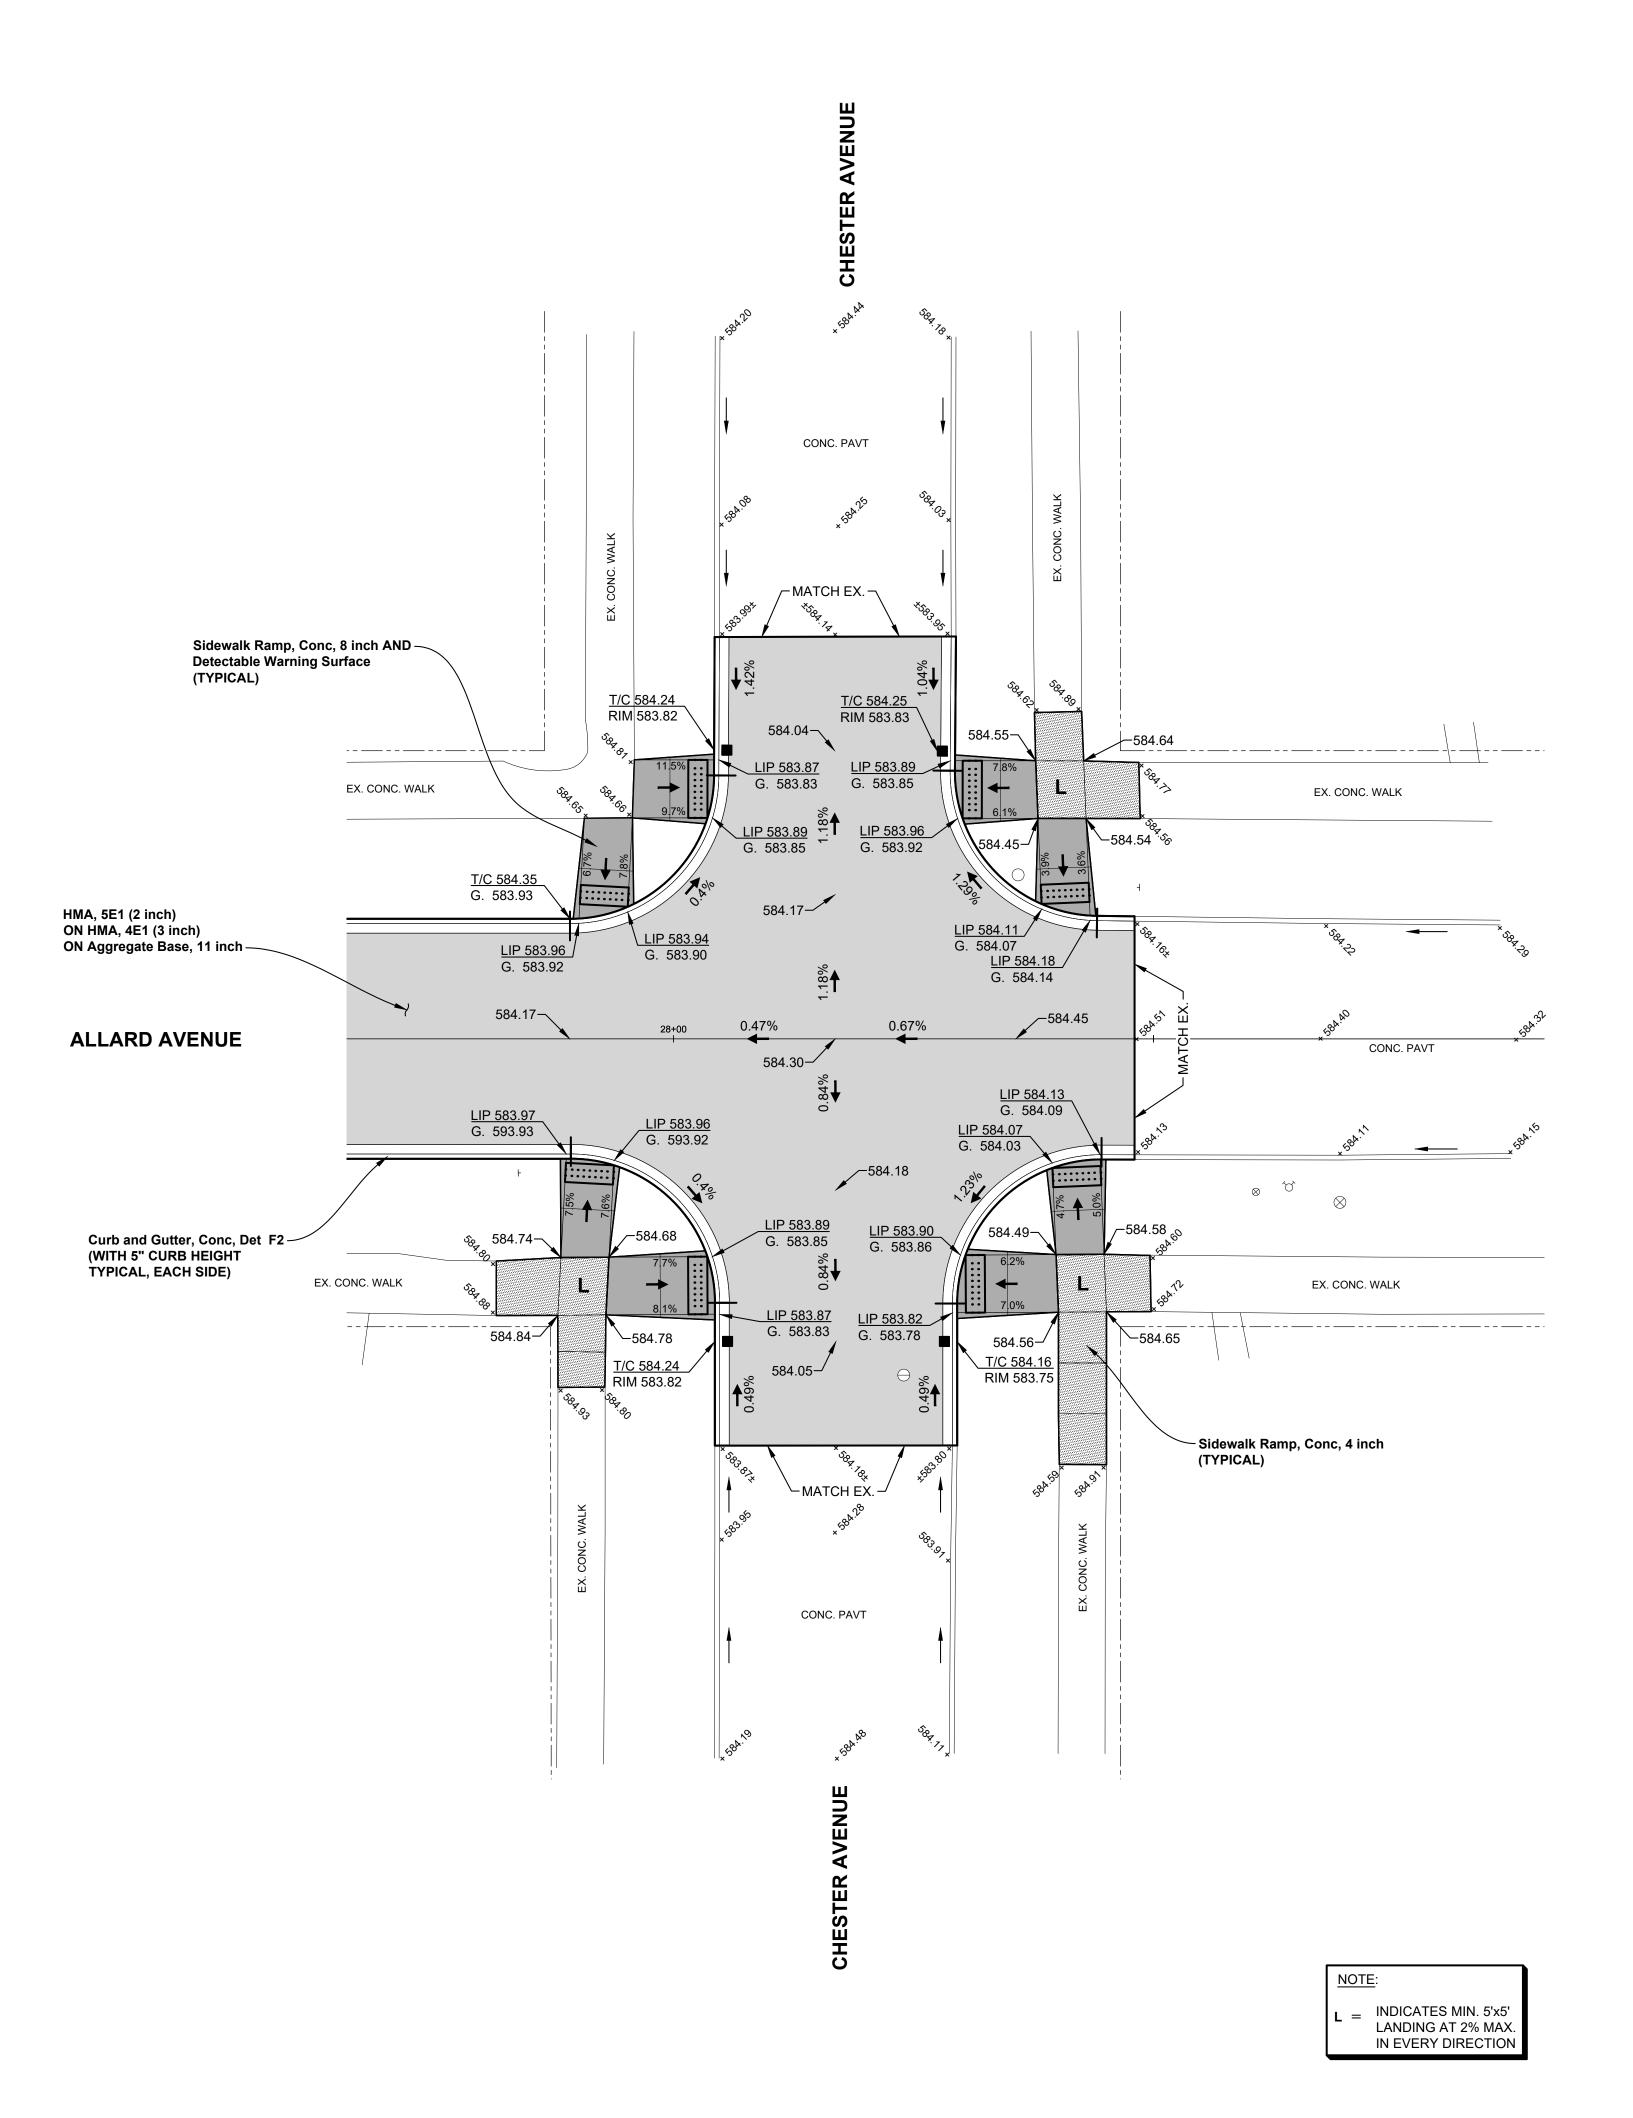



www.aewinc.com

Fax 586 726 8780

CIVIL ENGINEERS SURVEYORS ARCHITECTS
51301 Schoenherr Road Phone 586 726 1234

Shelby Township Michigan 48315

ENGINEERING STRONG COMMUNITIES

DATE SUBMITTALS/REVISIONS


PROJECT NAME:


ALLARD AVENUE
RECONSTRUCTION
HARPER TO CHESTER

SHEET TITLE:

INTERSECTION
GEOMETRICS &
SIDEWALK RAMP
SCHEMATICS

GROSSE POINTE WOODS

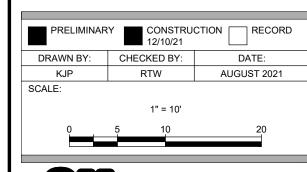

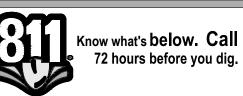

UTILITY INFORMATION, AS SHOWN, INDICATES APPROXIMATE LOCATIONS AND TYPES OF EXISTING FACILITIES ONLY, AS DISCLOSED BY RECORDS PROVIDED TO THIS FIRM FROM THE VARIOUS UTILITY COMPANIES. NO GUARANTEE IS GIVEN OR IMPLIED AS TO THE COMPLETENESS OR ACCURACY THEREOF.

PRIOR TO CONSTRUCTION, ALL LOCATIONS AND DEPTHS OF EXISTING OVERHEAD AND UNDERGROUND UTILITIES (IN CONFLICT WITH THE CONSTRUCTION OF THESE PROPOSED IMPROVEMENTS) SHALL BE VERIFIED IN THE FIELD. DURING THE CONSTRUCTION, THE CONTRACTOR SHALL PROTECT AND SUPPORT ALL UTILITIES THAT ARE ENCOUNTERED. (ALL COSTS FOR UTILITY LOCATION VERIFICATION, SUPPORT AND PROTECTION SHALL BE INCLUDED IN THE PROPOSED PAY ITEM CONFLICTING WITH


DURING CONSTRUCTION, THE CONTRACTOR SHALL USE EXTREME CAUTION WHEN OPERATING NEAR ANY AND ALL OVERHEAD AND / OR BURIED UTILITIES.

PROJECT NO.

0160-0433

M:\0160\0160-0433\DWG\CIVIL\15-16\_INT-DTL.DWG 16\_Int-Dtl 2--12/10/2021 3:40:15 PM SHEET NO.

16

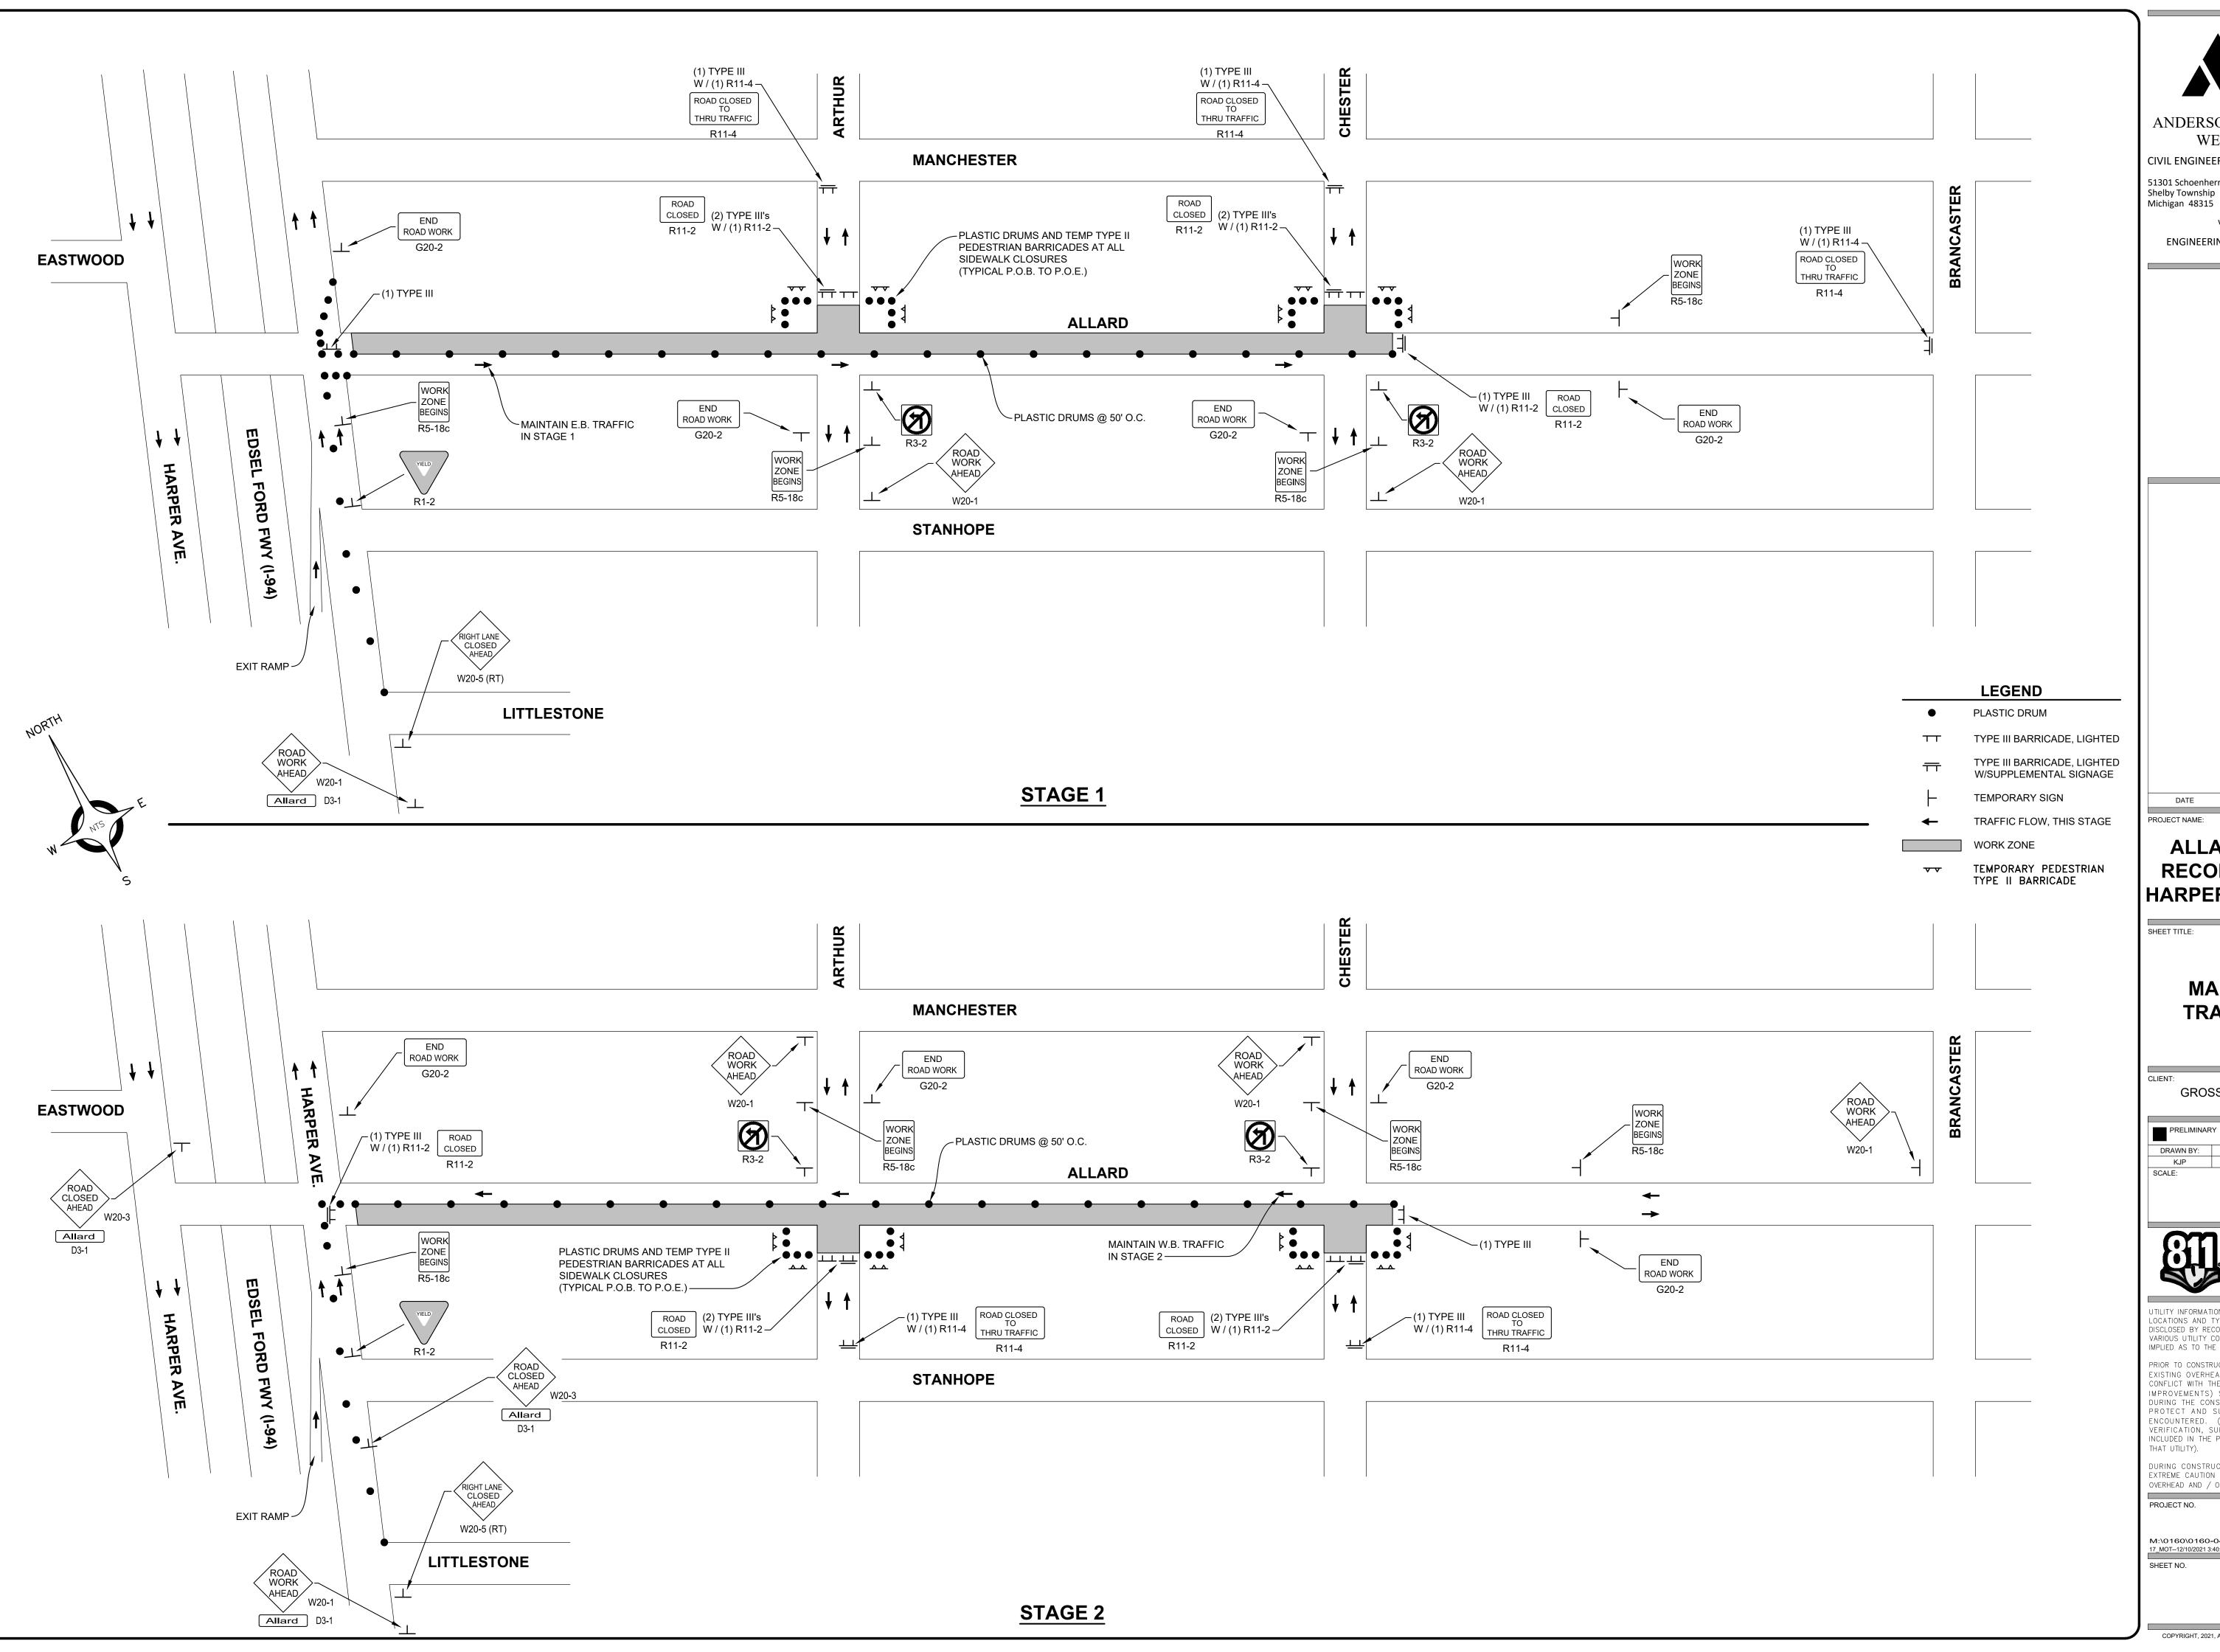



Fax 586 726 8780

CIVIL ENGINEERS SURVEYORS ARCHITECTS Phone 586 726 1234

www.aewinc.com


**ENGINEERING STRONG COMMUNITIES** 

SUBMITTALS/REVISIONS DATE PROJECT NAME: **ALLARD AVENUE RECONSTRUCTION** HARPER TO CHESTER

**MAINTAINING** TRAFFIC PLAN

**GROSSE POINTE WOODS** 

RTW AUGUST 2021 NOT TO SCALE

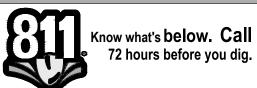

JTILITY INFORMATION, AS SHOWN, INDICATES APPROXIMATE LOCATIONS AND TYPES OF EXISTING FACILITIES ONLY, AS DISCLOSED BY RECORDS PROVIDED TO THIS FIRM FROM THE VARIOUS UTILITY COMPANIES. NO GUARANTEE IS GIVEN OR


 $\ensuremath{\mathsf{IMPLIED}}$  AS TO THE COMPLETENESS OR ACCURACY THEREOF. PRIOR TO CONSTRUCTION, ALL LOCATIONS AND DEPTHS OF EXISTING OVERHEAD AND UNDERGROUND UTILITIES (IN CONFLICT WITH THE CONSTRUCTION OF THESE PROPOSED IMPROVEMENTS) SHALL BE VERIFIED IN THE FIELD.

DURING THE CONSTRUCTION, THE CONTRACTOR SHALL PROTECT AND SUPPORT ALL UTILITIES THAT ARE ENCOUNTERED. (ALL COSTS FOR UTILITY LOCATION VERIFICATION, SUPPORT AND PROTECTION SHALL BE INCLUDED IN THE PROPOSED PAY ITEM CONFLICTING WITH

DURING CONSTRUCTION, THE CONTRACTOR SHALL USE EXTREME CAUTION WHEN OPERATING NEAR ANY AND ALL OVERHEAD AND / OR BURIED UTILITIES.

0160-0433

M:\0160\0160-0433\DWG\CIVIL\17\_MOT.DWG 17\_MOT--12/10/2021 3:40:36 PM

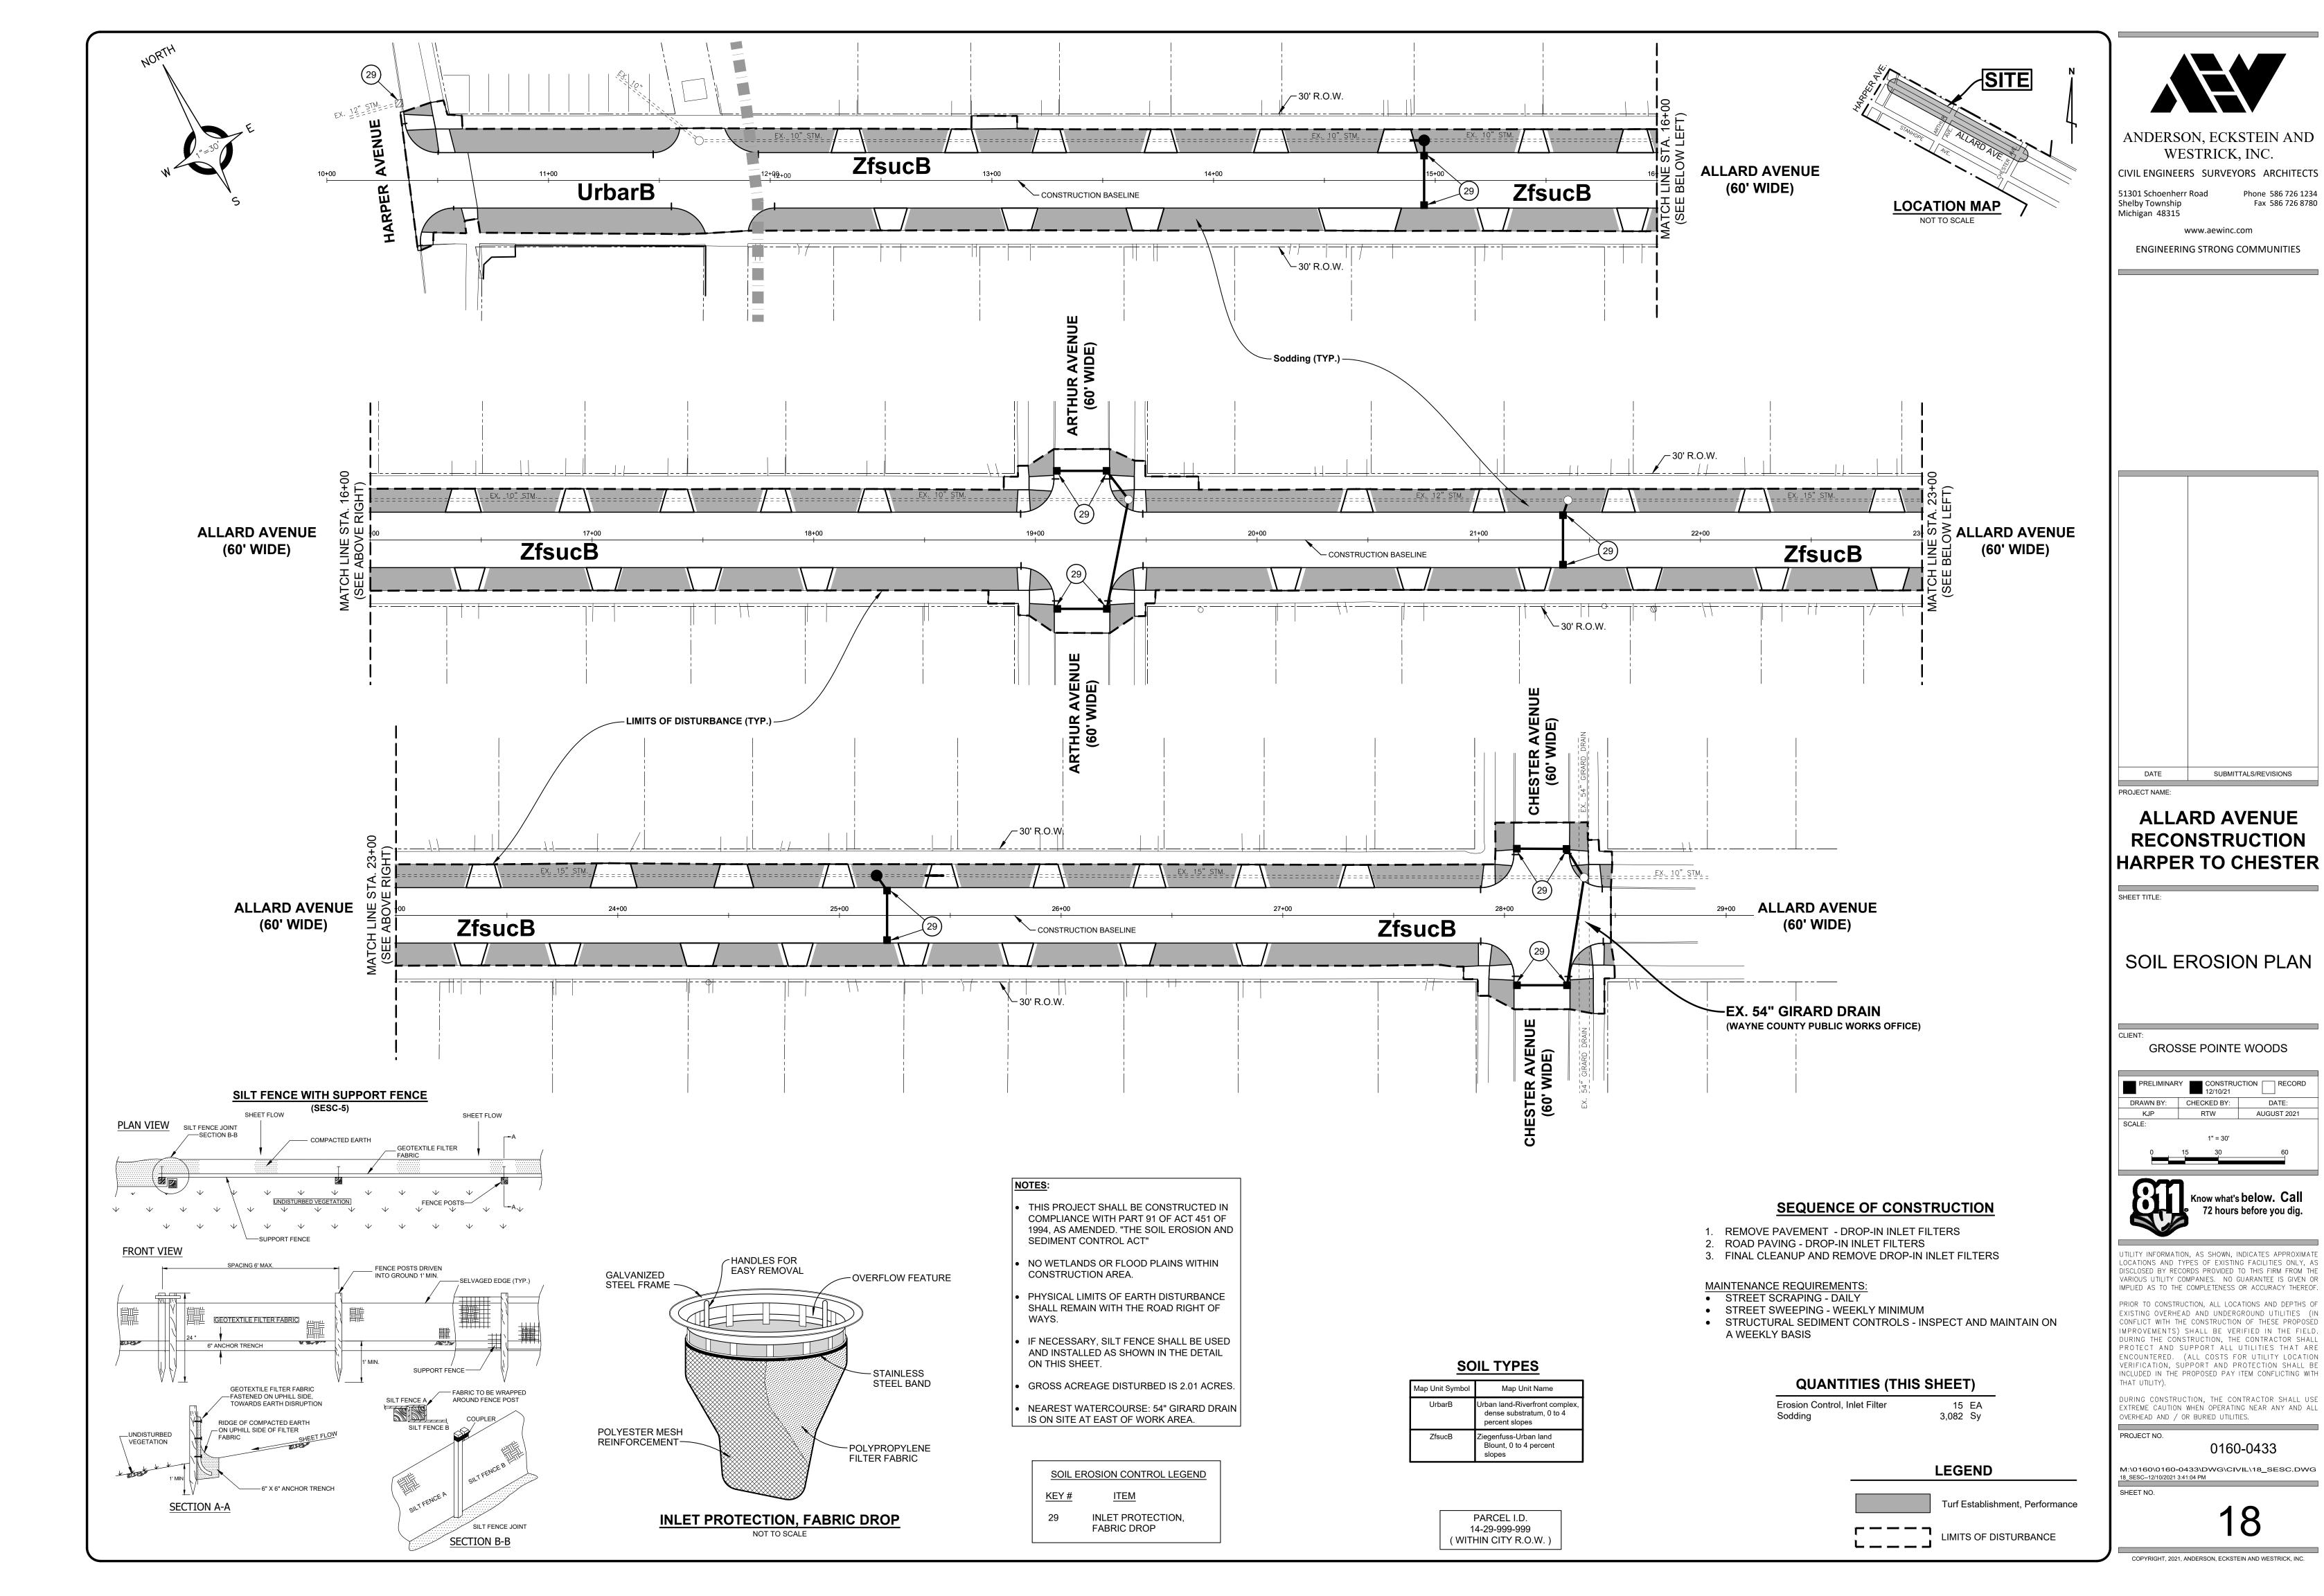



Fax 586 726 8780


AUGUST 2021





		ion: Allard Avenue, Christine Court, Hampt Road, and Roslyn Road Grosse Pointe Woods, Michigan	on	(2)	CO		NG GRO	No. A-1 DUP
	Project No tude: 42.							
Luci	tuuc. 12.	SUBSURFACE PROFILE			SO	L SAMPL	E DATA	
DEPTH ( ft)	PRO- FILE	GROUND SURFACE ELEVATION: N/A	DEPTH (ft)	SAMPLE TYPE/NO.	DCP BLOWS/ 1.75-INCHES	MOISTURE CONTENT	DRY DENSITY	UNCOF. COMP. ST.
(10)	FILE	Bituminous Concrete (3-1/2 inches)	0.3	TTTL/NO.	1.73-INCHES	(%)	(PCF)	(PSF)
		Portland Cement Concrete (8-1/2 inches)	1.0					
-		Stiff to Very Stiff Brown and Gray Silty Clay with trace sand and gravel		AS-1	10	30.6		3000*
5		End of Boring @ 5 ft	5,0 5	AS-2	13	25.8		4000*
-								
Drillir Inspe	ractor:	5 ft November 20, 2020 E. Talabo G2 Consulting Group, LLC A. Thomas	Dry Notes 235	during a : 2 Allard	oservation: nd upon con Avenue, 8' N Hand Penetr	of CL		
4-ir	ng Methoo nch diame meter har	ter diamond tipped core barrel; 3-inch	Excav	ation Bac	kfilling Proc gs and capp	edure:	ld patch	

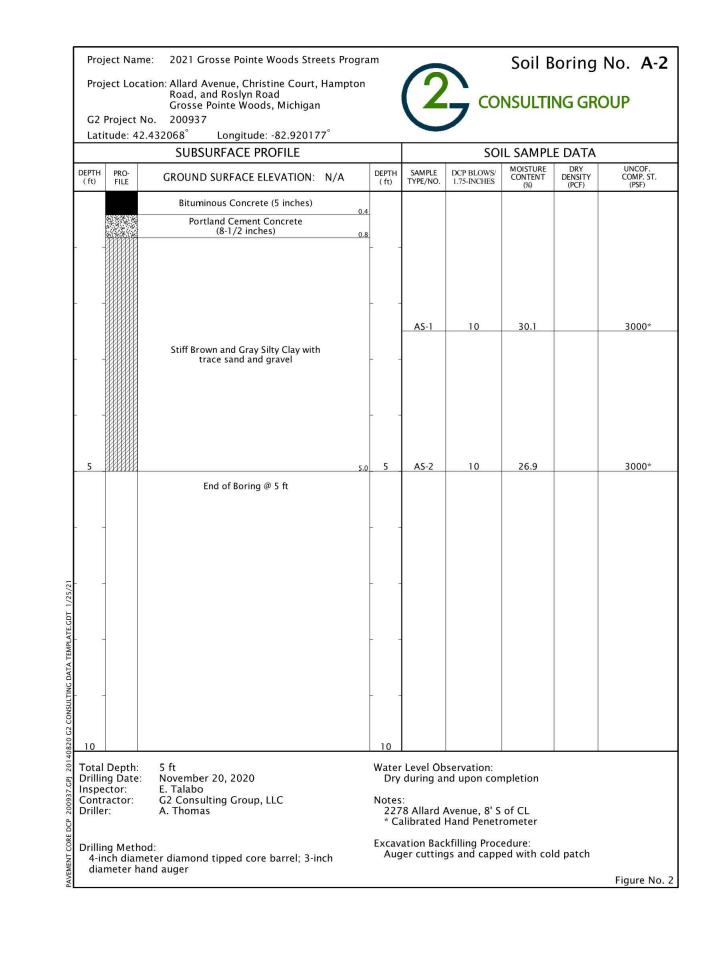

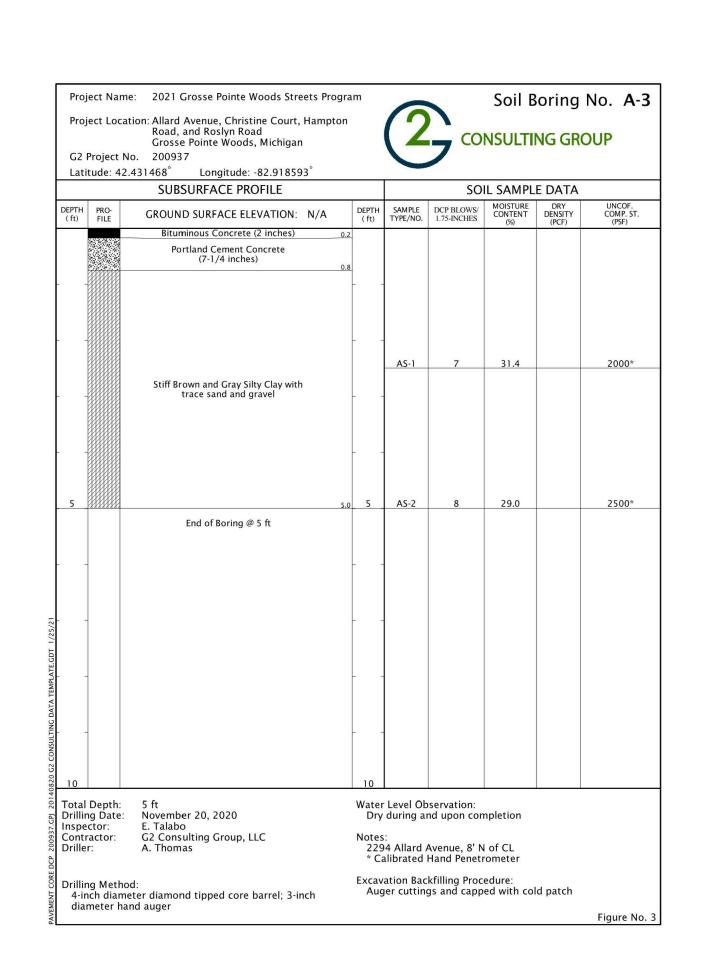

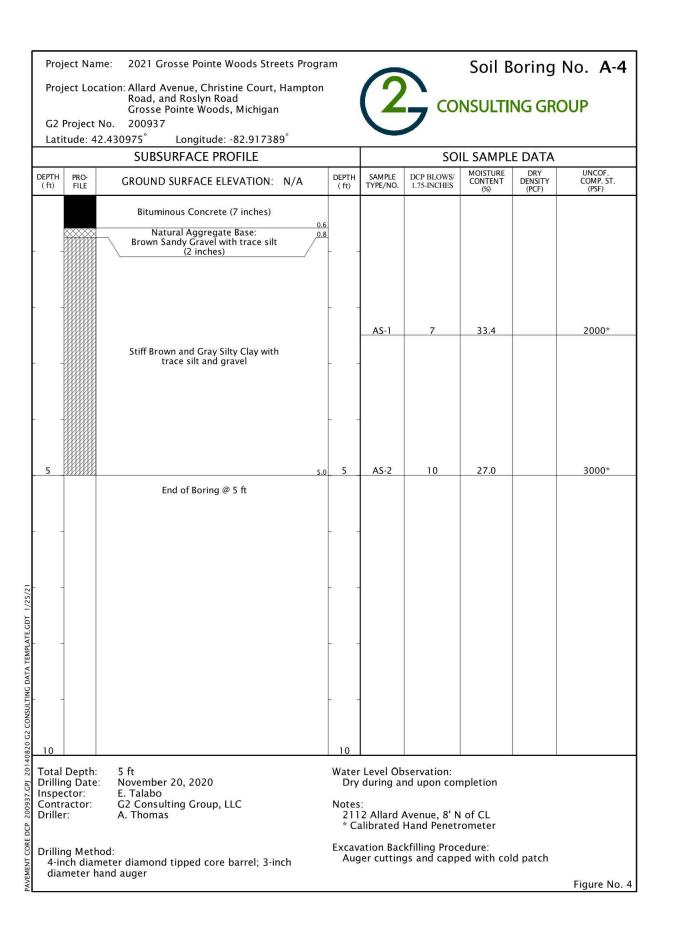

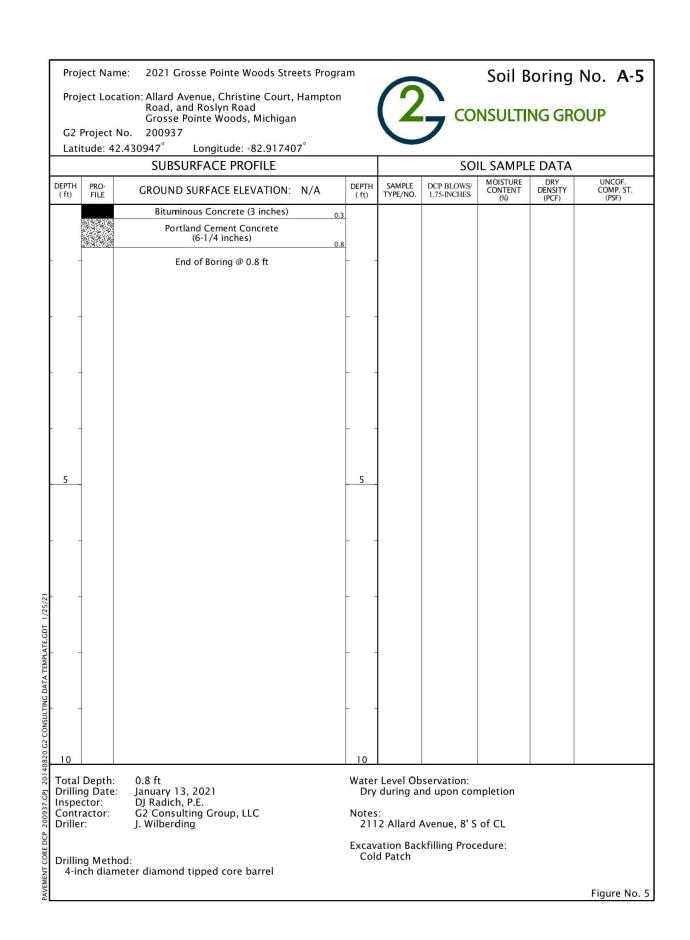

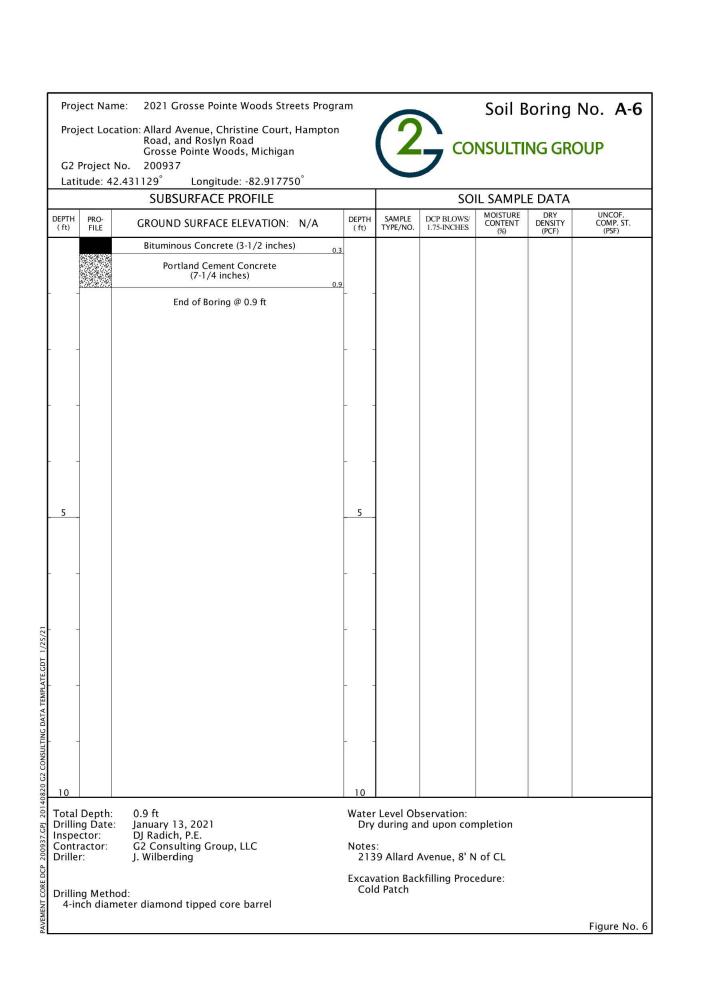



CIVIL ENGINEERS SURVEYORS ARCHITECTS

51301 Schoenherr Road Phone 586 726 1234
Shelby Township Fax 586 726 8780
Michigan 48315

www.aewinc.com

ENGINEERING STRONG COMMUNITIES

DATE SUBMITTALS/REVISIONS
PROJECT NAME:

## ALLARD AVENUE RECONSTRUCTION HARPER TO CHESTER

SHEET TITLE:

SOIL BORING LOGS

GROSSE POINTE WOODS

PRELIMINARY CONSTRUCTION RECORD
12/10/21

DRAWN BY: CHECKED BY: DATE:
KJP RTW AUGUST 2021

SCALE:
NO SCALE



UTILITY INFORMATION, AS SHOWN, INDICATES APPROXIMATE LOCATIONS AND TYPES OF EXISTING FACILITIES ONLY, AS DISCLOSED BY RECORDS PROVIDED TO THIS FIRM FROM THE VARIOUS UTILITY COMPANIES. NO GUARANTEE IS GIVEN OR IMPLIED AS TO THE COMPLETENESS OR ACCURACY THEREOF.

PRIOR TO CONSTRUCTION, ALL LOCATIONS AND DEPTHS OF EXISTING OVERHEAD AND UNDERGROUND UTILITIES (IN CONFLICT WITH THE CONSTRUCTION OF THESE PROPOSED IMPROVEMENTS) SHALL BE VERIFIED IN THE FIELD. DURING THE CONSTRUCTION, THE CONTRACTOR SHALL PROTECT AND SUPPORT ALL UTILITIES THAT ARE ENCOUNTERED. (ALL COSTS FOR UTILITY LOCATION VERIFICATION, SUPPORT AND PROTECTION SHALL BE INCLUDED IN THE PROPOSED PAY ITEM CONFLICTING WITH

DURING CONSTRUCTION, THE CONTRACTOR SHALL USE EXTREME CAUTION WHEN OPERATING NEAR ANY AND ALL OVERHEAD AND / OR BURIED UTILITIES.

PROJECT NO.

0160-0433

M:\0160\0160-0433\DWG\CIVIL\19-20\_SOILBORINGS.DWG 19\_Boring Logs--12/10/2021 3:41:14 PM SHEET NO.


19

	ect Nar	ne: 2021 Grosse Pointe Woods Streets Progr ation: Allard Avenue, Christine Court, Hampton Road, and Roslyn Road Grosse Pointe Woods, Michigan	am	<u>(2</u>	<u> </u>	Soil B	,	No. A-7
	Project	No. 200937						
Lati	tude: 4.	2.431310° Longitude: -82.918307° SUBSURFACE PROFILE		1	SO	IL SAMPL	F DATA	
DEPTH	PRO-		DEPTH	SAMPLE	DCP BLOWS/	MOISTURE CONTENT	DRY DENSITY (PCF)	UNCOF. COMP. ST.
( ft)	FILE	GROUND SURFACE ELEVATION: N/A	( ft)	TYPE/NO.	1.75-INCHES	(%)	(PCF)	(PSF)
0.00	95%	Bituminous Concrete (3-1/4 inches)  Output  Output  Description  Output						
		(6-1/4 inches)	1					
		End of Boring @ 0.8 ft	-					
5			5	-				
- :-				-				
10 Total	Depth:	0.8 ft	10 Water	Level Oh	servation:			<u> </u>
Drillir Inspe	ng Date ctor:	: January 13, 2021 DJ Radich, P.E.	Dry	during a	nd upon con	npletion		
Contr Drille	actor: r:	G2 Consulting Group, LLC J. Wilberding	Notes 216		Avenue, 8' S	of CL		
Salperi Marie -	Sept 1-20		Excav	ation Bac d Patch	kfilling Proc	edure:		
Drillir 4-ir	ng Meth nch dian	od: neter diamond tipped core barrel	Col	u raten				
								Figure No. 7

	ect Name ect Locat	ion: Allard Avenue, Christine Court, Hamptor Road. and Roslyn Road		(7)	1		Soring	
		Grosse Pointe Woods, Michigan		\ <del>_</del>	700	NSULTI	NG GRO	DUP
	roject No	o. 200937 431639° Longitude: -82.919053°						
Lucia		SUBSURFACE PROFILE			SO	IL SAMPL	E DATA	
DEPTH	PRO-	GROUND SURFACE ELEVATION: N/A	DEPTH	SAMPLE	DCP BLOWS/	MOISTURE CONTENT	DRY DENSITY	UNCOF. COMP. ST
( ft)	FILE	Pituminaus Cancrata (2.1/2 inchas)	(ft)	TYPE/NO.	1.75-INCHES	(%)	(PCF)	(PSF)
		Portland Cement Concrete	3					
		(6 inches)	8					
1		End of Boring @ 0.8 ft						
-								
-								
-			-					
5			5					
-								
-								
-			-					
10			10					
Drillin	Depth: g Date:	0.8 ft January 13, 2021	Water Dry	Water Level Observation: Dry during and upon completion				
	actor:	DJ Radich, P.E. G2 Consulting Group, LLC	Notes		A	-4.01		
Driller	•	J. Wilberding			Avenue, 8' N			
Orillin	g Method	d·	Excav Col	ation Bac d Patch	kfilling Proc	edure:		
4-in	ch diame	u: ter diamond tipped core barrel						

Proj	ect Nai	me: 2021 Grosse Pointe Woods Streets Progra	m			Soil Bo	ring N	o. <b>A-10</b>
G2 I	Project	ation: Allard Avenue, Christine Court, Hampton Road, and Roslyn Road Grosse Pointe Woods, Michigan No. 200937 2.432126° Longitude: -82.920201°		(2)			NG GRO	
Luci	caac.	SUBSURFACE PROFILE			SOI	L SAMPL	E DATA	
DEPTH (ft)	PRO- FILE	GROUND SURFACE ELEVATION: N/A	DEPTH (ft)	SAMPLE TYPE/NO.	DCP BLOWS/ 1.75-INCHES	MOISTURE CONTENT (%)	DRY DENSITY (PCF)	UNCOF. COMP. ST. (PSF)
100 100	(20000000000000000000000000000000000000	Bituminous Concrete (3-1/4 inches) 0.3	900-70-900 Y	17		(76)	(rcr)	(131)
		Portland Cement Concrete (7-1/2 inches)						
		End of Boring @ 0.9 ft						
- :-								
				÷				
- :-								
5			5					
_ 3								
10			10					
Drillir Inspe		: January 13, 2021 DJ Radich, P.E.	Dry	during a	servation: nd upon com	npletion		
Contr Drille	actor: r:	G2 Consulting Group, LLC J. Wilberding	Notes 228		Avenue, 8' N	of CL		
Drillin 4-in	ıg Meth ıch diar	nod: neter diamond tipped core barrel	Excav Col	ation Bac d Patch	kfilling Proce	edure:		
								Figure No. 10

Lati	tuae: 42.	431886° Longitude: -82.919720°  SUBSURFACE PROFILE			SO	IL SAMPL	E DATA	
DEPTH (ft)	PRO- FILE	GROUND SURFACE ELEVATION: N/A	DEPTH (ft)	SAMPLE TYPE/NO.	DCP BLOWS/ 1.75-INCHES	MOISTURE CONTENT (%)	DRY DENSITY (PCF)	UNCOF COMP. ( (PSF)
250,022		Bituminous Concrete (3-3/4 inches)	0.3	3 1102 <b>4</b> 00-20		(70)	(PCF)	(F3F)
		Portland Cement Concrete (6-1/4 inches)						
		End of Boring @ 0.8 ft	0.8					
		and or borning of old it						
- :-								
5			5					
				-				
-				-				
10			10					
Total	Depth:	0.8 ft January 13, 2021	Water		servation: nd upon cor	npletion		
Inspe Contr Drille	ctor: actor:	DJ Radich, P.E. G2 Consulting Group, LLC J. Wilberding	Notes	5:	Avenue, 8' S			
Drillir 4-ir				ation Bac d Patch	kfilling Proc	edure:		

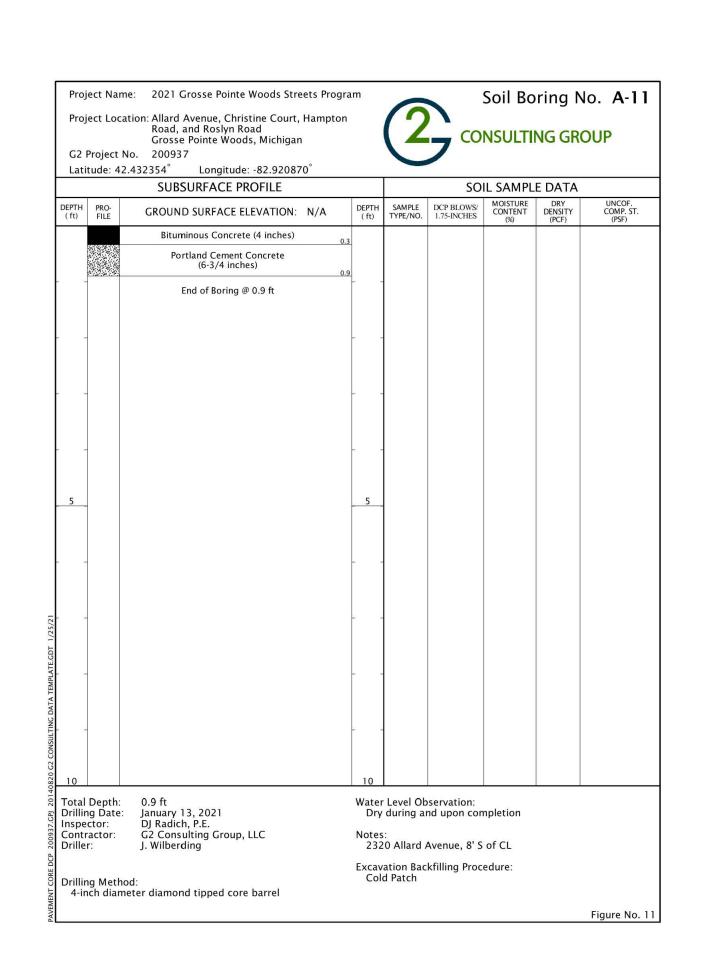




www.aewinc.com

CIVIL ENGINEERS SURVEYORS ARCHITECTS 51301 Schoenherr Road Phone 586 726 1234 Fax 586 726 8780

Shelby Township Michigan 48315

ENGINEERING STRONG COMMUNITIES

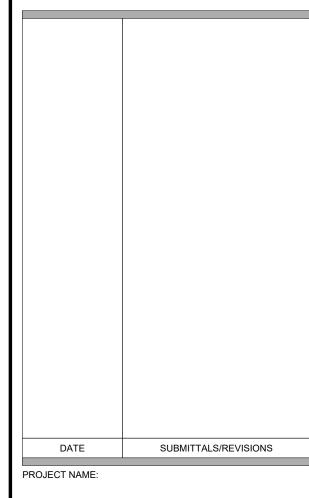

## **ALLARD AVENUE** RECONSTRUCTION HARPER TO CHESTER

SHEET TITLE:

SOIL BORING LOGS

GROSSE POINTE WOODS

PRELIMINARY CONSTRUCTION RECORD 12/10/21 DRAWN BY: CHECKED BY:

KJP RTW DATE: AUGUST 2021 NO SCALE



UTILITY INFORMATION, AS SHOWN, INDICATES APPROXIMATE LOCATIONS AND TYPES OF EXISTING FACILITIES ONLY, AS DISCLOSED BY RECORDS PROVIDED TO THIS FIRM FROM THE VARIOUS UTILITY COMPANIES. NO GUARANTEE IS GIVEN OR IMPLIED AS TO THE COMPLETENESS OR ACCURACY THEREOF.


PRIOR TO CONSTRUCTION, ALL LOCATIONS AND DEPTHS OF EXISTING OVERHEAD AND UNDERGROUND UTILITIES (IN CONFLICT WITH THE CONSTRUCTION OF THESE PROPOSED IMPROVEMENTS) SHALL BE VERIFIED IN THE FIELD.
DURING THE CONSTRUCTION, THE CONTRACTOR SHALL PROTECT AND SUPPORT ALL UTILITIES THAT ARE ENCOUNTERED. (ALL COSTS FOR UTILITY LOCATION VERIFICATION, SUPPORT AND PROTECTION SHALL BE INCLUDED IN THE PROPOSED PAY ITEM CONFLICTING WITH


DURING CONSTRUCTION, THE CONTRACTOR SHALL USE EXTREME CAUTION WHEN OPERATING NEAR ANY AND ALL OVERHEAD AND / OR BURIED UTILITIES.

0160-0433


M:\0160\0160-0433\DWG\CIVIL\19-20\_SOILBORINGS.DWG 20\_Boring Logs 2--12/10/2021 3:41:15 PM SHEET NO.

PROJECT NO.

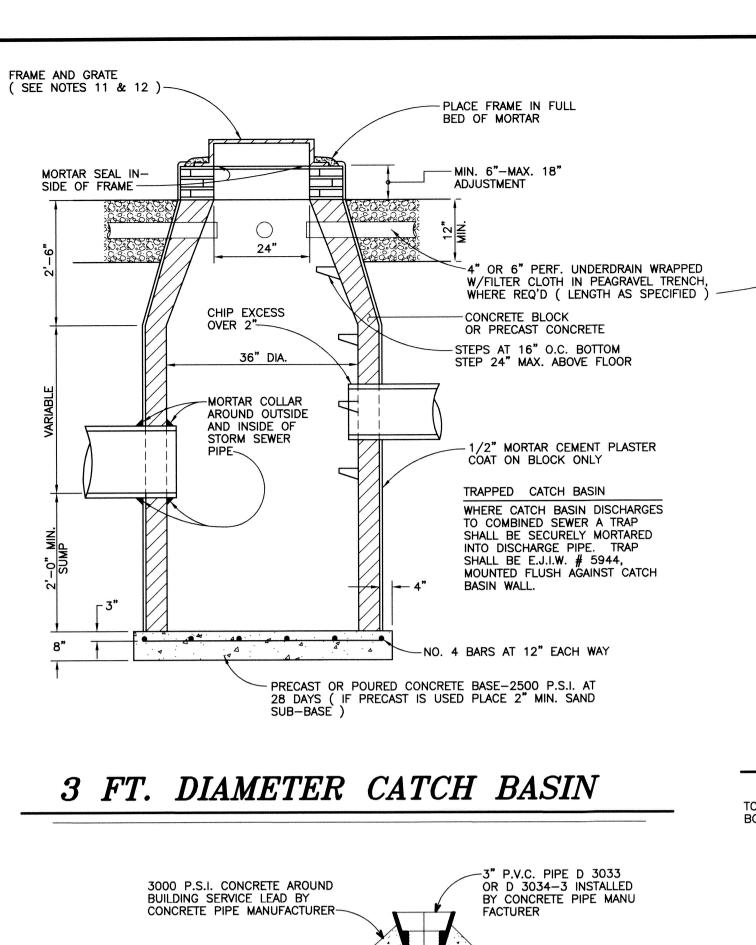

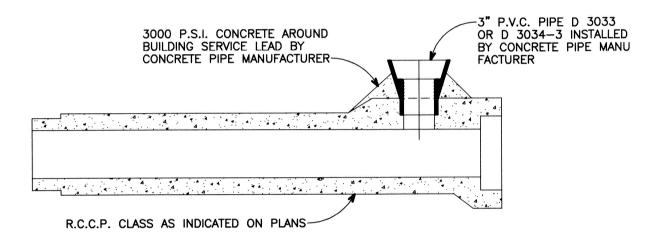


STANDARD WYE DETAIL IN CONCRETE PIPE FOR SUMP PUMP CONNECTION

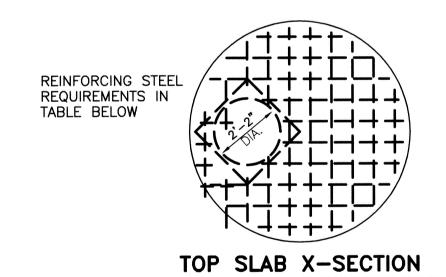

*KEAISIONS* 


*KENIZION2* 

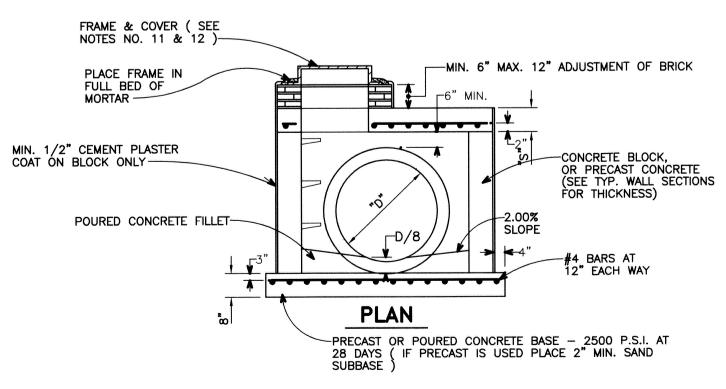

\* DIAMETER OF MANHOLE SHALL
BE INCREASED AS SHOWN ON
THE PLANS DEPENDING ON THE
A8"-54" 6 11" 7/8" 9 9" EA. WAY
7 12" 1" 9 9" EA. WAY
8 12" 1" 9 9" EA. WAY


STORM SEWER MANHOLE "A"

WITH FLAT SLAB TOP

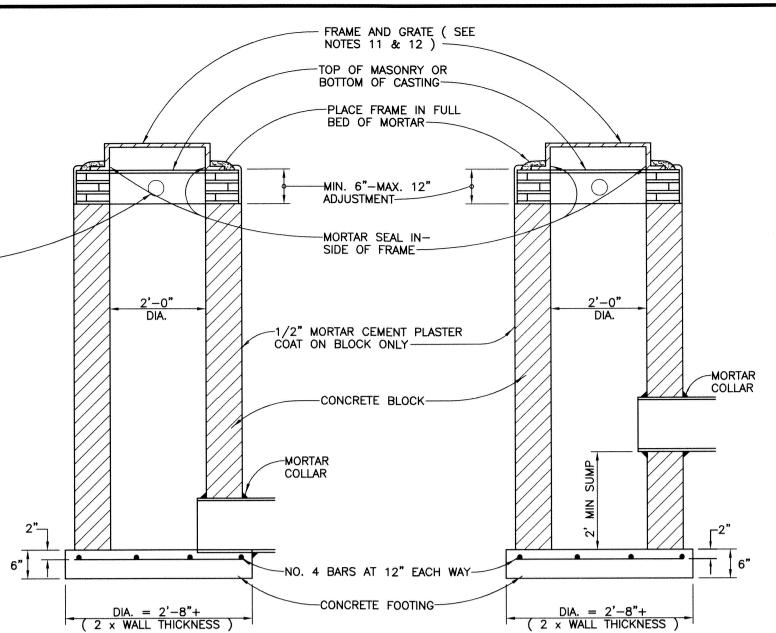


## 2 FT. DIAMETER INLET

## 2 FT. DIAMETER CATCH BASIN

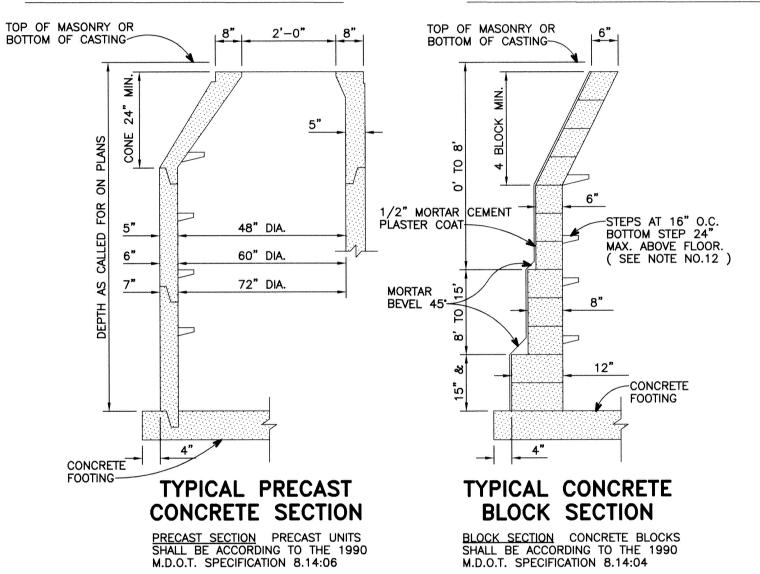

## TYPICAL WALL SECTIONS FOR ALL DRAINAGE STRUCTURES

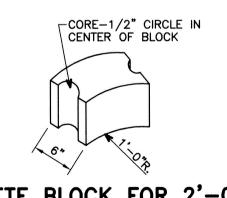


CONCRETE BLOCK FOR 2'-0"
DIAMETER DRAINAGE STRUCTURE

BACKFILL AS REQUIRED BY

UNDISTURBED EARTH-

SPECIFICATIONS-

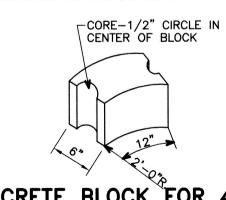

CONCRETE BLOCK FOR 4'-0"
DIAMETER DRAINAGE STRUCTURE


PEA GRAVEL OR CLASS III
SAND BACKFILL COMPACTED
TO 95% OF ITS MAX.

UNIT WEIGHT


## CONCRETE BLOCKS

4/3 INSIDE DIA. OF PIPE + 15"


STANDARD BEDDING

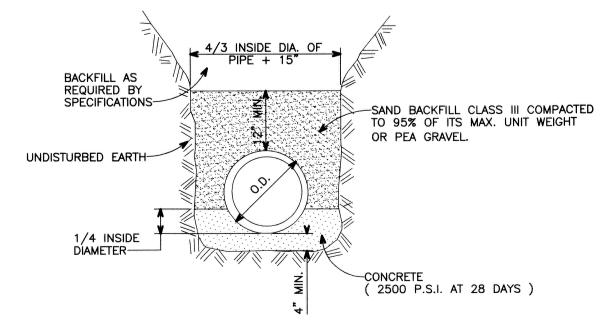

CONCRETE BEDDING

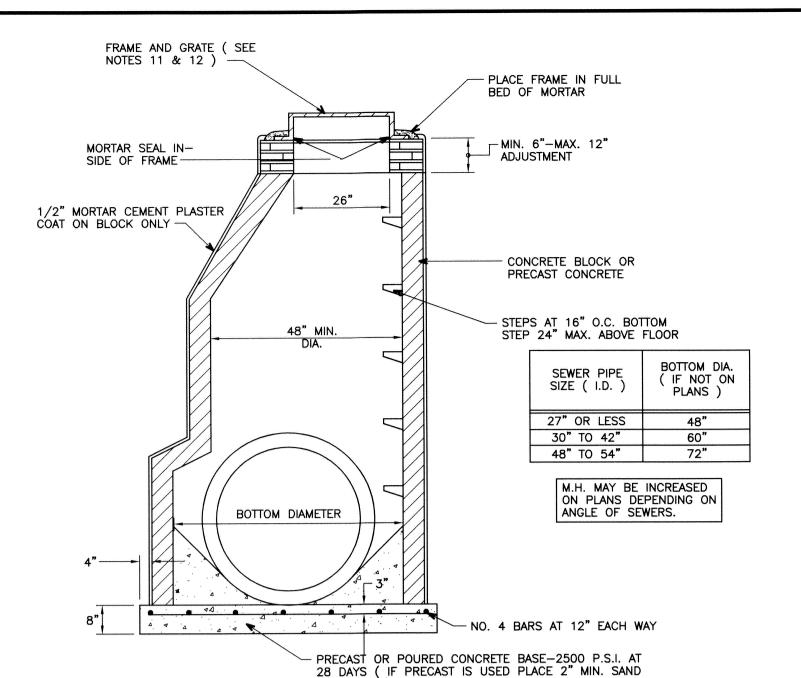

## STORM SEWER MANHOLE "A"

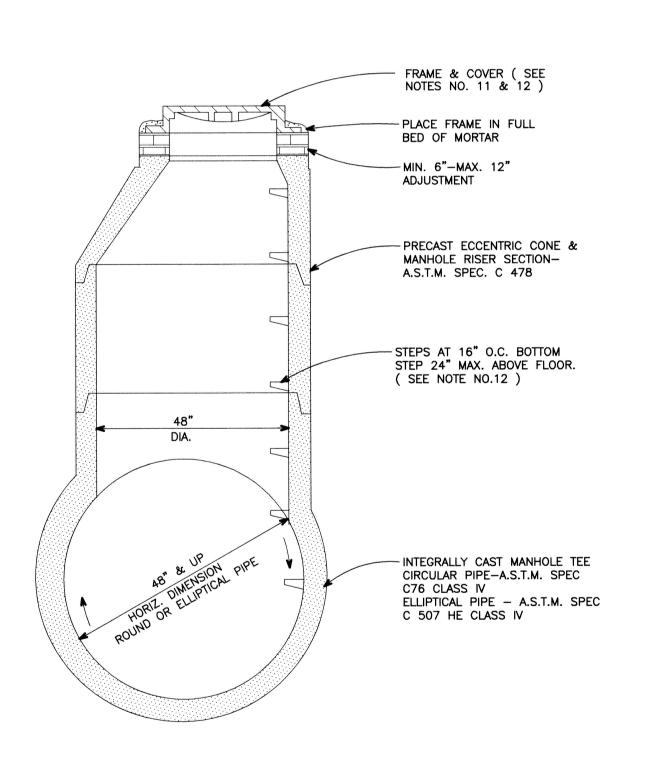


STORM SEWER TEE MANHOLE "B"

## STORM SEWER NOTES

- 1. AT LEAST SEVENTY-TWO (72) HOURS PRIOR TO CONSTRUCTION, THE CONTRACTOR SHALL GIVE NOTIFICATION OF HIS INTENTION TO BEGIN CONSTRUCTION TO THE CITY OF GROSSE POINTE WOODS ENGINEERING DEPARTMENT, THE WAYNE COUNTY PUBLIC WORKS COMMISSION OR THE ROAD COMMISSION OF WAYNE COUNTY WHEN INSPECTIONS ARE NEEDED BY THAT AGENCY.
- PRIOR TO CONSTRUCTION, THE CONTRACTOR MUST HAVE IN HIS POSSESSION A COPY OF A VALID PERMIT TO CONSTRUCT A CONNECTION TO, OR AN EXTENSION OF, THE STORM WATER DRAINAGE SYSTEM, FROM REQUIRED AGENCY ON THE JOB AT ALL TIMES OF CONSTRUCTION.
- 3. THE CONTRACTOR SHALL SECURE PERMITS FROM THE WAYNE COUNTY PUBLIC WORKS COMMISSION FOR ALL TAPS AND CROSSINGS OF COUNTY DRAINS AND SHALL PAY THE COSTS OF SAID PERMITS AND THE COST OF ANY INSPECTION CHARGES BY THAT AGENCY FOR WORK DONE UNDER THE PERMITS.
- PRIOR TO ANY CONSTRUCTION, THE CONTRACTOR SHALL TELEPHONE MISS DIG (1-800-482-7171) FOR LOCATION OF UNDERGROUND FACILITIES, AND SHALL ALSO NOTIFY REPRESENTATIVES OF ANY OTHER FACILITIES, LOCATED IN THE VICINITY OF THE WORK, WHICH MAY NOT BE HANDLED BY MISS DIG.
- 5. ALL STORM WATER DRAINAGE SYSTEM CONSTRUCTION SHALL CONFORM TO THE CURRENT STANDARDS AND SPECIFICATIONS OF THE MUNICIPALITY, COUNTY ROAD COMMISSION AND/OR COUNTY PUBLIC WORKS COMMISSION AS APPLICABLE.
- 6. ALL REINFORCED CONCRETE SEWER PIPE SHALL CONFORM TO ASTM SPECIFICATION C76 WITH CLASS DESIGNATION ON PLANS.
- 7. UNLESS OTHERWISE INDICATED ON THE PLANS, ALL STORM SEWER JOINTS SHALL BE TONGUE AND GROOVE WITH RUBBER "O" RING GASKETS.
- 3. UNLESS OTHERWISE INDICATED ON THE PLANS, ALL STORM SEWER BEDDING SHALL BE STANDARD BEDDING.
- ALL WYES AND BUILDING SERVICE CONNECTIONS SHALL BE 3" POLY VINYL CHLORIDE (PVC) SEWER PIPE SCH.40 OR SDR 23.5.
- 10. ALL STORM SEWER WYE OPENINGS SHALL BE FACTORY INSTALLED EXCEPT WHEN USING ABS TRUSS PIPE FOR SUMP PUMP DISCHARGE OUTLET. WHEREVER POSSIBLE SERVICE CONNECTIONS SHOULD DISCHARGE DIRECTLY INTO A CATCH BASIN.
- 11. UNLESS OTHERWISE NOTED ON THE PLANS, STRUCTURE FRAME AND COVERS SHALL BE AS FOLLOWS:
  - MANHOLE
    E.J.I.W. 1040 FRAME, TYPE A, SOLID COVER OR APPROVED EQUAL.
  - CATCH BASIN OR INLET ( PAVEMENT TYPE )
    E.J.I.W. 5080 FRAME, TYPE M-3 ( 2, 4 OR 6 HOLE ) RESTRICTED
    COVER OR APPROVED EQUAL.
  - CATCH BASIN ( YARD TYPE )
    E.J.I.W. 1045 FRAME, TYPE C ( 2 OR 4 SLOT ) VENTED COVER OR APPROVED EQUAL.
- 12. ALL CATCH BASIN COVERS SHALL BE RESTRICTED PER THE CITY OF GROSSE POINTE WOODS ENGINEER'S REQUIREMENTS.
- 13. STEPS TO BE INSTALLED DURING MANUFACTURING OF MANHOLE SECTION.
  STEPS MUST BE E.J.I.W. NO. 8503 M.A. INDUSTRIES P.S.I.
- POLYPROPYLENE OR APPROVED EQUAL.


  14. UNLESS OTHERWISE AUTHORIZED BY THE CITY ENGINEER, EACH STRUCTURE
- SHALL BE CONSTRUCTED TOTALLY OF EITHER PRE-CAST CONCRETE SEGMENTS OR BUILT-UP MORTAR & BLOCK.
- PRIVATE DEVELOPMENTS.

  BEFORE FINAL ACCEPTANCE, A FINAL INSPECTION MUST BE MADE BY THE OWNER AND (1) SET OF AS-BUILT SEPIA MYLARS AND (2) SETS OF BLUELINE PRINTS MUST BE SUBMITTED TO THE CITY OF GROSSE POINTE WOODS BUILDING

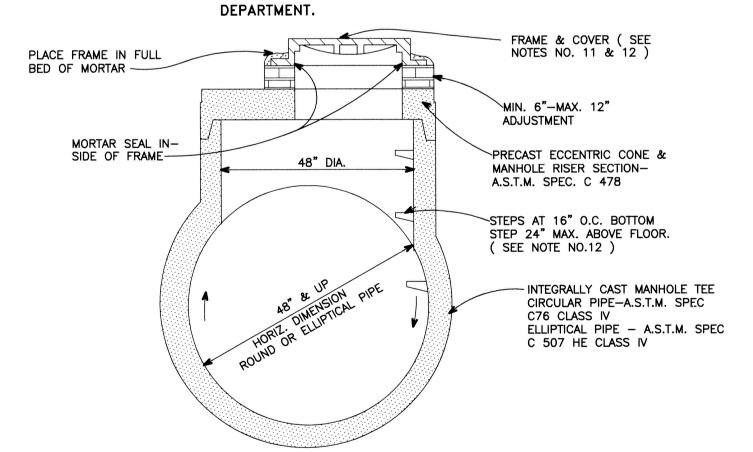

STORM SEWER TEE MANHOLE "B" WITH FLAT SLAB




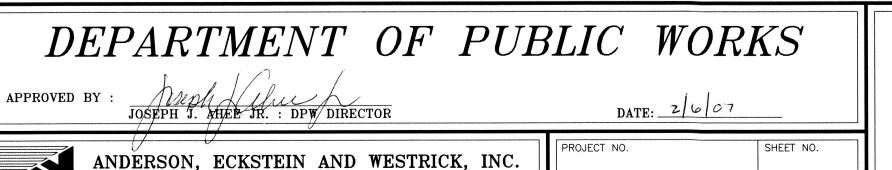

Civil Engineers • Surveyors • Architects

51301 Schoenherr Road, Shelby Township, Michigan 48315

Phone 586.726.1234 Fax 586.726.8780

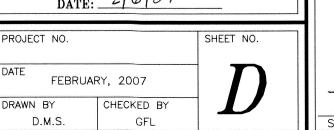

SCOTT LOCKWOOD, P.E. NO. 44355

